
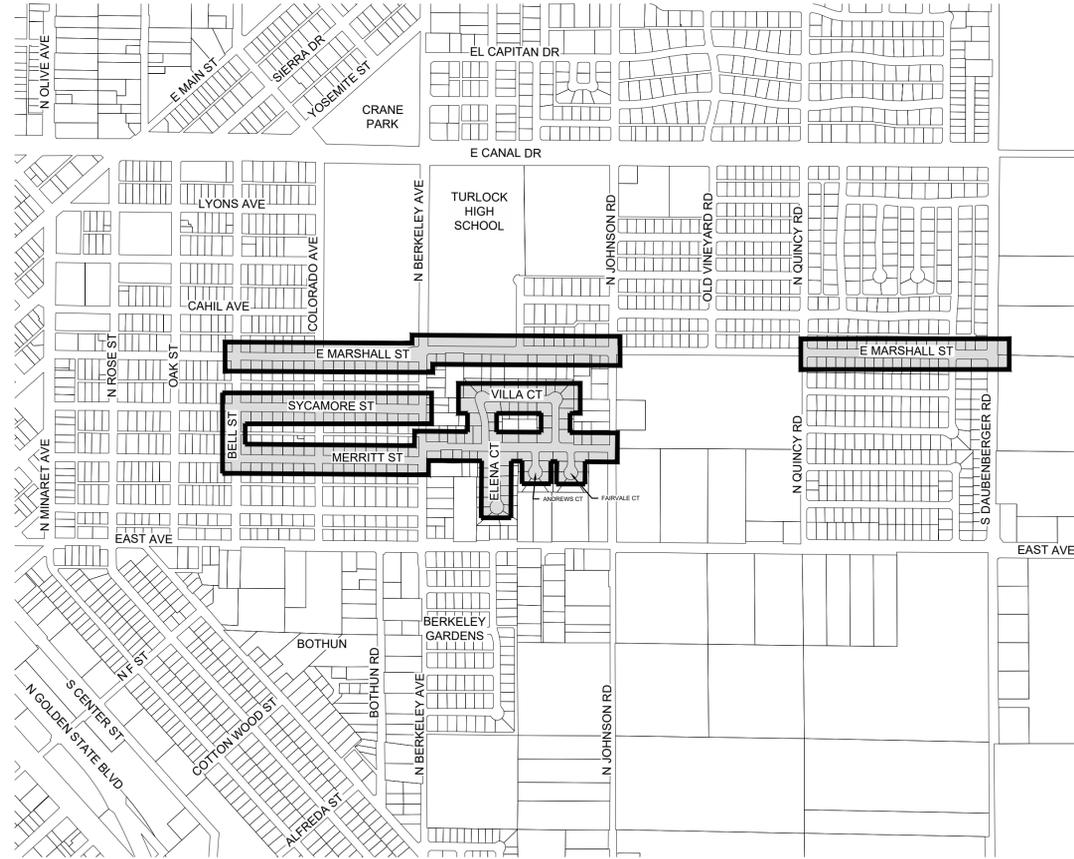


# CITY OF TURLOCK CONSTRUCTION PLANS FOR ROADS PROGRAM CAPITAL IMPROVEMENT PROJECT CITY PROJECT NO. 23-068 - PACKAGE 3

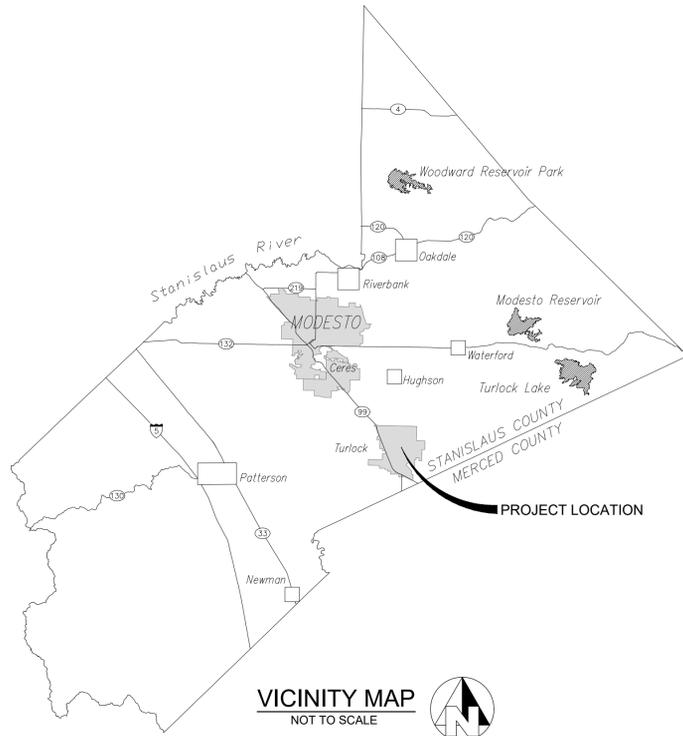

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**SPECIAL NOTE**  
WHERE UNDERGROUND AND SURFACE STRUCTURES ARE SHOWN ON THE PLANS, THE LOCATIONS, DEPTH AND DIMENSIONS OF STRUCTURES ARE BELIEVED TO BE REASONABLY CORRECT, BUT ARE NOT GUARANTEED. SUCH STRUCTURES ARE SHOWN FOR THE INFORMATION OF THE CONTRACTOR, BUT INFORMATION SO GIVEN IS NOT TO BE CONSTRUED AS A REPRESENTATION THAT SUCH STRUCTURES WILL, IN ALL CASES, BE FOUND WHERE SHOWN, OR THAT THEY REPRESENT ALL OF THE STRUCTURES WHICH MAY BE ENCOUNTERED.

**SITE SAFETY AND PROTECTION NOTES**  
THE DUTY OF THE ENGINEER, OWNER OR ITS AGENTS TO CONDUCT CONSTRUCTION REVIEW OF THE CONTRACTOR'S PERFORMANCE AND THE UNDERTAKING OF INSPECTIONS OR THE GIVING OF INSTRUCTIONS AS AUTHORIZED HEREIN IS NOT INTENDED TO INCLUDE REVIEW OF THE ADEQUACY OF THE CONTRACTOR'S SAFETY MEASURES IN, ON, OR NEAR THE CONSTRUCTION SITE AND SHALL NOT BE CONSTRUED AS SUPERVISION OF THE ACTUAL CONSTRUCTION NOR MAKE THE ENGINEER, OWNER OR ITS AGENTS RESPONSIBLE FOR PROVIDING A SAFE PLACE FOR THE PERFORMANCE OF WORK BY THE CONTRACTOR, SUBCONTRACTORS, OR SUPPLIERS, OR FOR ACCESS, VISITS, USE, WORK, TRAVEL OR OCCUPANCY BY ANY PERSON.

THE CONTRACTOR SHALL HAVE AT THE WORK SITE, COPIES OR SUITABLE EXTRACTS OF CONSTRUCTION SAFETY ORDERS, ISSUED BY CAL-OSHA. CONTRACTOR SHALL COMPLY WITH PROVISIONS OF THESE AND ALL OTHER APPLICABLE LAWS, ORDINANCES AND REGULATIONS. THE CONTRACTOR MUST COMPLY WITH PROVISIONS OF THE SAFETY AND HEALTH REGULATIONS FOR CONSTRUCTION, PROMULGATED BY THE SECRETARY OF LABOR UNDER SECTION 107 OF THE CONTRACT WORK HOURS AND SAFETY STANDARDS ACT, AS SET FORTH IN TITLE 29 C.F.R.

TO PROTECT THE LIVES AND HEALTH OF CONTRACTOR'S EMPLOYEES UNDER THE CONTRACT, THE CONTRACTOR SHALL COMPLY WITH ALL PERTINENT PROVISIONS OF THE "MANUAL OF ACCIDENT PREVENTION IN CONSTRUCTION" ISSUED BY THE ASSOCIATED GENERAL CONTRACTORS OF AMERICA, INC., AND SHALL MAINTAIN AN ACCURATE RECORD OF ALL CASES OF DEATH, OCCUPATIONAL DISEASE, AND INJURY REQUIRING MEDICAL ATTENTION OR CAUSING LOSS OF TIME FROM WORK, ARISING OUT OF AND IN THE COURSE OF EMPLOYMENT OR WORK UNDER THE CONTRACT.

THE CONTRACTOR ALONE SHALL BE RESPONSIBLE FOR THE SAFETY, EFFICIENCY, AND ADEQUACY OF CONTRACTOR'S FACILITIES, APPLIANCES, AND METHODS AND FOR ANY DAMAGE, WHICH MAY RESULT FROM THEIR FAILURE OR THEIR IMPROPER CONSTRUCTION, MAINTENANCE OR OPERATION.

THE CONTRACTOR AGREES THAT IT SHALL ASSUME SOLE AND COMPLETE RESPONSIBILITY FOR JOB SITE CONDITIONS DURING THE COURSE OF CONSTRUCTION OF THIS PROJECT, INCLUDING SAFETY OF ALL PERSONS AND PROPERTY; THAT THIS REQUIREMENT SHALL APPLY CONTINUOUSLY AND NOT BE LIMITED TO NORMAL WORKING HOURS; AND THAT THE CONTRACTOR SHALL DEFEND, INDEMNIFY AND HOLD THE OWNER, PROVOST & PRITCHARD CONSULTING GROUP, AND THEIR RESPECTIVE AGENTS HARMLESS FROM ANY AND ALL LIABILITY, REAL OR ALLEGED, IN CONNECTION WITH THE PERFORMANCE OF WORK ON THIS PROJECT, EXCEPTING FOR LIABILITY ARISING FROM THE SOLE NEGLIGENCE OF OWNER, ENGINEER, OR THEIR RESPECTIVE AGENTS.

THE OWNER AND ITS AGENTS' SITE RESPONSIBILITIES ARE LIMITED SOLELY TO THE ACTIVITIES OF THEIR EMPLOYEES ON SITE. THESE RESPONSIBILITIES SHALL NOT BE INFERRED BY ANY PARTY TO MEAN THAT THE OWNER OR ITS AGENTS HAVE RESPONSIBILITY FOR SITE SAFETY, SAFETY IN, ON, OR ABOUT THE SITE IS THE SOLE AND EXCLUSIVE RESPONSIBILITY OF THE CONTRACTOR ALONE. THE CONTRACTOR'S METHODS OF WORK PERFORMANCE, SUPERINTENDENCE AND THE CONTRACTOR'S EMPLOYEES, AND SEQUENCING OF CONSTRUCTION ARE ALSO THE SOLE AND EXCLUSIVE RESPONSIBILITIES OF THE CONTRACTOR ALONE.

**GENERAL NOTES**

- CITY OF TURLOCK (209-668-5520) SHALL BE CONTACTED AT LEAST 48 HOURS PRIOR TO COMMENCEMENT OF WORK ON OR NEAR EXISTING DISTRICT FACILITIES.
- USED MATERIAL, REJECTS, MISFITS, OR SECONDS, ETC. ARE NOT ACCEPTABLE FOR USE ON CITY OF TURLOCK FACILITIES.
- ALL CONSTRUCTION SHALL BE IN CONFORMANCE WITH THESE PLANS, PROJECT SPECIFICATIONS AND CITY OF TURLOCK SPECIFICATIONS.
- CONTRACTOR SHALL FIELD VERIFY THE HORIZONTAL AND VERTICAL LOCATIONS OF ALL EXISTING FACILITIES PRIOR TO COMMENCING WORK. CALL UNDERGROUND SERVICE ALERT (USA) AT 8-1-1. CONTRACTOR SHALL MAKE ENGINEER AWARE OF ANY DISCREPANCIES.
- ALL CAST-IN-PLACE CONCRETE STRUCTURES SHALL BE FORMED INSIDE AND OUT AND CONCRETE VIBRATED SUFFICIENTLY TO PROVIDE FOR SMOOTH SURFACED WALLS/FLOORS WITHOUT VOIDS AND HONEYCOMBS.
- CITY OF TURLOCK SHALL INSPECT ALL WORK PHASES ON CONCRETE FACILITIES FOR CONFORMANCE TO CITY OF TURLOCK SPECIFICATIONS. REINFORCING SHALL NOT BE ENCASED IN CONCRETE WITHOUT PRIOR CITY OF TURLOCK INSPECTIONS. LIKEWISE, CONCRETE SHALL NOT BE COVERED WITH EARTH PRIOR TO CITY OF TURLOCK INSPECTION.
- CONCRETE DESIGN MIX SHALL BE SUBMITTED TO THE ENGINEER FOR REVIEW AND APPROVAL. ALL CONCRETE SHALL HAVE A 28-DAY MINIMUM COMPRESSIVE STRENGTH OF 3000 PSI UNLESS OTHERWISE SPECIFIED.
- ALL STEEL PIPE AND FITTINGS SHALL BE FURNISHED WITH A SHOP APPLIED HIGH SOLIDS EPOXY COATING ON THE INTERIOR AND EXTERIOR, UNLESS OTHERWISE INDICATED. ALL OTHER EXPOSED STEEL SHALL BE PAINTED WITH A PRE-TREATMENT PRIMER, AN UNDERCOAT AND A FINAL COAT OF PAINT IN ACCORDANCE WITH CITY OF TURLOCK SPECIFICATIONS.
- ALL NUTS, BOLTS, AND WASHERS USED TO SECURE UNDERGROUND FITTINGS SHALL BE STAINLESS STEEL. AFTER INSTALLATION, ALL STEEL HARDWARE SHALL BE COATED WITH A RUST PREVENTATIVE, WRAPPED WITH 4 MIL POLYETHYLENE SHEETING, AND SECURE WITH PVC TAPE.
- ALL CONSTRUCTION SHALL BE PERFORMED IN ACCORDANCE WITH APPLICABLE HEALTH AND SAFETY LAWS OF THE STATE OF CALIFORNIA AND CAL/OSHA STANDARDS.
- TRENCH BACKFILL SHALL BE COMPACTED IN ACCORDANCE WITH CITY STANDARD SPECIFICATIONS AND THE GEOTECHNICAL REPORT CONTAINED IN THE SPECIFICATIONS.
- CONTRACTOR WILL BE RESPONSIBLE FOR THE REPAIR OF ALL PIPELINE CRACKS, WHICH DEVELOP DURING CONSTRUCTION OF IMPROVEMENTS AFFECTING EXISTING FACILITIES.
- CONCRETE VAULTS AND BOXES MAY BE PURCHASED FROM A PRECAST MANUFACTURER OR CONTRACTOR MAY CONSTRUCT THE STRUCTURES IF STRUCTURAL CALCULATIONS AND DESIGN IS APPROVED BY THE CITY OF TURLOCK AND THE ENGINEER.
- ALL EXCESS MATERIAL AND/OR DEBRIS SHALL BE REMOVED UPON COMPLETION OF INSTALLATION.
- CONTRACTOR SHALL BE RESPONSIBLE FOR PROVIDING ADEQUATE DUST CONTROL AT ALL TIMES.

APPROVALS



WILLIAM D. MORRIS, P.E., P.L.S.  
CITY ENGINEER  
MUNICIPAL SERVICES DEPARTMENT

01/21/2026  
DATE



CITY OF TURLOCK  
MUNICIPAL SERVICES DEPARTMENT  
ROADS PROGRAM DIVISION  
156 S. BROADWAY, SUITE 150  
(209) 668-5520

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**BID SET**  
1/22/2026

CITY OF TURLOCK  
ROADS PROGRAM CIP  
CITY PROJECT No. 23-068, PACKAGE 3  
GENERAL  
COVER SHEET

DESIGN ENGINEER:  
JEFF DORN  
LICENSE NO:  
76,749

DRAFTED BY: AR      CHECKED BY: JD

DATE: JAN 2026

JOB NO: 229224001

PROJECT NO: 229224001

PHASE: 3

ORIGINAL SCALE SHOWN IS ONE INCH. ADJUST SCALE FOR REDUCED OR ENLARGED PLANS.

SHEET **G1**

1 OF 78

PROVOST & PRITCHARD  
425 W. FRA AVENUE  
TURLOCK, CA 95259  
PHONE (209) 449-2700  
FAX (209) 449-2719  
www.provostandpritchard.com

1/19/2026 8:51 AM C:\Turlock\_City of 229224001\2024 Road Rehab\300 CAD\343 Sheet Set\01\_General\CIP COVER SHEET.dwg -Amenemife Eze

**GENERAL NOTES:**

- THE CONTRACTOR AGREES TO ASSUME SOLE AND COMPLETE RESPONSIBILITY FOR JOB SITE CONDITIONS DURING THE COURSE OF CONSTRUCTION OF THIS PROJECT, INCLUDING SAFETY OF ALL PERSONS AND PROPERTY; THAT THIS REQUIREMENT SHALL APPLY CONTINUOUSLY AND NOT BE LIMITED TO NORMAL WORKING HOURS; AND THAT THE CONTRACTOR SHALL DEFEND, INDEMNIFY AND HOLD THE OWNER, THE ENGINEER AND THE CITY HARMLESS FROM ANY AND ALL LIABILITY, REAL OR ALLEGED, IN CONNECTION WITH THE PERFORMANCE OF WORK ON THIS PROJECT, EXCEPTING FOR LIABILITY ARISING FROM THE SOLE NEGLIGENCE OF THE OWNER OR THE ENGINEER.
- UNLESS OTHERWISE STATED, ALL STATIONS INDICATED ON THE IMPROVEMENT PLANS ARE REFERENCED TO THE CENTER LINE OF THE STREET. ALL STATIONS ON THE CURBS ARE PERPENDICULAR TO OR RADIALLY OPPOSITE CENTER LINE STATIONS, UNLESS OTHERWISE NOTED.
- IT IS THE CONTRACTOR'S RESPONSIBILITY TO VERIFY THE LOCATION OF ALL EXISTING FACILITIES.
- THE CONTRACTOR SHALL PROVIDE ALL LIGHTS, SIGNS, BARRICADES, FLAGMEN OR OTHER DEVICES NECESSARY TO PROVIDE FOR PUBLIC SAFETY IN ACCORDANCE WITH THE CURRENT EDITION OF STATE OF CALIFORNIA, DEPARTMENT OF TRANSPORTATION, MANUAL ON UNIFORM TRAFFIC CONTROL DEVICES.
- ALL MATERIALS, WORKMANSHIP, AND CONSTRUCTION SHALL BE DONE IN ACCORDANCE WITH THE REQUIREMENTS OF THE CURRENT CITY OF TURLOCK STANDARD SPECIFICATIONS AND DRAWINGS; AND THE LATEST EDITION OF THE STATE OF CALIFORNIA, DEPARTMENT OF TRANSPORTATION, STANDARD SPECIFICATIONS. CITY OF TURLOCK STANDARD DRAWINGS ARE AVAILABLE AT THE OFFICE OF THE MUNICIPAL SERVICES DEPARTMENT.
- CONSTRUCTION STAKING AND SURVEY IS THE RESPONSIBILITY OF THE CONTRACTOR. CONSTRUCTION STAKING SHALL BE PERFORMED BY A REGISTERED SURVEYOR OR ENGINEER RETAINED AND PAID FOR BY THE CONTRACTOR. THE SURVEYOR OR ENGINEER SHALL CERTIFY ON THE FINAL CONSTRUCTION DRAWING THAT THE STAKING WAS PERFORMED ACCORDING TO THE APPROVED PLANS.
- TO SCHEDULE AN INSPECTION, THE CONTRACTOR SHALL CALL ROADS PROGRAM CONSTRUCTION INSPECTOR LEAST 24-HOURS PRIOR TO THE REQUIRED INSPECTION. THE MUNICIPAL SERVICES DEPARTMENT WILL MAKE EVERY EFFORT TO PERFORM THE INSPECTION WITHIN THE NEXT BUSINESS DAY.
- THE CITY OF TURLOCK OR ASSOCIATED UTILITY COMPANY AND RESIDENCES TO BE AFFECTED SHALL BE NOTIFIED IMMEDIATELY UPON ANY UTILITY SERVICE DISRUPTION AND A 48 HOUR NOTICE SHALL BE GIVEN FOR ANY PLANNED DISRUPTION.
- DUST SHALL BE CONTROLLED BY THE CONTRACTOR AT ALL TIMES, INCLUDING HOLIDAYS AND WEEKENDS, PER SECTION 10 OF THE STATE OF CALIFORNIA, DEPARTMENT OF TRANSPORTATION, STANDARD SPECIFICATIONS AND THE CITY OF TURLOCK STANDARD SPECIFICATIONS. WATER USED FOR DUST CONTROL AND COMPACTION MAY BE PURCHASED FROM THE APPROPRIATE AGENCY PRIOR TO THE START OF ANY WORK, AND ANY FEES OR DEPOSITS ARE THE RESPONSIBILITY OF THE CONTRACTOR. IT IS ALSO THE CONTRACTOR'S RESPONSIBILITY TO MAINTAIN CLEANLINESS OF THE EXISTING IMPROVED STREETS IN THE CONSTRUCTION AREA.
- THE CONTRACTOR IS REQUIRED TO MAINTAIN PUBLIC SAFETY AT ALL TIMES. ANY OPERATION OR SITUATION THAT THREATENS THE SAFETY OF THE WORKERS OR PUBLIC, INCLUDING IMPROPER TRAFFIC CONTROL, WILL CAUSE THE SUSPENSION OF WORK UNTIL CORRECTIONS ARE MADE AND NO ADJUSTMENTS TO WORKING DAYS WILL BE GRANTED.
- IT IS THE CONTRACTOR'S RESPONSIBILITY TO MAINTAIN A CLEAN AND SAFE WORKSITE AT ALL TIMES. IF THE CONTRACTOR FAILS TO MAINTAIN A CLEAN WORKSITE, THE CITY MAY ORDER STREET SWEEPING OR ORDER CORRECTIVE ACTION AT COST TO THE CONTRACTOR.
- MATERIALS TESTING IS THE RESPONSIBILITY OF THE CONTRACTOR AND SHALL BE COORDINATED WITH THE ENGINEER.
- STANDARD DRAWING NUMBERS SHOWN ON THE PLANS REFER TO DRAWINGS CONTAINED IN THE CITY OF TURLOCK STANDARD SPECIFICATIONS AND DRAWINGS, SHOWN THUS; (I. E. STD C-1)
- THE CONTRACTOR SHALL SECURE A TRENCH PERMIT FROM THE CALIFORNIA DEPARTMENT OF INDUSTRIAL RELATIONS, DIVISION OF OCCUPATIONAL SAFETY AND HEALTH PRIOR TO THE EXCAVATION OF ANY TRENCH OVER FIVE FEET IN DEPTH. UTILITY TRENCHING SHALL BE PERFORMED IN ACCORDANCE WITH THE TRENCHING AND COMPACTION REQUIREMENTS OF THE CITY OF TURLOCK STANDARD SPECIFICATIONS AND DRAWINGS. REFER TO STD T-1, T-2, AND T-3.
- THE CONTRACTOR SHALL VERIFY LOCATIONS OF ALL EXISTING UNDERGROUND UTILITIES AND SHALL CONTACT THE RESPECTIVE UTILITY COMPANIES PRIOR TO COMMENCEMENT OF WORK. THE CONTRACTOR SHALL BE RESPONSIBLE FOR THE LOCATION AND PRESERVATION OF ALL SUCH FACILITIES IN THE AREA OF CONSTRUCTION AND SHALL NOTIFY UNDERGROUND SERVICE ALERT OF NORTHERN CALIFORNIA FORTY-EIGHT (48) HOURS IN ADVANCE OF ANY CONSTRUCTION.
- THE CONTRACTOR SHALL BE RESPONSIBLE FOR COORDINATION OF THE REMOVAL OR RELOCATIONS OF ALL EXISTING UTILITIES WITH RESPECTIVE UTILITY COMPANIES.
- MANHOLE CASTINGS AND COVERS SHALL BE ADJUSTED TO FINAL GRADES BY THE CONTRACTOR AFTER STREET IMPROVEMENTS ARE COMPLETED. ALL EXISTING MANHOLE LIDS WITHIN LIMITS OF STREET IMPROVEMENT SHALL BE MARKED AND TIED TO SURVEY PRIOR TO ADJUSTMENT.
- FOR ALL WORK PERFORMED WITHIN PUBLIC RIGHT-OF-WAYS, THE CONTRACTOR SHALL OBTAIN AN ENCROACHMENT PERMIT, PRESERVE THE INTEGRITY AND LOCATION OF ANY AND ALL PUBLIC UTILITIES, AND PROVIDE NECESSARY CONSTRUCTION TRAFFIC CONTROL FOR STREET IMPROVEMENTS. THE CONTRACTOR SHALL, THROUGH THE ENCROACHMENT PERMIT PROCESS, VERIFY THE NEED FOR ANY DETOUR PLAN WITH THE CITY OF TURLOCK. IF A PLAN IS REQUIRED, CONTRACTOR SHALL PROVIDE PLAN AND RECEIVE APPROVAL PRIOR TO CONSTRUCTION.
- THE CONTRACTOR SHALL OBTAIN ALL PERMITS AND LICENSES REQUIRED FOR THE CONSTRUCTION AND COMPLETION OF THE PROJECT.
- THE CONTRACTOR SHALL COMPLY WITH BUSINESS AND PROFESSIONS CODE SECTION 8771(b) REGARDING REFERENCING, PRESERVING, AND RECONSTRUCTING MONUMENTS. PRESERVATION OF EXISTING MONUMENTS SHALL BE THE RESPONSIBILITY OF THE CONTRACTOR. THE CONTRACTOR SHALL NOTIFY THE ENGINEER OF ALL MONUMENTS THAT ARE DISTURBED BY CONSTRUCTION OPERATIONS. THE ENGINEER WILL TIE OFF SAID MONUMENTS AND PROVIDE THE CONTRACTOR NOTICE TO PROCEED.

**CLEARING NOTES:**

- THE CONTRACTOR IS RESPONSIBLE FOR CLEARING AND GRUBBING, PRUNING, AND REMOVING TREE ROOTS THAT INTERFERE WITH THE WORK. THE CONTRACTOR SHALL BE RESPONSIBLE FOR ENSURING THAT NO TREE ROOTS ARE PRUNED OR CUT THAT COULD COMPROMISE THE STABILITY OF THE TREE. THE CONTRACTOR SHALL RETAIN AN ARBORIST, AT THEIR OWN EXPENSE PRIOR TO BEGINNING THE WORK. THE CONTRACTOR'S ARBORIST SHALL PROVIDE A WORK PLAN THAT DESCRIBES THE METHOD OF PRUNING AND REMOVING MINOR TREE ROOTS AND BRANCHES THAT MAY BE ENCOUNTERED DURING CONSTRUCTION. THE ARBORIST WILL PROVIDE RECOMMENDATIONS FOR REVIEW BY THE CITY.

**DUST CONTROL NOTES:**

- SPRAY WATER ON ALL EXPOSED EARTH SURFACES DURING CLEARING, GRADING, EARTH MOVING AND OTHER SITE PREPARATION ACTIVITIES THROUGHOUT THE DAY TO MINIMIZE DUST. USE TARPAULINS OR OTHER EFFECTIVE COVERS ON ALL STOCKPILED EARTH MATERIAL AND ON ALL HAUL TRUCKS TO MINIMIZE DUST. SWEEP THE ADJACENT STREET FRONTAGES AT LEAST ONCE A DAY OR AS NEEDED TO REMOVE SILT AND OTHER DIRT WHICH IS EVIDENT FROM CONSTRUCTION ACTIVITIES. ENSURE THAT CONSTRUCTION VEHICLES ARE CLEANED PRIOR TO LEAVING THE SITE TO PREVENT DUST AND DIRT FROM BEING TRACKED OFF SITE.
- ALL EXPOSED SURFACES SHALL BE WATERED A MINIMUM OF TWICE DAILY, INCLUDING ON HOLIDAYS AND WEEKENDS, UNLESS DEEMED UNNECESSARY DUE TO WEATHER. WATER SHALL BE APPLIED AS PROVIDED IN SECTION 18 OF 2025 CALTRANS STANDARD SPECIFICATIONS.
- DUST PALLIATIVES MAY BE SUBSTITUTED FOR WATERING UPON THE APPROVAL OF THE ENGINEER. DUST PALLIATIVES SHALL BE APPLIED AS PROVIDED IN SECTION 18 OF CALTRANS STANDARD SPECIFICATIONS.

**STORM WATER POLLUTION PREVENTION:**

- PRIOR TO COMMENCING CONSTRUCTION, THE CONTRACTOR SHALL SUBMIT TO THE ENGINEER A COMPLETED STORM WATER POLLUTION PREVENTION PLAN (SWPPP) SIGNED AND CERTIFIED BY A QUALIFIED SSWPPP DEVELOPER (OSD). ONCE APPROVED, CONTRACTOR SHALL SUBMIT SWPPP AND NOTICE OF INTENT (NOI) WITH THE CALIFORNIA DEPARTMENT OF WATER QUALITY CONTROL BOARD. THE CONTRACTOR SHALL ADHERE TO THE SWPPP AT ALL TIMES. THE CONTRACTOR SHALL FILE THE ANNUAL REPORT WHEN THE PROJECT IS COMPLETED.

**ABBREVIATIONS**

AB	AGGREGATE BASE	PCC	PORTLAND CEMENT CONCRETE
AC	ASPHALT CONCRETE	±	PROPERTY LINE
APN	ASSESSOR'S PARCEL NUMBER	PVMT	PAVEMENT
AVE	AVENUE	R	RADIUS
BC	BEGIN CURVE	RD	ROAD
C, CONC	CONCRETE	RT, (R)	RIGHT
C&G	CURB & GUTTER	R/W	RIGHT OF WAY
CHLK	CHAIN LINK	(S)	SOUTH
CLF	CHAIN LINK FENCE	=	SLOPE
CLR	CLEAR, CLEARANCE	SD	STORM DRAIN
CNS	COMPACTED NATIVE SOIL	SDMH	STORM DRAIN MANHOLE
CY	CUBIC YARDS	SF	SQUARE FEET
DA	DRIVE APPROACH	SL	STREET LIGHT
DEMO	DEMOLISH/DEMOLITION	SNS	STREET NAME SIGN
DI	DROP INLET	SPEC	SPECIFICATION
DIA, Ø	DIAMETER	SS	SANITARY SEWER
DWY	DRIVEWAY	SSMH	SANITARY SEWER MANHOLE
DWG	DRAWING	STA	STATION
(E)	EXISTING, EAST	STD	STANDARD
EA	EACH	STRP	STRIPING
EC	END CURVE	TC	TOP OF CURB
EG	EXISTING GRADE	TCE	TEMPORARY CONSTRUCTION EASEMENT
EL, ELEV	ELEVATION	TELE	TELEPHONE
ELEC	ELECTRIC	TYP	TYPICAL
EGP	EDGE OF PAVEMENT	UG	UNDERGROUND
FG	FINISHED GRADE	UP	UTILITY POLE
FH	FIRE HYDRANT	UT	UTILITY
FL, FL	FLOW LINE	VG	VALLEY GUTTER
FT	FOOT/FEET	(W)	WEST
GB	GRADE BREAK	W	WATER
LT, (L)	LEFT	WM	WATER METER
NTS	NOT TO SCALE	WV	WATER VALVE
OH	OVERHEAD		
(P)	PROPOSED		
PB	PULL BOX		

**LINETYPES**

EXISTING	NEW	DESCRIPTION
		FENCE (CHAIN LINK)
		FENCE (WOOD)
		FENCE (WIRE)
		ELECTRIC (AERIAL)
		ELECTRIC (BURIED)
		FIBER-OPTIC
		GAS
		IRRIGATION
		OIL
		SANITARY SEWER
		SANITARY SEWER FORCE MAIN
		STORM DRAINAGE
		TELEPHONE (AERIAL)
		TELEPHONE (BURIED)
		TELEVISION (AERIAL LINE)
		TELEVISION (BURIED LINE)
		WATER
		CENTERLINE
		EASEMENT
		PROPERTY LINE
		RIGHT-OF-WAY
		SECTION LINE
		SAWCUT LINE

**SYMBOLS**

EXISTING	NEW	DESCRIPTION
		UTILITY POLE
		SANITARY SEWER MANHOLE
		STORM DRAIN INLET
		STORM DRAIN MANHOLE
		MAIL BOX
		SIGN
		YARD LIGHT
		2-NOZZLE HYDRANT
		WATER METER
		WATER VALVE
		FENCE POST
		UTILITY ELECTIC SYSTEM
		REVISION
		CONSTRUCTION CALLOUT
		DETAIL CALLOUT
		SPOT ELEVATION

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**BID SET**  
 1/22/2026




CITY OF TURLOCK  
 ROADS PROGRAM CIP  
 CITY PROJECT No. 23-068, PACKAGE 3  
 GENERAL  
**LEGEND & ABBREVIATIONS**

**PROVOST & PRITCHARD**  
 425 W. FIR AVENUE  
 TURLOCK, CA 95259  
 PHONE (559) 448-2700  
 FAX (559) 448-2715  
 www.provostandpritchard.com


DESIGN ENGINEER: JEFF DORN	
LICENSE NO: 76,749	
DRAFTED BY: AR	CHECKED BY: JD
DATE: JAN 2026	
JOB NO: 229224001	
PROJECT NO: 229224001	
PHASE: 3	
0' = 1"	
ORIGINAL SCALE SHOWN IS ONE INCH. ADJUST SCALE FOR REDUCED OR ENLARGED PLANS.	
SHEET <b>G2</b>	
2	OF 78



CITY OF TURLOCK  
 MUNICIPAL SERVICES DEPARTMENT  
 ROADS PROGRAM DIVISION  
 156 S. BROADWAY, SUITE 150  
 (209) 668-5520

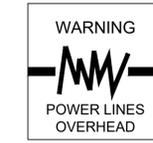


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POINT TABLE				
POINT #	NORTHING	EASTING	ELEVATION	DESCRIPTION
52	2003355.57	6464397.49	103.65	FD IP
53	2002995.57	6464395.36	104.89	FD IP
54	2002635.48	6464393.31	104.38	FD IP
55	2002630.31	6464977.21	105.74	FD IP
56	2002990.44	6464980.32	105.48	FD IP
57	2003350.27	6464982.42	105.17	FD IP
58	2003013.35	6465684.33	105.36	FD IP
59	2002954.00	6465684.94	105.18	FD IP
60	2002654.26	6465682.72	105.59	FD IP
61	2003314.40	6465686.62	105.81	FD IP
62	2003373.51	6465812.59	106.04	FD IP
63	2003392.77	6467060.46	106.95	FD IP
64	2003379.98	6468405.21	107.88	FD IP
65	2003368.15	6469457.17	109.12	FD IP
66	2003364.84	6469750.79	110.08	FD IP
81005	2002929.99	6466122.35	105.78	FD IP
81006	2002853.26	6466624.92	106.94	FD IP
81007	2002722.80	6466226.90	105.66	FD IP
81008	2002567.79	6466226.17	105.05	FD IP
81009	2002506.76	6466232.94	105.14	FD IP
81010	2002445.59	6466239.67	105.13	FD IP
81011	2002294.07	6466238.99	105.59	FD IP
81012	2002717.35	6467057.76	108.38	FD IP
81013	2002674.46	6466736.85	106.65	FD IP
81014	2002539.59	6466711.27	106.54	FD 5/8" REBAR NO
81015	2002675.80	6466535.65	105.60	FD IP

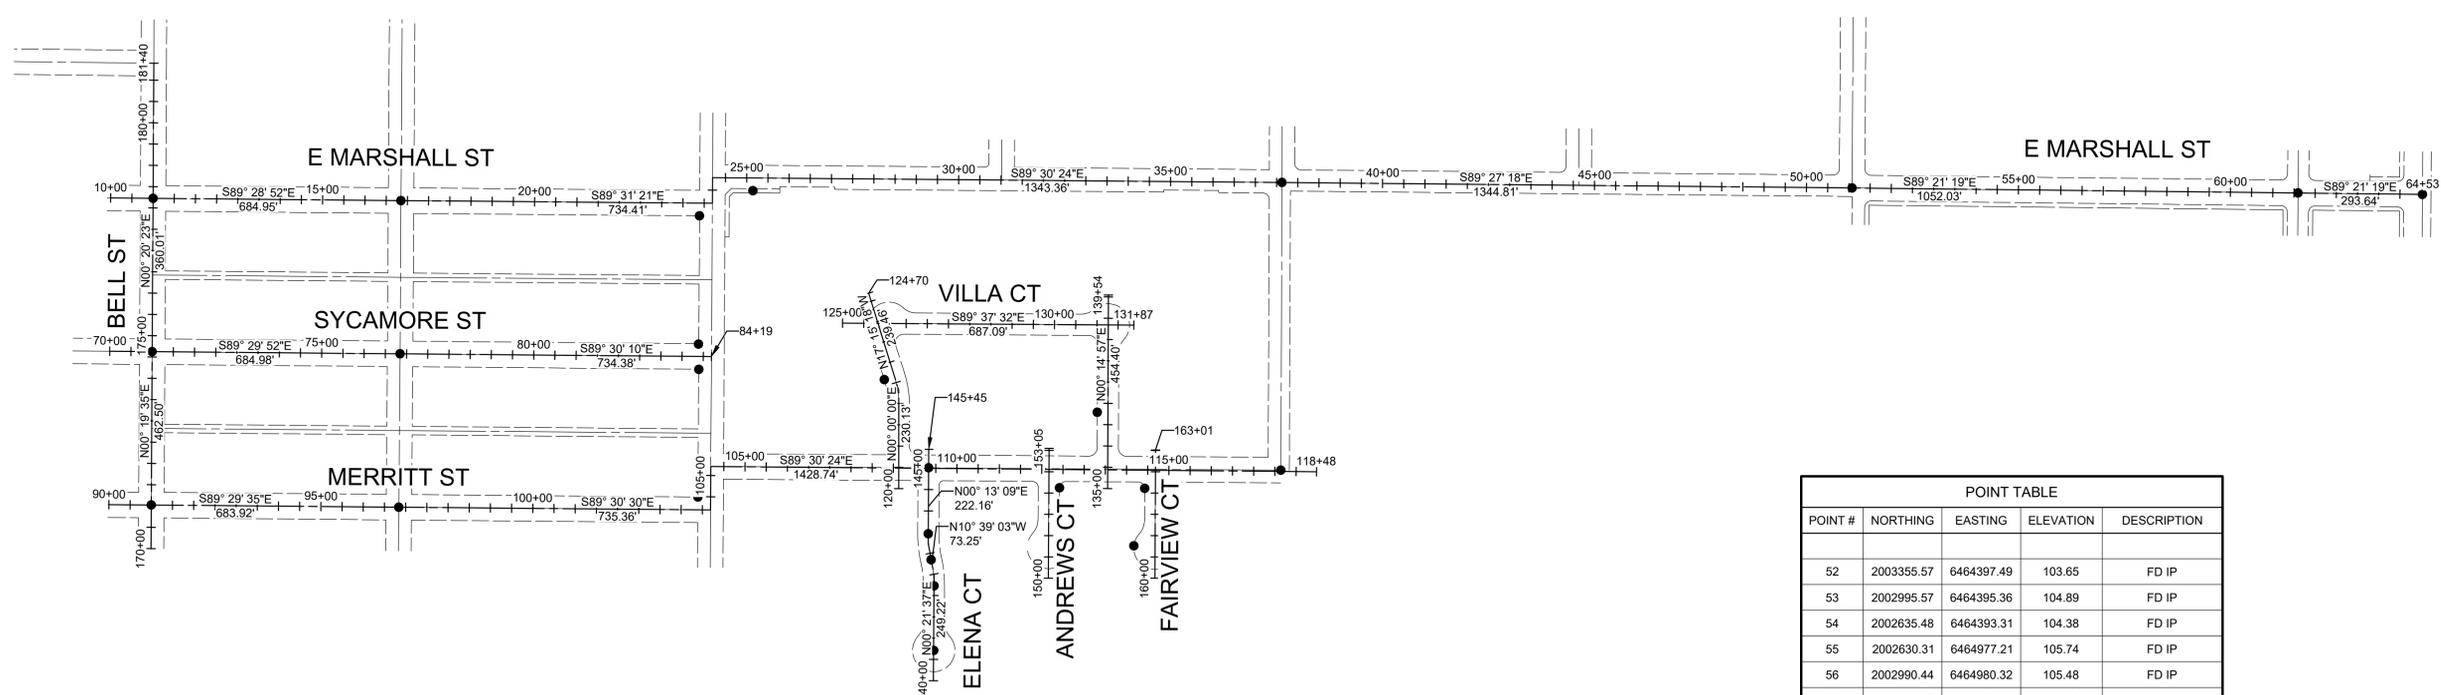NO.	REVISION	BY	DATE
	BID SET		1/22/2026



CITY OF TURLOCK  
ROADS PROGRAM CIP  
CITY PROJECT No. 23-068, PACKAGE 3  
GENERAL  
CONTROL POINTS
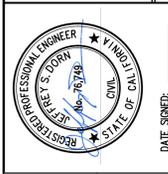
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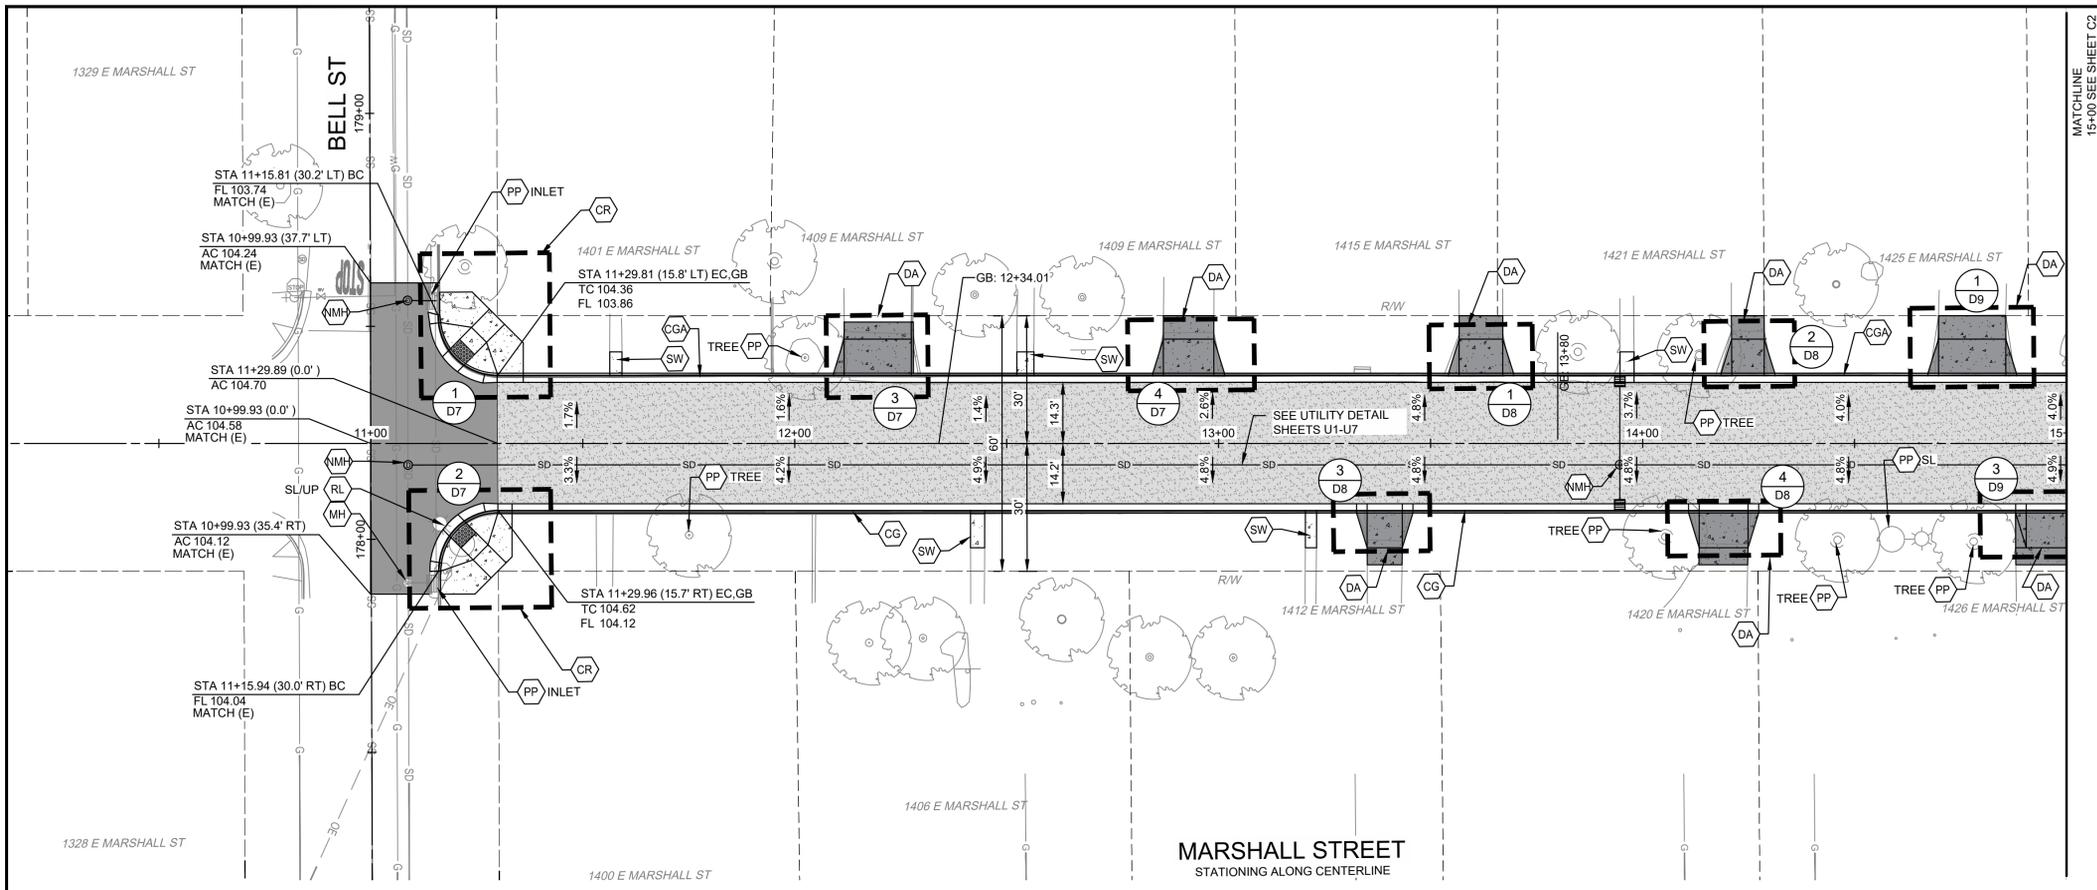
0 1"  
INCH ADJUST SCALE FOR  
REDUCED OR ENLARGED PLANS.

SHEET **G3**  
3 OF 78




CITY OF TURLOCK  
MUNICIPAL SERVICES DEPARTMENT  
ROADS PROGRAM DIVISION  
156 S. BROADWAY, SUITE 150  
(209) 668-5520

1/19/2026 8:52 AM G:\Turlock\_City of 229224001\2024 Road Rehab\300 CAD\343 Sheet Set\01\_General\G3 CONTROL POINTS.dwg -Amenemarie Fox



MATCHLINE  
15+00 SEE SHEET C2


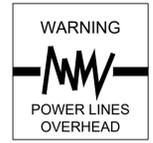


CONSTRUCTION CALLOUTS	
SYM	DESCRIPTION
AA	ALLEY APPROACH PER CITY OF TURLOCK STD DWG C-7
AG	ADJUST TO FINISHED GRADE
CGA	SAWCUT AND REMOVE (E) CURB AND GUTTER AND CONSTRUCT NEW CURB AND GUTTER PER CITY OF TURLOCK STD DWG C-1. DOWEL INTO EXISTING CURB AND GUTTER PER DETAIL 1, SHEET D5
CG	CONSTRUCT NEW CURB AND GUTTER PER CITY OF TURLOCK STD DWG C-1. DOWEL INTO EXISTING CURB AND GUTTER PER DETAIL 1, SHEET D5
CR	SAWCUT AND REMOVE (E) CURB RETURN, RAMPS, AND SIDEWALK AND CONSTRUCT NEW CURB RETURN, RAMP, AND SIDEWALK PER PROJECT SPECIFICATIONS AND SITE DETAILS
DA	RESIDENTIAL DRIVE APPROACH PER CITY OF TURLOCK STD DWG C-5
DA1	REMOVE AND REPLACE EXISTING DRIVE APPROACH TO MATCH AT EXISTING CONCRETE HINGE POINT PER CITY OF TURLOCK STD DWG C-5
DI	REMOVE AND REPLACE CATCH BASIN PER CITY OF TURLOCK STD SD-3 AND T-1
DOC	SAWCUT AND REMOVE (E) CURB AND GUTTER AND CONSTRUCT NEW DRIVE OVER CURB PER CITY OF TURLOCK PER DETAIL 3 ON SHEET D4. DOWEL INTO EXISTING CURB AND GUTTER PER DETAIL 1, SHEET D5
DW	DETECTABLE WARNING SURFACE PER CALTRANS STD DWG SHEET A88A
FH	CONSTRUCT FIRE HYDRANT PER CITY OF TURLOCK STD DWG W-1 AND T-1
MH	ADJUST MANHOLE TO FINISHED GRADE AFTER PAVING OPERATIONS PER DETAIL S-3
NDI	CONSTRUCT CATCH BASIN PER CITY OF TURLOCK STD SD-3 AND T-1
NMH	CONSTRUCT NEW MANHOLE PER CITY OF TURLOCK STD DWG S-3 AND T-1
PP	PROTECT IN PLACE
RC	RETAINING CURB
RDI	REMOVE DRAINAGE INLET
RL	REMOVE AND RELOCATE
SW	CONSTRUCT SIDEWALK PER CITY OF TURLOCK STD DWG C-3. PROVIDE 2' SIDEWALK TRANSITION WITHIN LIMITS SHOWN TO MATCH (E) ELEVATIONS. SLOPES WITHIN TRANSITION AREA SHALL NOT EXCEED 4.5% LONGITUDINALLY. DOWEL INTO EXISTING SIDEWALK PER DETAIL 1, SHEET D5. PROTECT (E) ROOF DRAINS IN PLACE OR REPLACE IN KIND
VG	CONSTRUCT VALLEY GUTTER PER CITY OF TURLOCK STD DWG C-1

**LEGEND**

- FDR-C RECONSTRUCTION PER DETAIL 2 SHEET D5
- 6.0" TYPE A HMA PAVEMENT PLUG OVER 6" CNS COMPACTED TO 95%
- 3.5" MINIMUM THICK CONCRETE OVER 6" CNS COMPACTED TO 90%
- ALLEY/DRIVE APPROACH CONCRETE THICKNESS PER CITY OF TURLOCK STD DWG C-5, C-7 & C-8
- 8.0" TYPE A HMA PAVEMENT OVER 6" CNS COMPACTED TO 95%

- CONSTRUCTION NOTES**
- EXISTING DRIVEWAYS, CURB, AND GUTTER TO REMAIN UNLESS OTHERWISE NOTED ON THE PLANS.
  - STATION AND OFFSET ON CURB AND GUTTER REFERS TO A POINT ON THE FLOWLINE.
  - DETAILED RAMP AND DRIVE APPROACH GRADING IS PROVIDED ON SHEETS D7-D22.
  - PROTECT IN PLACE ALL (E) SIDEWALK DRAINS.
  - NOT ALL SEWER LATERALS ARE SHOWN ON THE PLANS.

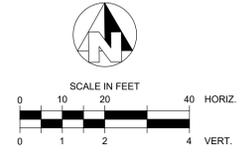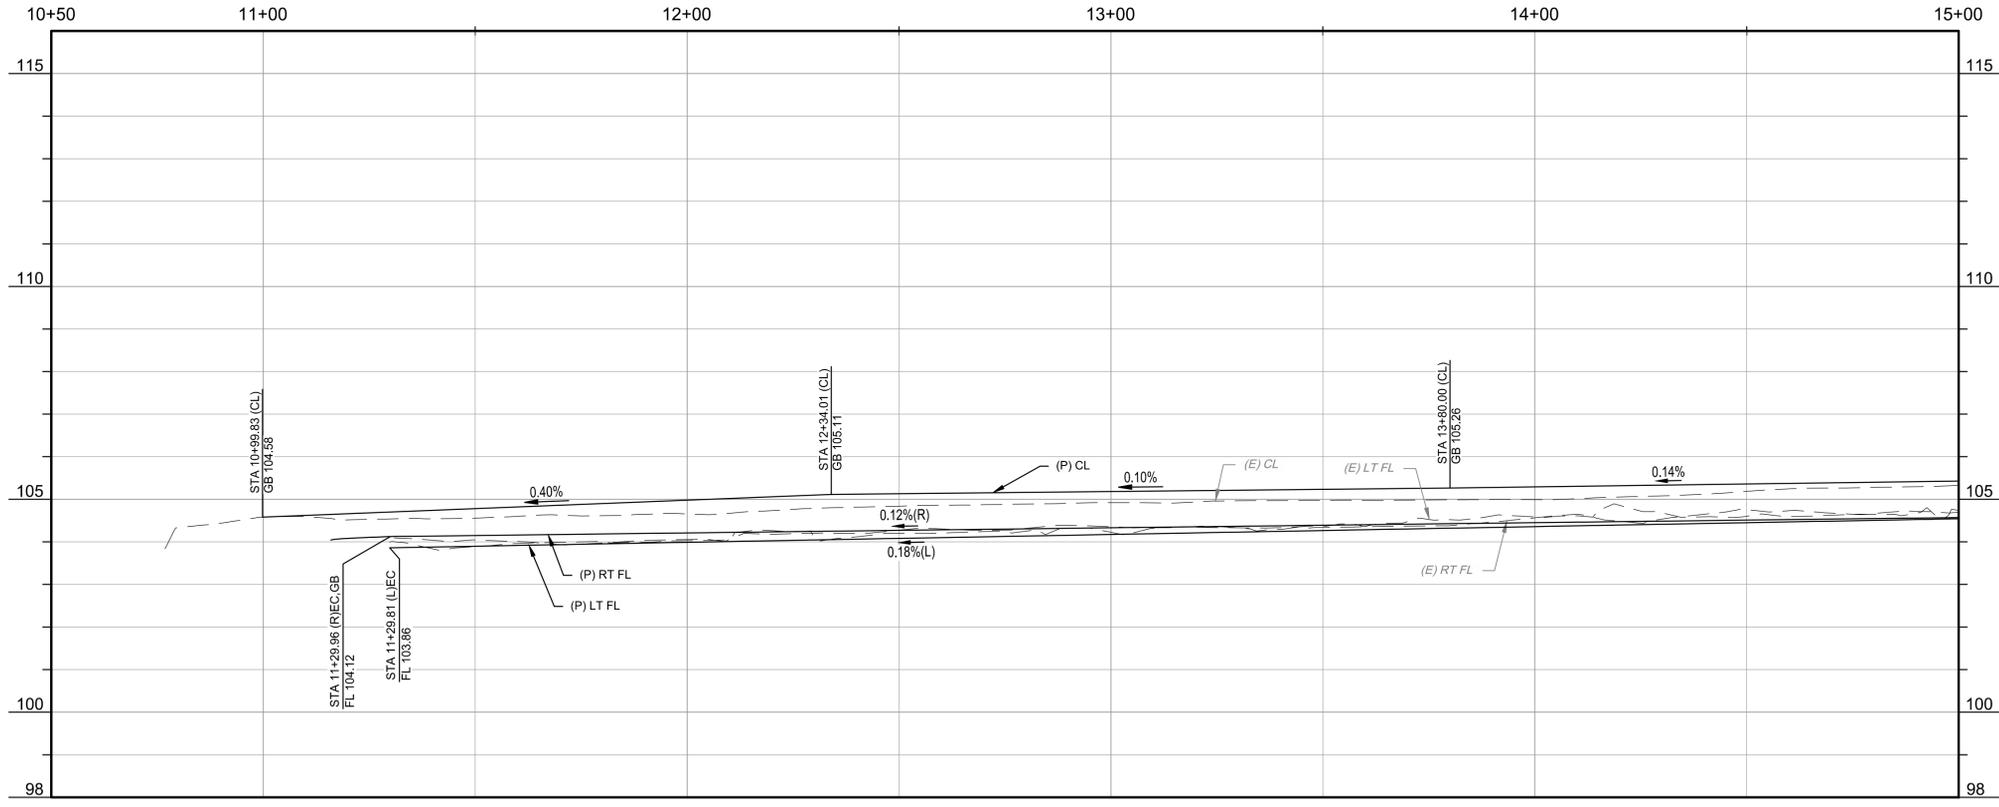

CITY OF TURLOCK  
MUNICIPAL SERVICES DEPARTMENT  
ROADS PROGRAM DIVISION  
156 S. BROADWAY, SUITE 150  
(209) 668-5520

**BID SET**  
1/22/2026

**CITY OF TURLOCK**  
ROADS PROGRAM CIP  
CITY PROJECT No. 23-068, PACKAGE 3  
STREET PLAN

**MARSHALL ST STA 10+50 - 15+00**

DESIGN ENGINEER:  
JEFF DORN  
LICENSE NO:  
76,749

DRAFTED BY: AR  
CHECKED BY: JD

DATE: JAN 2026  
JOB NO: 229224001  
PROJECT NO: 229224001  
PHASE: 3




ORIGINAL SCALE SHOWN IS ONE INCH. ADJUST SCALE FOR REDUCED OR ENLARGED PLANS.

SHEET **C1**  
4 OF 78

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FAX (209) 449-2715  
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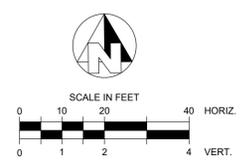




CONSTRUCTION CALLOUTS	
SYM	DESCRIPTION
AA	ALLEY APPROACH PER CITY OF TURLOCK STD DWG C-7
AG	ADJUST TO FINISHED GRADE
CGA	SAWCUT AND REMOVE (E) CURB AND GUTTER AND CONSTRUCT NEW CURB AND GUTTER PER CITY OF TURLOCK STD DWG C-1. DOWEL INTO EXISTING CURB AND GUTTER PER DETAIL 1, SHEET D5
CG	CONSTRUCT NEW CURB AND GUTTER PER CITY OF TURLOCK STD DWG C-1. DOWEL INTO EXISTING CURB AND GUTTER PER DETAIL 1, SHEET D5
CR	SAWCUT AND REMOVE (E) CURB RETURN, RAMP, AND SIDEWALK AND CONSTRUCT NEW CURB RETURN, RAMP, AND SIDEWALK PER PROJECT SPECIFICATIONS AND SITE DETAILS
DA	RESIDENTIAL DRIVE APPROACH PER CITY OF TURLOCK STD DWG C-5
DA1	REMOVE AND REPLACE EXISTING DRIVE APPROACH TO MATCH AT EXISTING CONCRETE HINGE POINT PER CITY OF TURLOCK STD DWG C-5
DI	REMOVE AND REPLACE CATCH BASIN PER CITY OF TURLOCK STD SD-3 AND T-1
DOC	SAWCUT AND REMOVE (E) CURB AND GUTTER AND CONSTRUCT NEW DRIVE OVER CURB PER CITY OF TURLOCK PER DETAIL 3 ON SHEET D4. DOWEL INTO EXISTING CURB AND GUTTER PER DETAIL 1, SHEET D5
DW	DETECTABLE WARNING SURFACE PER CALTRANS STD DWG SHEET A88A
FH	CONSTRUCT FIRE HYDRANT PER CITY OF TURLOCK STD DWG W-1 AND T-1
MH	ADJUST MANHOLE TO FINISHED GRADE AFTER PAVING OPERATIONS PER DETAIL S-3
NDI	CONSTRUCT CATCH BASIN PER CITY OF TURLOCK STD SD-3 AND T-1
NMH	CONSTRUCT NEW MANHOLE PER CITY OF TURLOCK STD DWG S-3 AND T-1
PP	PROTECT IN PLACE
RC	RETAINING CURB
RDI	REMOVE DRAINAGE INLET
RL	REMOVE AND RELOCATE
SW	CONSTRUCT SIDEWALK PER CITY OF TURLOCK STD DWG C-3. PROVIDE 2' SIDEWALK TRANSITION WITHIN LIMITS SHOWN TO MATCH (E) ELEVATIONS. SLOPES WITHIN TRANSITION AREA SHALL NOT EXCEED 4.5% LONGITUDINALLY. DOWEL INTO EXISTING SIDEWALK PER DETAIL 1, SHEET D5. PROTECT (E) ROOF DRAINS IN PLACE OR REPLACE IN KIND
VG	CONSTRUCT VALLEY GUTTER PER CITY OF TURLOCK STD DWG C-1

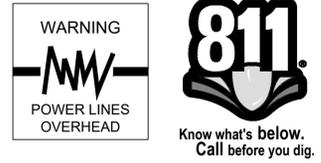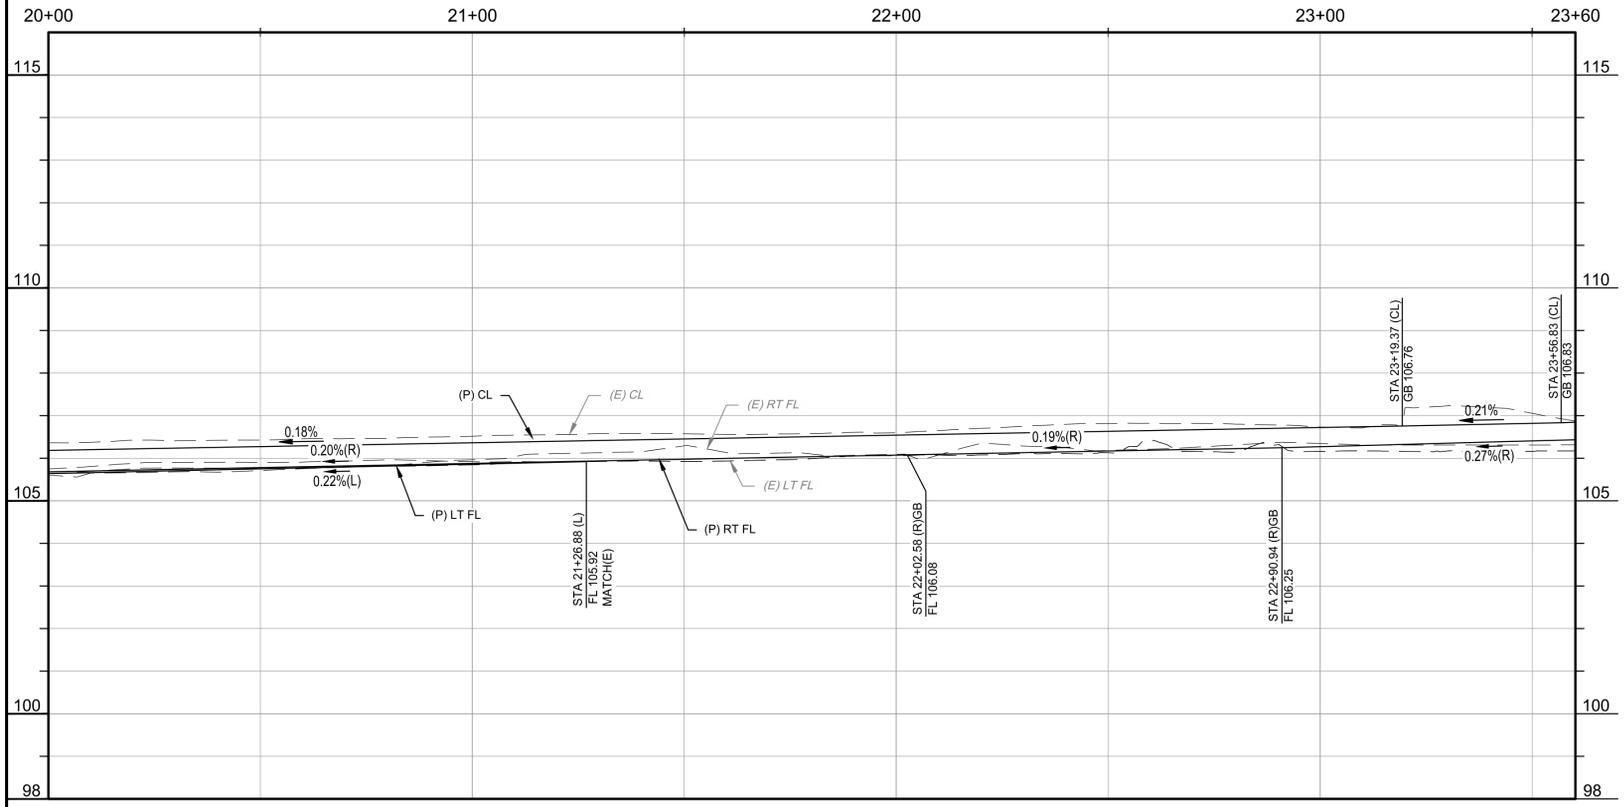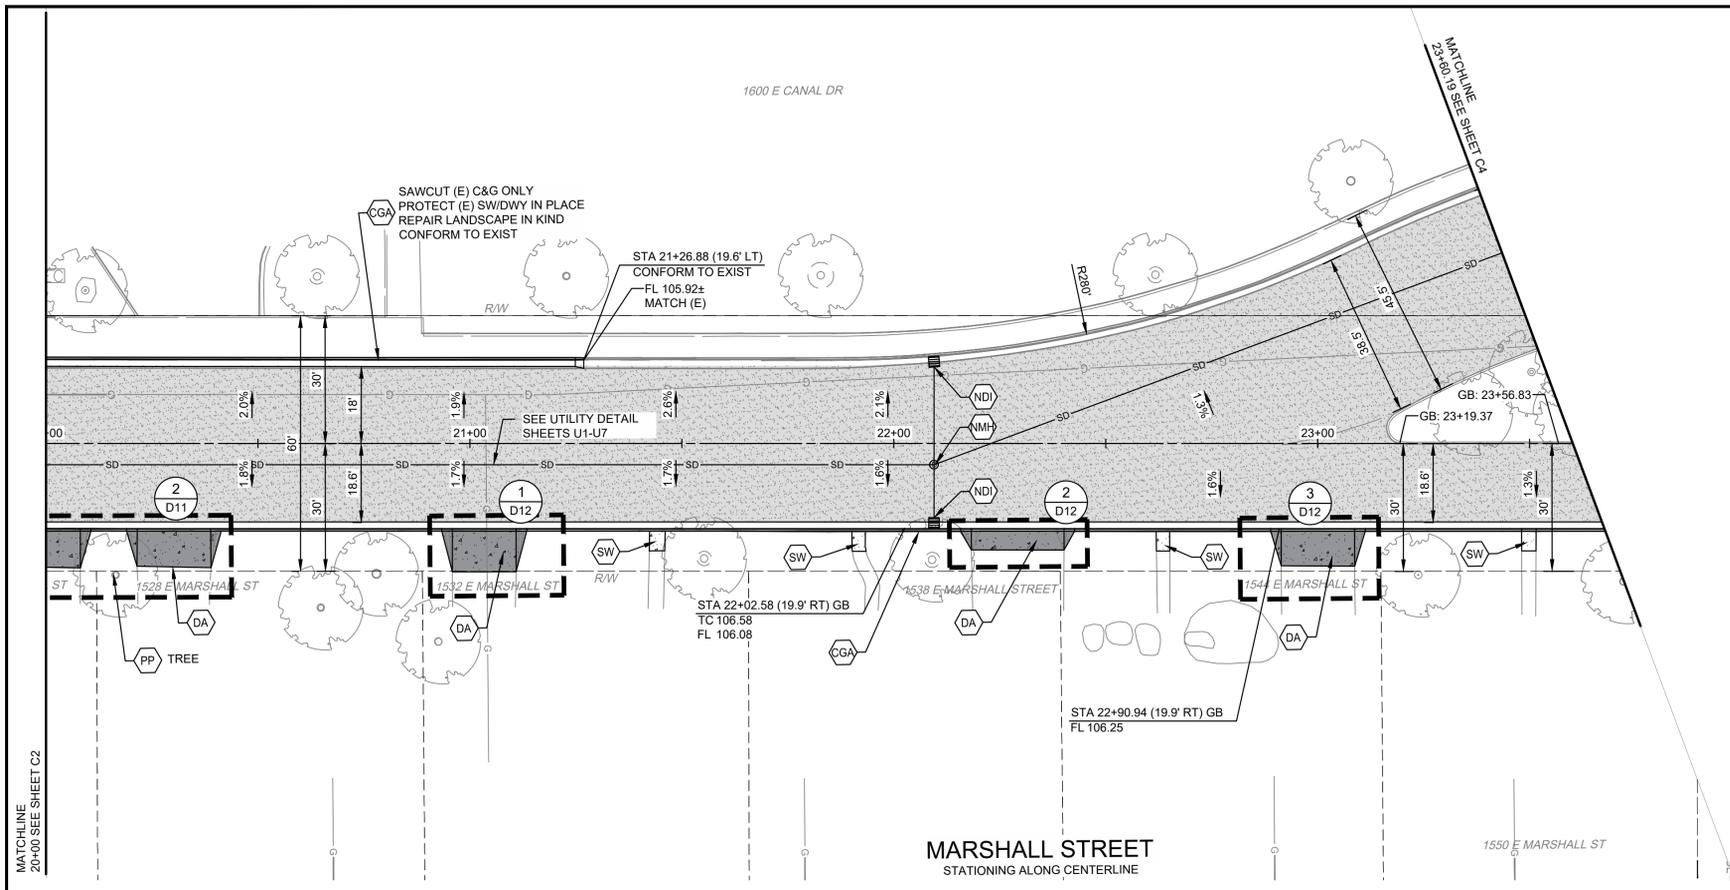LEGEND	
	FDR-C RECONSTRUCTION PER DETAIL 2 SHEET D5
	6.0" TYPE A HMA PAVEMENT PLUG OVER 6" CNS COMPACTED TO 95%
	3.5" MINIMUM THICK CONCRETE OVER 6" CNS COMPACTED TO 90%
	ALLEY/DRIVE APPROACH CONCRETE THICKNESS PER CITY OF TURLOCK STD DWG C-5, C-7 & C-8
	8.0" TYPE A HMA PAVEMENT OVER 6" CNS COMPACTED TO 95%

- CONSTRUCTION NOTES**
- EXISTING DRIVEWAYS, CURB, AND GUTTER TO REMAIN UNLESS OTHERWISE NOTED ON THE PLANS.
  - STATION AND OFFSET ON CURB AND GUTTER REFERS TO A POINT ON THE FLOWLINE.
  - DETAILED RAMP AND DRIVE APPROACH GRADING IS PROVIDED ON SHEETS D7-D22.
  - PROTECT IN PLACE ALL (E) SIDEWALK DRAINS.
  - NOT ALL SEWER LATERALS ARE SHOWN ON THE PLANS.



CITY OF TURLOCK  
MUNICIPAL SERVICES DEPARTMENT  
ROADS PROGRAM DIVISION  
156 S. BROADWAY, SUITE 150  
(209) 668-5520

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DESIGN ENGINEER:  
JEFF DORN  
LICENSE NO:  
76,749

DRAFTED BY: AR  
CHECKED BY: JD

DATE: JAN 2026  
JOB NO: 229224001  
PROJECT NO: 229224001  
PHASE: 3

ORIGINAL SCALE SHOWN IS ONE INCH. ADJUST SCALE FOR REDUCED OR ENLARGED PLANS.



SHEET **C3**  
6 OF 78

**BID SET**  
1/22/2026


CITY OF TURLOCK  
ROADS PROGRAM CIP  
CITY PROJECT No. 23-068, PACKAGE 3  
STREET PLAN  
MARSHALL ST STA 20+00 - 23+60

DATE SIGNED: [Signature]  
NO. [ ]  
REVISION [ ]  
BY [ ]  
DATE [ ]

1/19/2026 8:55 AM C:\Turlock\_City of 229224001\2024 Road Rehab\300 CAD\341 Sheet Sheet02\_Plan\_Maps\MARSHALL ST STA 20+00 - 23+60.dwg - Animate.dwg

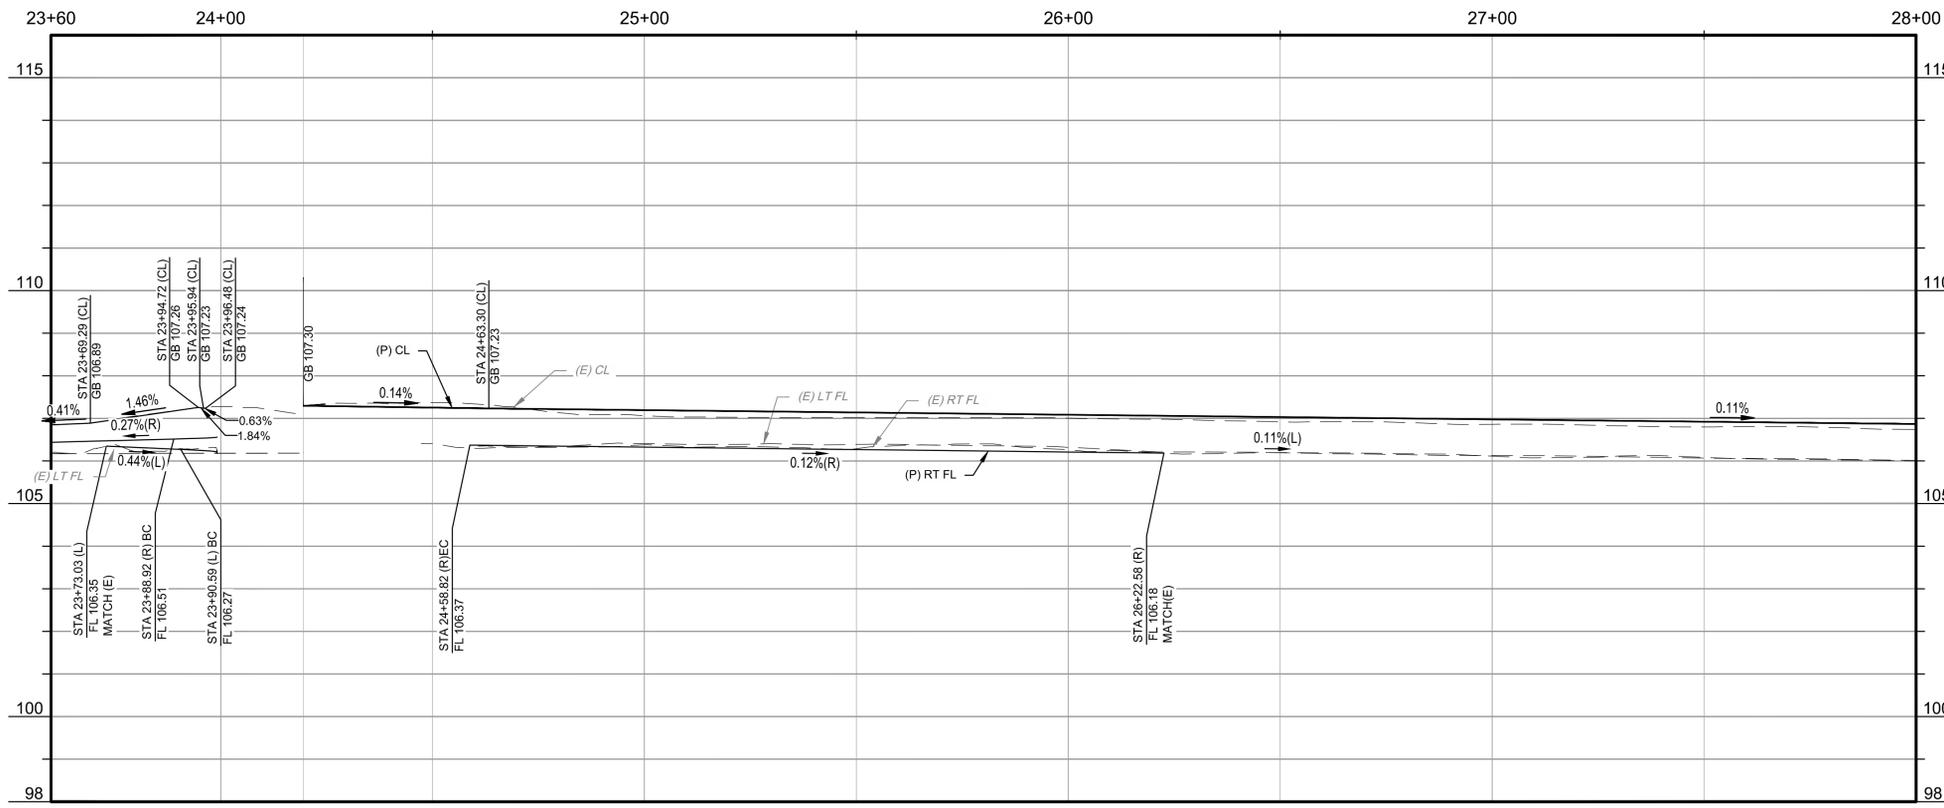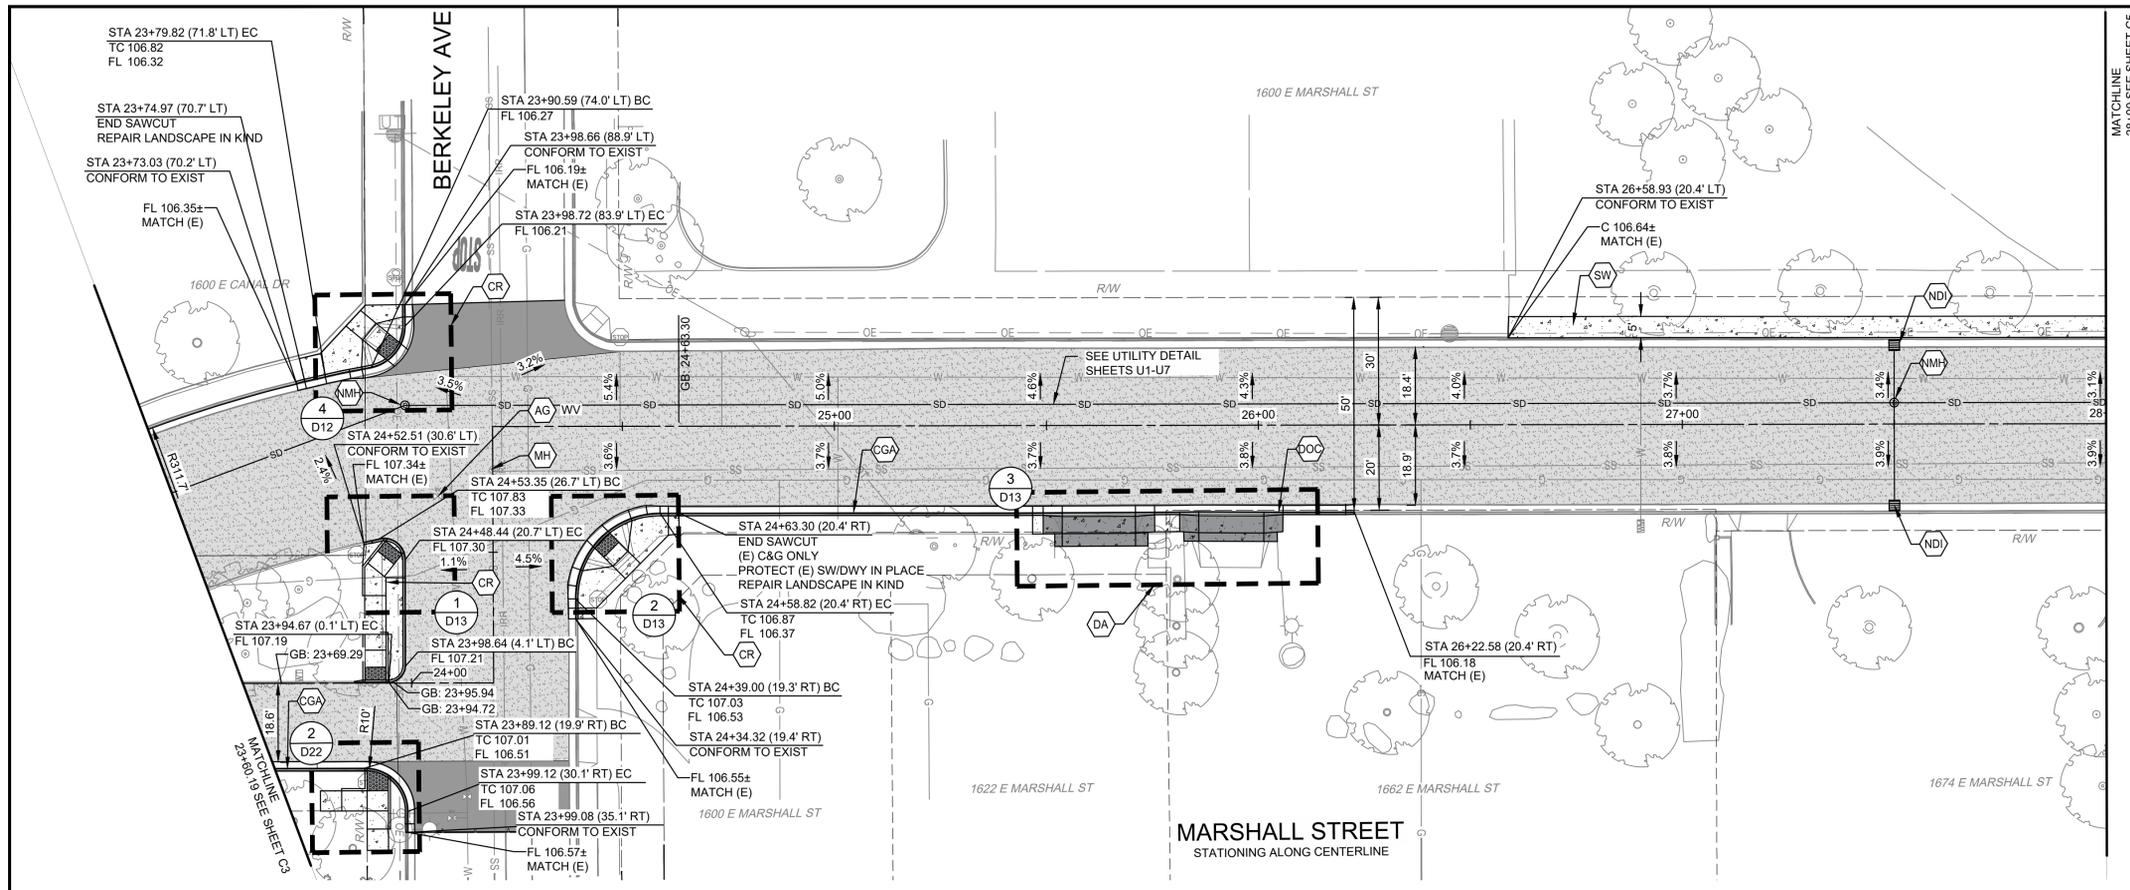


MATCHLINE  
28+00 SEE SHEET 05

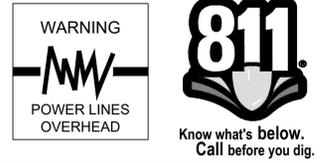

CONSTRUCTION CALLOUTS	
SYM	DESCRIPTION
AA	ALLEY APPROACH PER CITY OF TURLOCK STD DWG C-7
AG	ADJUST TO FINISHED GRADE
CGA	SAWCUT AND REMOVE (E) CURB AND GUTTER AND CONSTRUCT NEW CURB AND GUTTER PER CITY OF TURLOCK STD DWG C-1. DOWEL INTO EXISTING CURB AND GUTTER PER DETAIL 1, SHEET D5
CG	CONSTRUCT NEW CURB AND GUTTER PER CITY OF TURLOCK STD DWG C-1. DOWEL INTO EXISTING CURB AND GUTTER PER DETAIL 1, SHEET D5
CR	SAWCUT AND REMOVE (E) CURB RETURN, RAMP, AND SIDEWALK AND CONSTRUCT NEW CURB RETURN, RAMP, AND SIDEWALK PER PROJECT SPECIFICATIONS AND SITE DETAILS
DA	RESIDENTIAL DRIVE APPROACH PER CITY OF TURLOCK STD DWG C-5
DA1	REMOVE AND REPLACE EXISTING DRIVE APPROACH TO MATCH AT EXISTING CONCRETE HINGE POINT PER CITY OF TURLOCK STD DWG C-5
DI	REMOVE AND REPLACE CATCH BASIN PER CITY OF TURLOCK STD SD-3 AND T-1
DOC	SAWCUT AND REMOVE (E) CURB AND GUTTER AND CONSTRUCT NEW DRIVE OVER CURB PER CITY OF TURLOCK PER DETAIL 3 ON SHEET D4. DOWEL INTO EXISTING CURB AND GUTTER PER DETAIL 1, SHEET D5
DW	DETECTABLE WARNING SURFACE PER CALTRANS STD DWG SHEET A88A
FH	CONSTRUCT FIRE HYDRANT PER CITY OF TURLOCK STD DWG W-1 AND T-1
MH	ADJUST MANHOLE TO FINISHED GRADE AFTER PAVING OPERATIONS PER DETAIL S-3
NDI	CONSTRUCT CATCH BASIN PER CITY OF TURLOCK STD SD-3 AND T-1
NMH	CONSTRUCT NEW MANHOLE PER CITY OF TURLOCK STD DWG S-3 AND T-1
PP	PROTECT IN PLACE
RC	RETAINING CURB
RD	REMOVE DRAINAGE INLET
RL	REMOVE AND RELOCATE
SW	CONSTRUCT SIDEWALK PER CITY OF TURLOCK STD DWG C-3. PROVIDE 2' SIDEWALK TRANSITION WITHIN LIMITS SHOWN TO MATCH (E) ELEVATIONS. SLOPES WITHIN TRANSITION AREA SHALL NOT EXCEED 4.5% LONGITUDINALLY. DOWEL INTO EXISTING SIDEWALK PER DETAIL 1, SHEET D5. PROTECT (E) ROOF DRAINS IN PLACE OR REPLACE IN KIND
VG	CONSTRUCT VALLEY GUTTER PER CITY OF TURLOCK STD DWG C-1



LEGEND	
	FDR-C RECONSTRUCTION PER DETAIL 2 SHEET D5
	6.0" TYPE A HMA PAVEMENT PLUG OVER 6" CNS COMPACTED TO 95%
	3.5" MINIMUM THICK CONCRETE OVER 6" CNS COMPACTED TO 90%
	ALLEY/DRIVE APPROACH CONCRETE THICKNESS PER CITY OF TURLOCK STD DWG C-5, C-7 & C-8
	8.0" TYPE A HMA PAVEMENT OVER 6" CNS COMPACTED TO 95%

- CONSTRUCTION NOTES**
- EXISTING DRIVEWAYS, CURB, AND GUTTER TO REMAIN UNLESS OTHERWISE NOTED ON THE PLANS.
  - STATION AND OFFSET ON CURB AND GUTTER REFERS TO A POINT ON THE FLOWLINE.
  - DETAILED RAMP AND DRIVE APPROACH GRADING IS PROVIDED ON SHEETS D7-D22.
  - PROTECT IN PLACE ALL (E) SIDEWALK DRAINS.
  - NOT ALL SEWER LATERALS ARE SHOWN ON THE PLANS.

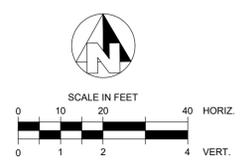


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MUNICIPAL SERVICES DEPARTMENT  
ROADS PROGRAM DIVISION  
156 S. BROADWAY, SUITE 150  
(209) 668-5520

1/19/2026 8:56 AM C:\Turlock\_City of Turlock\229224001\2024 Road Rehab\300 CAD\343 Sheet Set\02\_Plans\_Maps\MARSHALL ST STA 24+00 - 28+00.dwg - Animate.dwg  
 CITY OF TURLOCK  
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 STREET PLAN  
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 PHASE: 3  
 ORIGINAL SCALE SHOWN IS ONE INCH. ADJUST SCALE FOR REDUCED OR ENLARGED PLANS.  
 SHEET **C4**  
 7 OF 78

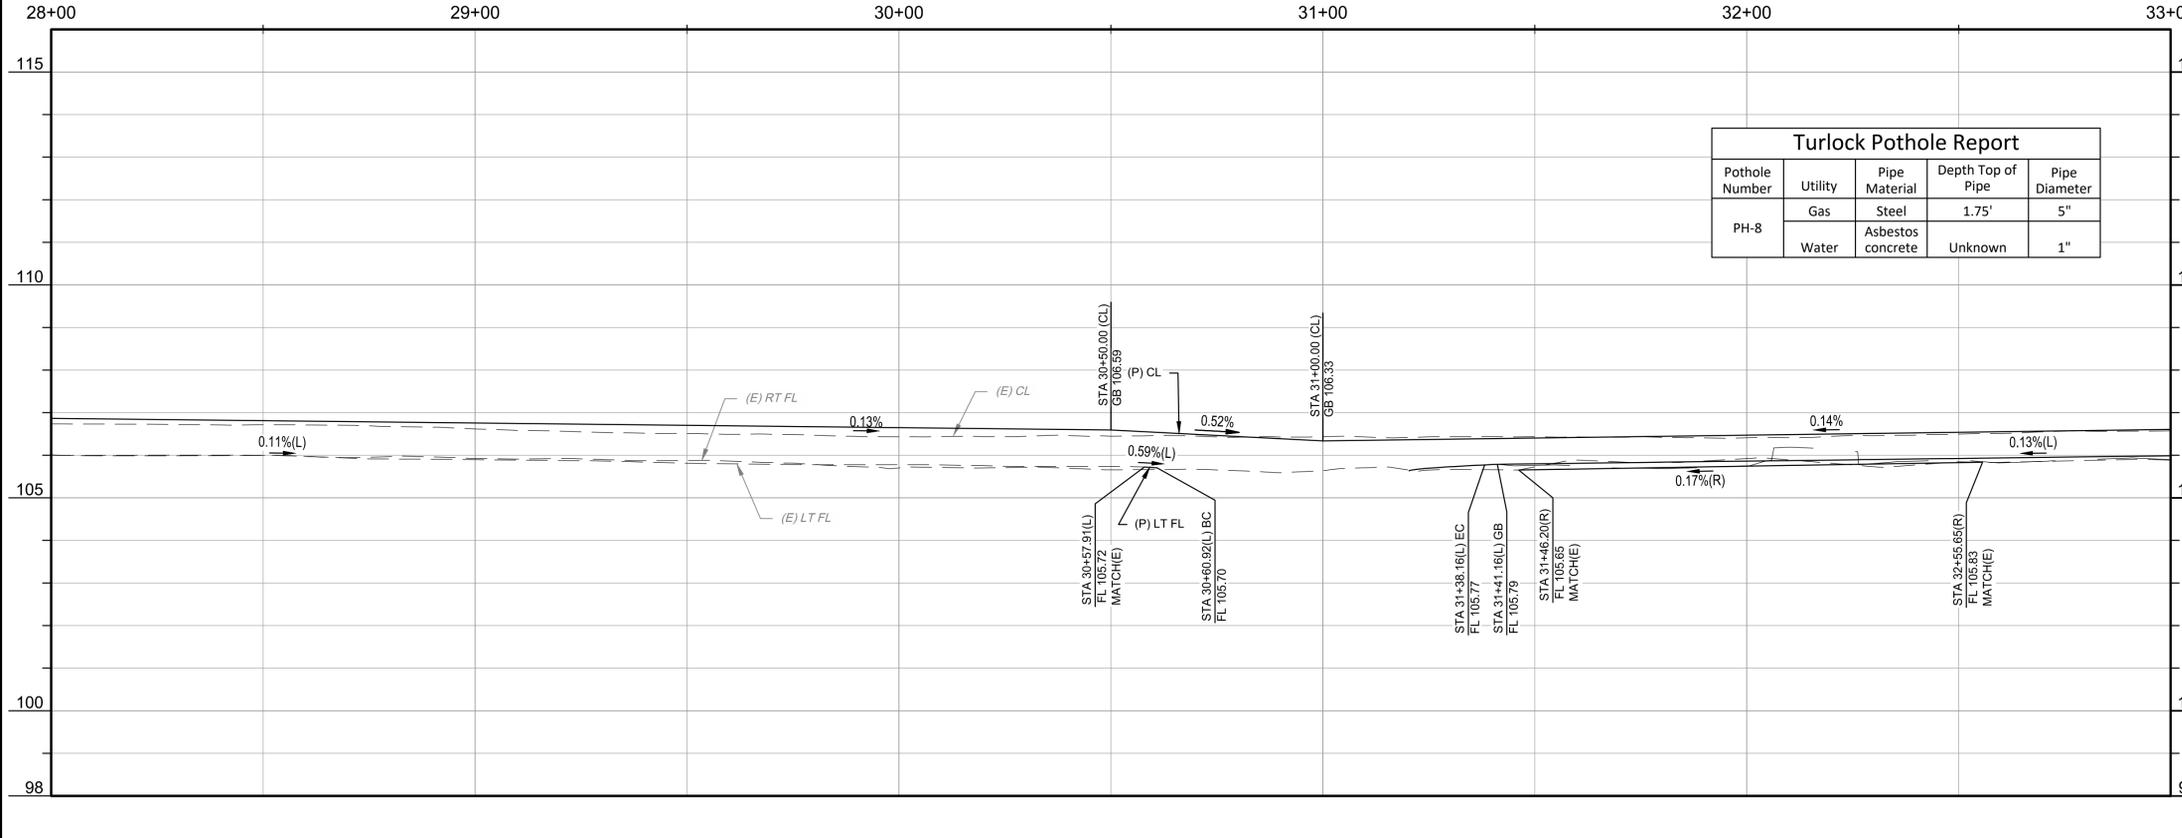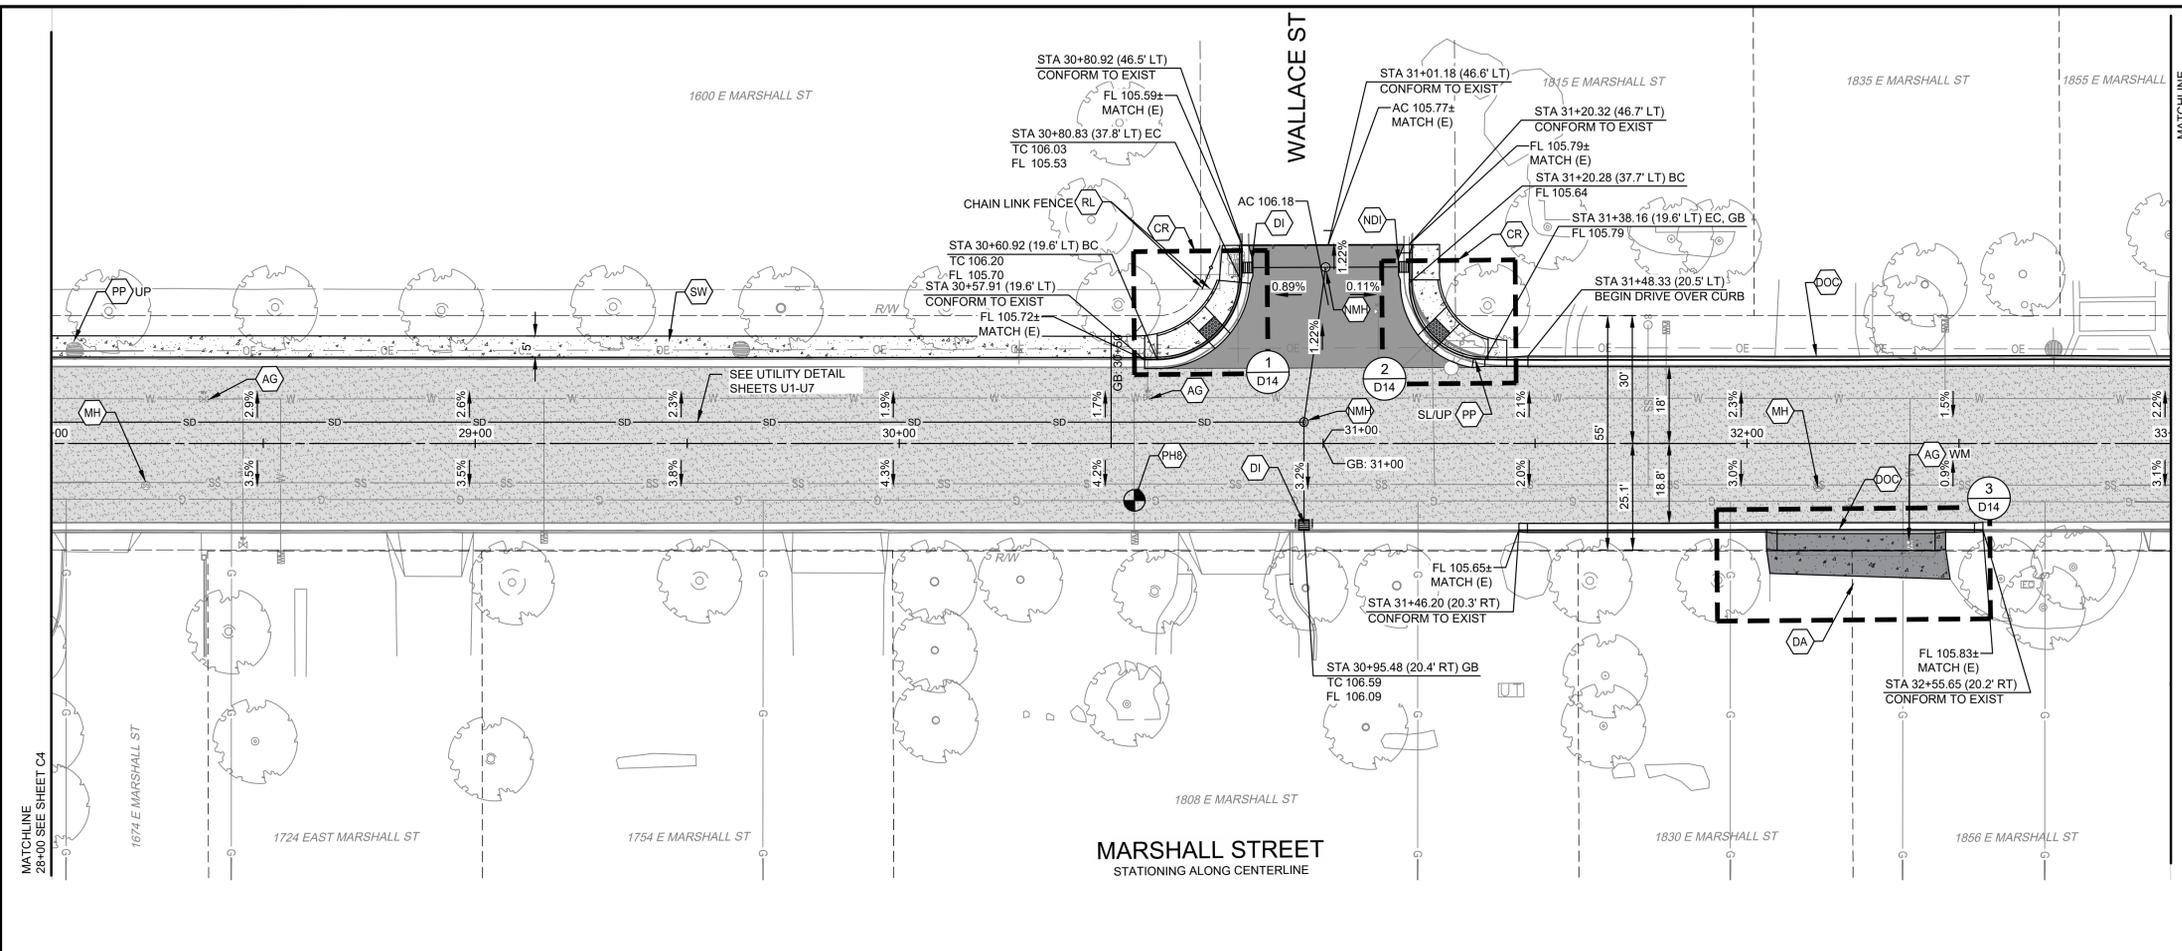

Pothole Number	Utility	Pipe Material	Depth Top of Pipe	Pipe Diameter
PH-8	Gas	Steel	1.75'	5"
	Water	Asbestos concrete	Unknown	1"

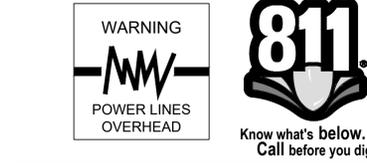

CONSTRUCTION CALLOUTS	
SYM	DESCRIPTION
AA	ALLEY APPROACH PER CITY OF TURLOCK STD DWG C-7
AG	ADJUST TO FINISHED GRADE
CGA	SAWCUT AND REMOVE (E) CURB AND GUTTER AND CONSTRUCT NEW CURB AND GUTTER PER CITY OF TURLOCK STD DWG C-1. DOWEL INTO EXISTING CURB AND GUTTER PER DETAIL 1, SHEET D5
CG	CONSTRUCT NEW CURB AND GUTTER PER CITY OF TURLOCK STD DWG C-1. DOWEL INTO EXISTING CURB AND GUTTER PER DETAIL 1, SHEET D5
CR	SAWCUT AND REMOVE (E) CURB RETURN, RAMP, AND SIDEWALK AND CONSTRUCT NEW CURB RETURN, RAMP, AND SIDEWALK PER PROJECT SPECIFICATIONS AND SITE DETAILS
DA	RESIDENTIAL DRIVE APPROACH PER CITY OF TURLOCK STD DWG C-5
DA1	REMOVE AND REPLACE EXISTING DRIVE APPROACH TO MATCH AT EXISTING CONCRETE HINGE POINT PER CITY OF TURLOCK STD DWG C-5
DI	REMOVE AND REPLACE CATCH BASIN PER CITY OF TURLOCK STD SD-3 AND T-1
DOC	SAWCUT AND REMOVE (E) CURB AND GUTTER AND CONSTRUCT NEW DRIVE OVER CURB PER CITY OF TURLOCK PER DETAIL 3 ON SHEET D4. DOWEL INTO EXISTING CURB AND GUTTER PER DETAIL 1, SHEET D5
DW	DETECTABLE WARNING SURFACE PER CALTRANS STD DWG SHEET A88A
FH	CONSTRUCT FIRE HYDRANT PER CITY OF TURLOCK STD DWG W-1 AND T-1
MH	ADJUST MANHOLE TO FINISHED GRADE AFTER PAVING OPERATIONS PER DETAIL S-3
NDI	CONSTRUCT CATCH BASIN PER CITY OF TURLOCK STD SD-3 AND T-1
NMH	CONSTRUCT NEW MANHOLE PER CITY OF TURLOCK STD DWG S-3 AND T-1
PP	PROTECT IN PLACE
RC	RETAINING CURB
RD	REMOVE DRAINAGE INLET
RL	REMOVE AND RELOCATE
SW	CONSTRUCT SIDEWALK PER CITY OF TURLOCK STD DWG C-3. PROVIDE 2' SIDEWALK TRANSITION WITHIN LIMITS SHOWN TO MATCH (E) ELEVATIONS. SLOPES WITHIN TRANSITION AREA SHALL NOT EXCEED 4.5% LONGITUDINALLY. DOWEL INTO EXISTING SIDEWALK PER DETAIL 1, SHEET D5. PROTECT (E) ROOF DRAINS IN PLACE OR REPLACE IN KIND
VG	CONSTRUCT VALLEY GUTTER PER CITY OF TURLOCK STD DWG C-1

- LEGEND**
- FDR-C RECONSTRUCTION PER DETAIL 2 SHEET D5
  - 6.0" TYPE A HMA PAVEMENT PLUG OVER 6" CNS COMPACTED TO 95%
  - 3.5" MINIMUM THICK CONCRETE OVER 6" CNS COMPACTED TO 90%
  - ALLEY/DRIVE APPROACH CONCRETE THICKNESS PER CITY OF TURLOCK STD DWG C-5, C-7 & C-8
  - 8.0" TYPE A HMA PAVEMENT OVER 6" CNS COMPACTED TO 95%

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- EXISTING DRIVEWAYS, CURB, AND GUTTER TO REMAIN UNLESS OTHERWISE NOTED ON THE PLANS.
  - STATION AND OFFSET ON CURB AND GUTTER REFERS TO A POINT ON THE FLOWLINE.
  - DETAILED RAMP AND DRIVE APPROACH GRADING IS PROVIDED ON SHEETS D7-D22.
  - PROTECT IN PLACE ALL (E) SIDEWALK DRAINS.
  - NOT ALL SEWER LATERALS ARE SHOWN ON THE PLANS.



CITY OF TURLOCK  
MUNICIPAL SERVICES DEPARTMENT  
ROADS PROGRAM DIVISION  
156 S. BROADWAY, SUITE 150  
(209) 668-5520

**BID SET**  
1/22/2026

**CITY OF TURLOCK**  
ROADS PROGRAM CIP  
CITY PROJECT No. 23-068, PACKAGE 3  
STREET PLAN  
MARSHALL ST STA 28+00 - 33+00

**PROVOST & PRITCHARD**  
425 W. FIR AVENUE  
TURLOCK, CA 95259  
PHONE (209) 449-2700  
FAX (209) 449-2715  
www.provostandpritchard.com

DESIGN ENGINEER:  
JEFF DORN  
LICENSE NO:  
76,749

DRAFTED BY: AR  
CHECKED BY: JD

DATE: JAN 2026  
JOB NO: 229224001  
PROJECT NO: 229224001  
PHASE: 3




ORIGINAL SCALE SHOWN IS ONE INCH. ADJUST SCALE FOR REDUCED OR ENLARGED PLANS.

SHEET **C5**  
8 OF 78

DATE SIGNED: \_\_\_\_\_  
NO. \_\_\_\_\_  
REVISION \_\_\_\_\_  
BY \_\_\_\_\_  
DATE \_\_\_\_\_

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SYM	DESCRIPTION
AA	ALLEY APPROACH PER CITY OF TURLOCK STD DWG C-7
AG	ADJUST TO FINISHED GRADE
CGA	SAWCUT AND REMOVE (E) CURB AND GUTTER AND CONSTRUCT NEW CURB AND GUTTER PER CITY OF TURLOCK STD DWG C-1. DOWEL INTO EXISTING CURB AND GUTTER PER DETAIL 1, SHEET D5
CG	CONSTRUCT NEW CURB AND GUTTER PER CITY OF TURLOCK STD DWG C-1. DOWEL INTO EXISTING CURB AND GUTTER PER DETAIL 1, SHEET D5
CR	SAWCUT AND REMOVE (E) CURB RETURN, RAMPS, AND SIDEWALK AND CONSTRUCT NEW CURB RETURN, RAMP, AND SIDEWALK PER PROJECT SPECIFICATIONS AND SITE DETAILS
DA	RESIDENTIAL DRIVE APPROACH PER CITY OF TURLOCK STD DWG C-5
DA1	REMOVE AND REPLACE EXISTING DRIVE APPROACH TO MATCH AT EXISTING CONCRETE HINGE POINT PER CITY OF TURLOCK STD DWG C-5
DI	REMOVE AND REPLACE CATCH BASIN PER CITY OF TURLOCK STD SD-3 AND T-1
DW	SAWCUT AND REMOVE (E) CURB AND GUTTER AND CONSTRUCT NEW DRIVE OVER CURB PER CITY OF TURLOCK PER DETAIL 3 ON SHEET D4. DOWEL INTO EXISTING CURB AND GUTTER PER DETAIL 1, SHEET D5
DW1	DETECTABLE WARNING SURFACE PER CALTRANS STD DWG SHEET A88A
FH	CONSTRUCT FIRE HYDRANT PER CITY OF TURLOCK STD DWG W-1 AND T-1
MH	ADJUST MANHOLE TO FINISHED GRADE AFTER PAVING OPERATIONS PER DETAIL S-3
NDI	CONSTRUCT CATCH BASIN PER CITY OF TURLOCK STD SD-3 AND T-1
NMH	CONSTRUCT NEW MANHOLE PER CITY OF TURLOCK STD DWG S-3 AND T-1
PP	PROTECT IN PLACE
RC	RETAINING CURB
RDI	REMOVE DRAINAGE INLET
RL	REMOVE AND RELOCATE
SW	CONSTRUCT SIDEWALK PER CITY OF TURLOCK STD DWG C-3. PROVIDE 2' SIDEWALK TRANSITION WITHIN LIMITS SHOWN TO MATCH (E) ELEVATIONS. SLOPES WITHIN TRANSITION AREA SHALL NOT EXCEED 4.5% LONGITUDINALLY. DOWEL INTO EXISTING SIDEWALK PER DETAIL 1, SHEET D5. PROTECT (E) ROOF DRAINS IN PLACE OR REPLACE IN KIND
VG	CONSTRUCT VALLEY GUTTER PER CITY OF TURLOCK STD DWG C-1

- LEGEND**
- FDR-C RECONSTRUCTION PER DETAIL 2 SHEET D5
  - 6.0" TYPE A HMA PAVEMENT PLUG OVER 6" CNS COMPACTED TO 95%
  - 3.5" MINIMUM THICK CONCRETE OVER 6" CNS COMPACTED TO 90%
  - ALLEY/DRIVE APPROACH CONCRETE THICKNESS PER CITY OF TURLOCK STD DWG C-5, C-7 & C-8
  - 8.0" TYPE A HMA PAVEMENT OVER 6" CNS COMPACTED TO 95%
- CONSTRUCTION NOTES**
- EXISTING DRIVEWAYS, CURB, AND GUTTER TO REMAIN UNLESS OTHERWISE NOTED ON THE PLANS.
  - STATION AND OFFSET ON CURB AND GUTTER REFERS TO A POINT ON THE FLOWLINE.
  - DETAILED RAMP AND DRIVE APPROACH GRADING IS PROVIDED ON SHEETS D7-D22.
  - PROTECT IN PLACE ALL (E) SIDEWALK DRAINS.
  - NOT ALL SEWER LATERALS ARE SHOWN ON THE PLANS.

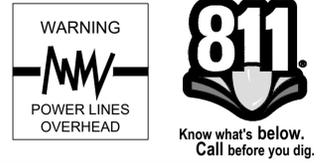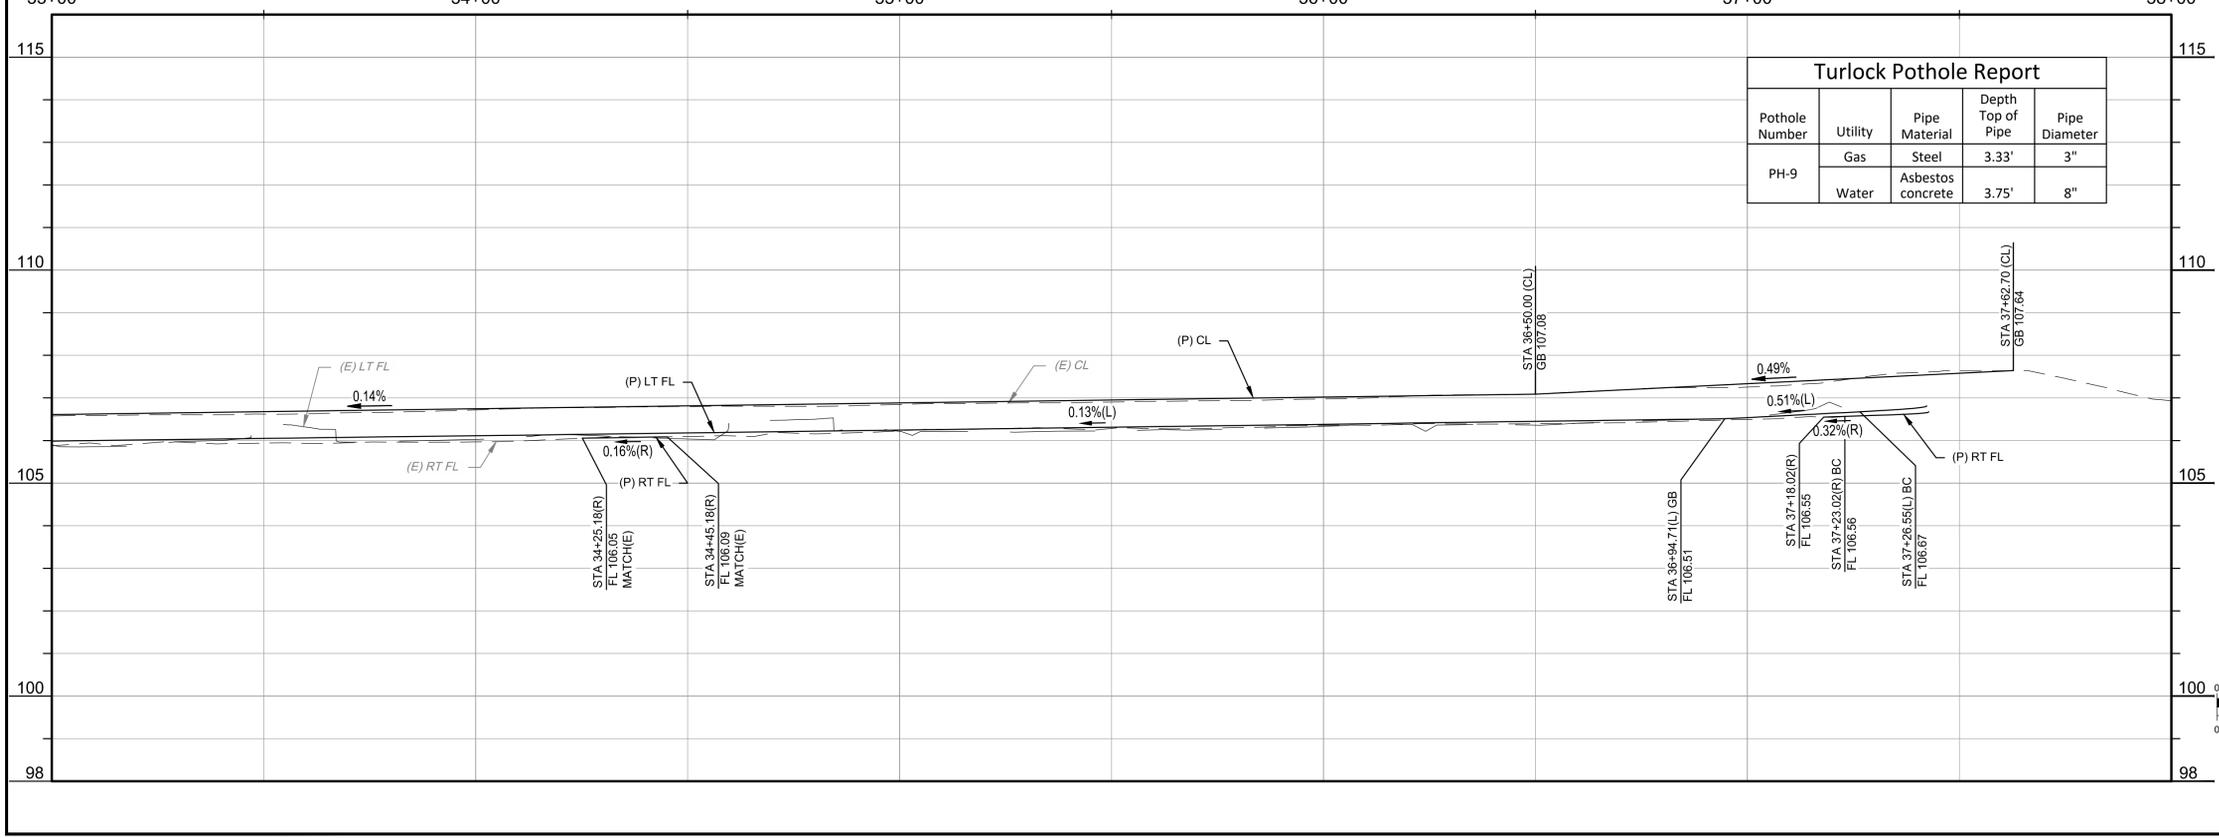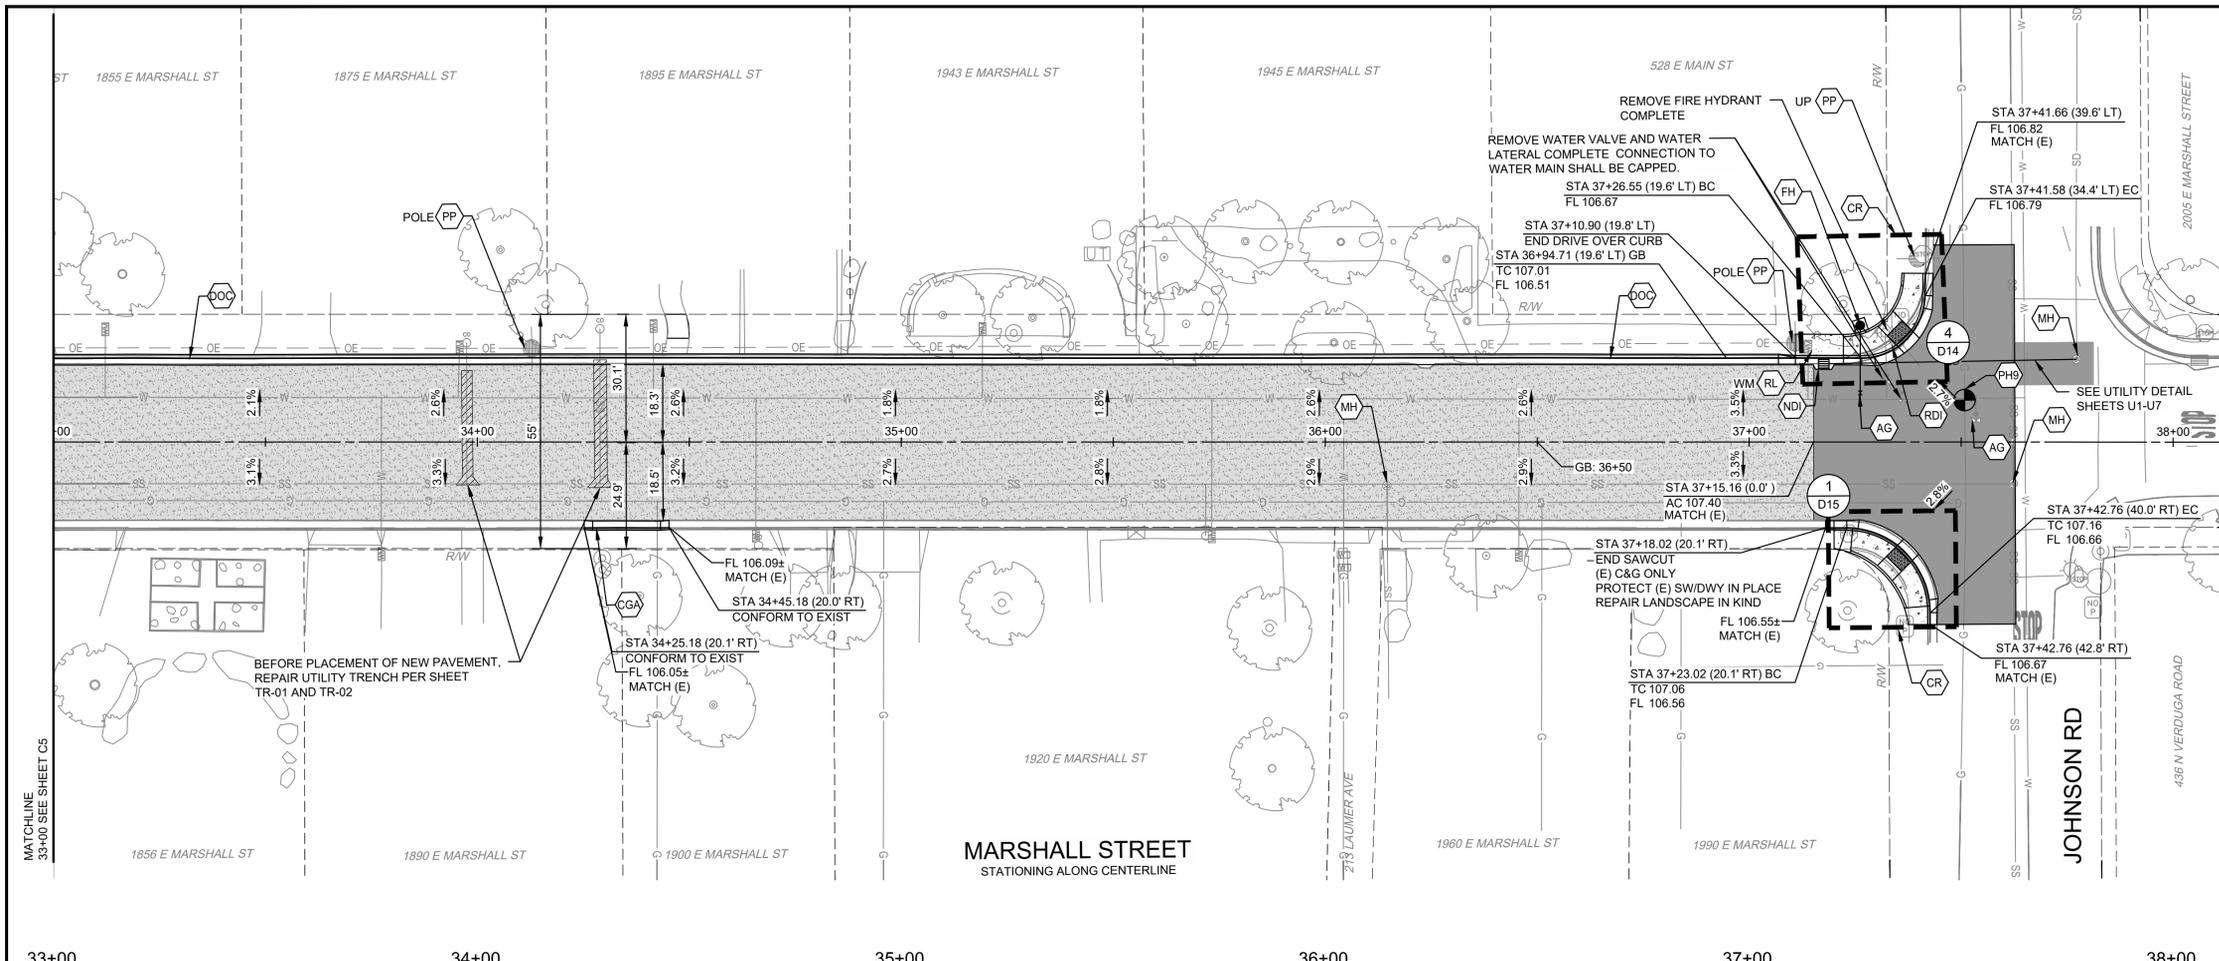- CONSTRUCTION CALLOUTS**
- REMOVE FIRE HYDRANT COMPLETE
  - REMOVE WATER VALVE AND WATER LATERAL COMPLETE CONNECTION TO WATER MAIN SHALL BE CAPPED.
  - END SAWCUT (E) C&G ONLY PROTECT (E) SW/DWY IN PLACE REPAIR LANDSCAPE IN KIND
  - END SAWCUT (E) C&G ONLY PROTECT (E) SW/DWY IN PLACE REPAIR LANDSCAPE IN KIND
  - REMOVE FIRE HYDRANT COMPLETE
  - REMOVE WATER VALVE AND WATER LATERAL COMPLETE CONNECTION TO WATER MAIN SHALL BE CAPPED.
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  - END SAWCUT (E) C&G ONLY PROTECT (E) SW/DWY IN PLACE REPAIR LANDSCAPE IN KIND

**CITY OF TURLOCK**  
ROADS PROGRAM CIP  
CITY PROJECT No. 23-068, PACKAGE 3  
STREET PLAN

**PROVOST & PRITCHARD**  
425 W. FIR AVENUE  
TURLOCK, CA 95259  
PHONE (530) 449-2700  
FAX (530) 449-2715  
www.provostandpritchard.com

DESIGN ENGINEER:  
JEFF DORN  
LICENSE NO:  
76,749

DRAFTED BY: AR  
CHECKED BY: JD

DATE: JAN 2026  
JOB NO: 229224001  
PROJECT NO: 229224001  
PHASE: 3

ORIGINAL SCALE SHOWN IS ONE INCH. ADJUST SCALE FOR REDUCED OR ENLARGED PLANS.

SHEET **C6**  
9 OF 78

CITY OF TURLOCK  
MUNICIPAL SERVICES DEPARTMENT  
ROADS PROGRAM DIVISION  
156 S. BROADWAY, SUITE 150  
(209) 668-5520

**BID SET**  
1/22/2026

**REVISION**

NO.	REVISION	BY	DATE



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**DATE:**


**PROVOST & PRITCHARD**  
REGISTERED PROFESSIONAL ENGINEER  
CIVIL  
No. 76,749  
STATE OF CALIFORNIA

**CITY OF TURLOCK**  
MUNICIPAL SERVICES DEPARTMENT  
ROADS PROGRAM DIVISION  
156 S. BROADWAY, SUITE 150  
(209) 668-5520

1/19/2026 8:58 AM C:\Turlock\_City of 229224001\2024 Road Rehab\300 CAD\341 Sheet C02\_Plans\_Maps\06 MARSHALL ST STA 33+00 - 38+00.dwg -Ammemare Fox

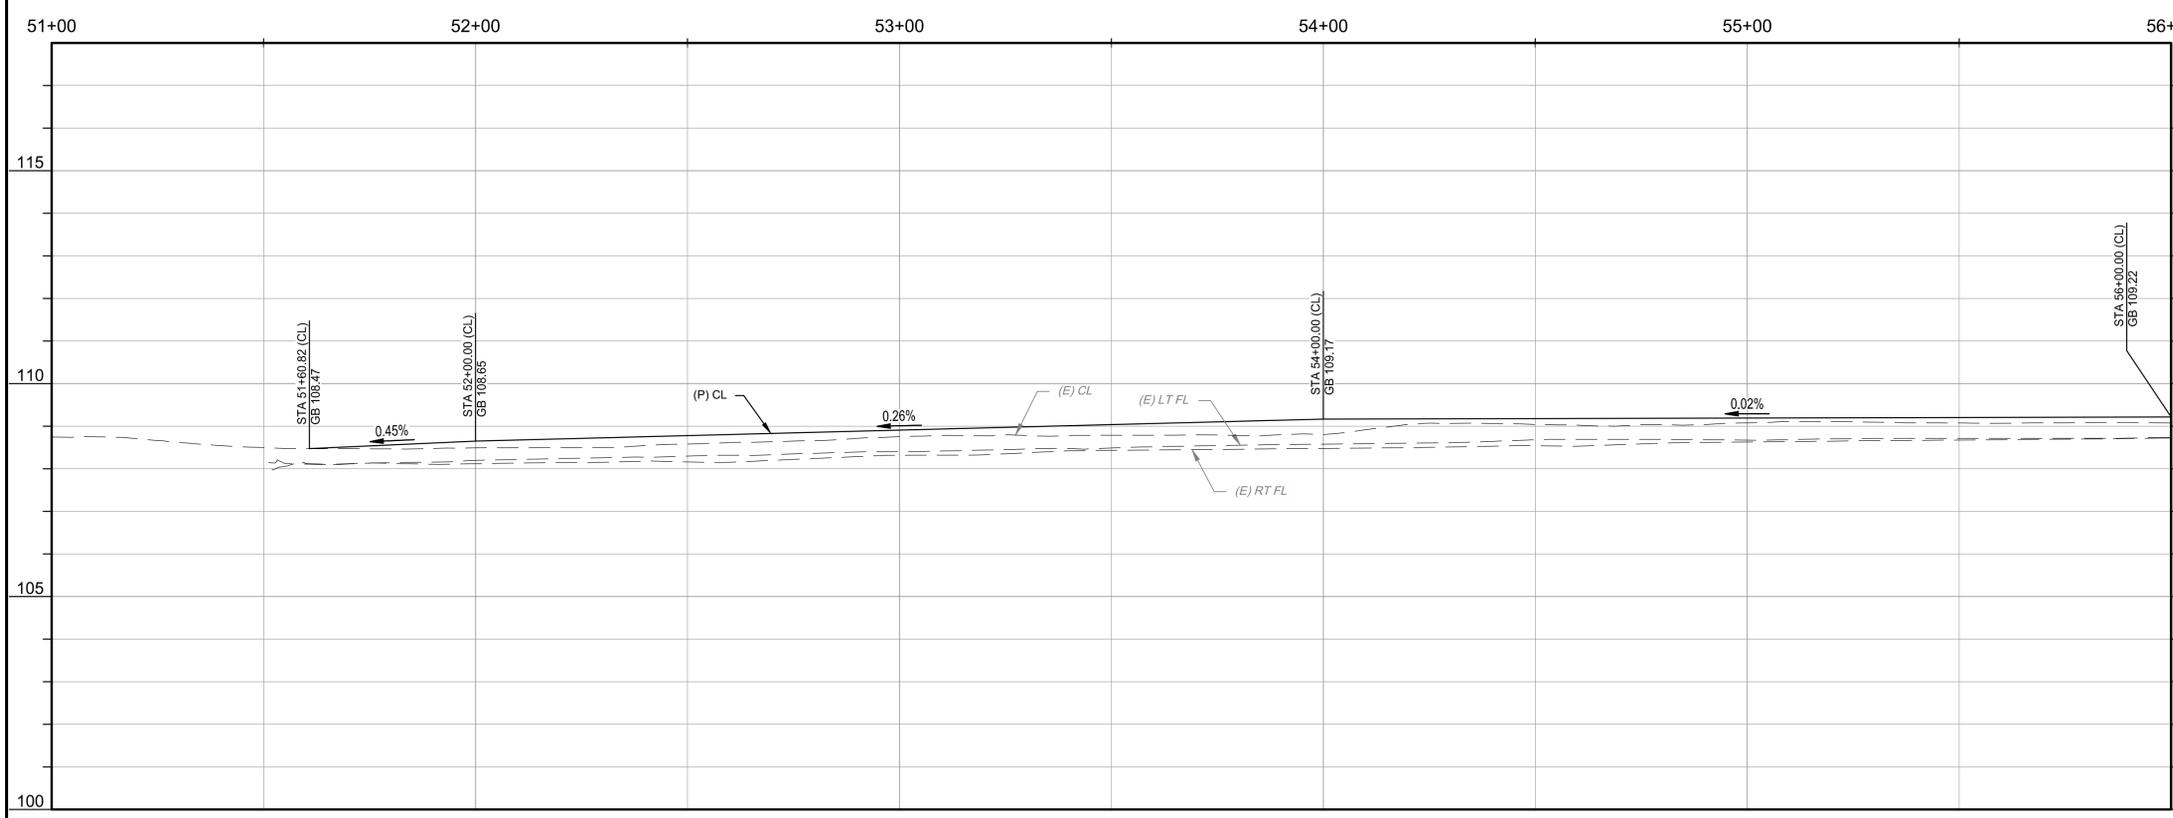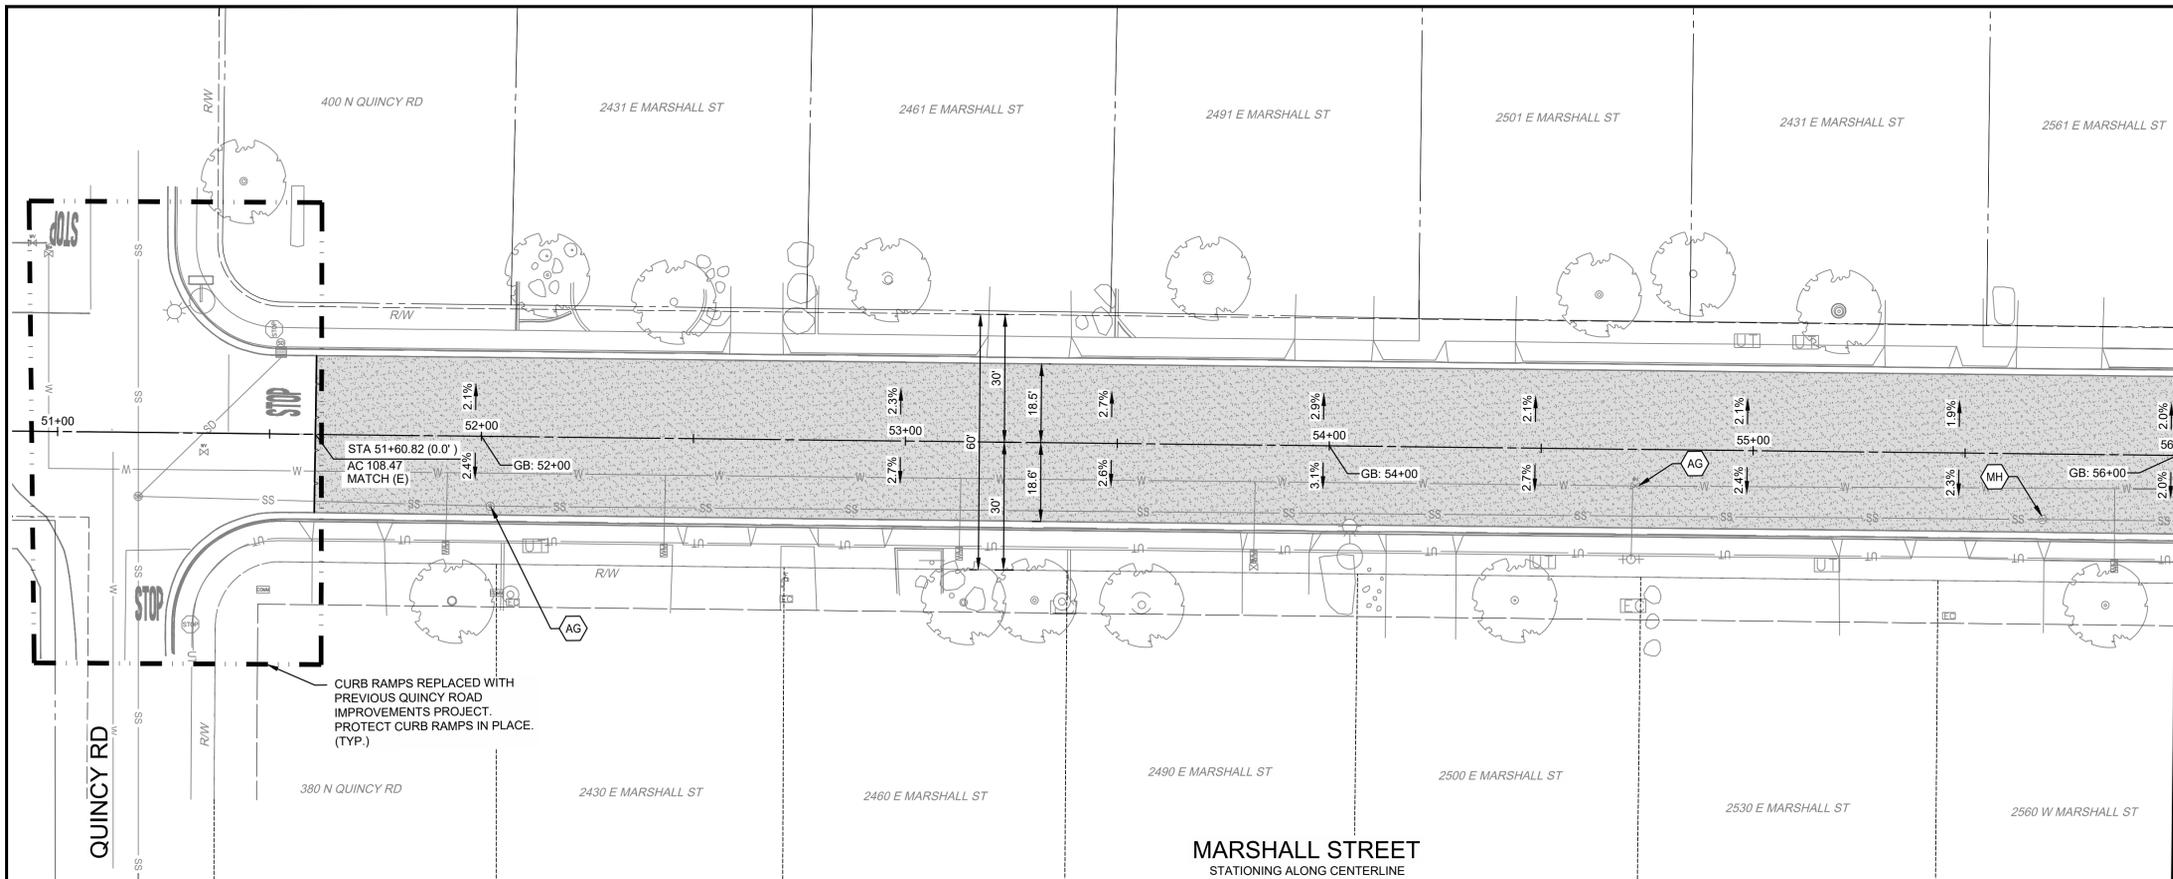


MATCHLINE  
56+00 SEE SHEET C8

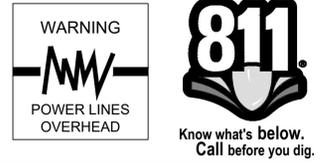

CONSTRUCTION CALLOUTS	
SYM	DESCRIPTION
AA	ALLEY APPROACH PER CITY OF TURLOCK STD DWG C-7
AG	ADJUST TO FINISHED GRADE
CGA	SAWCUT AND REMOVE (E) CURB AND GUTTER AND CONSTRUCT NEW CURB AND GUTTER PER CITY OF TURLOCK STD DWG C-1. DOWEL INTO EXISTING CURB AND GUTTER PER DETAIL 1, SHEET D5
CG	CONSTRUCT NEW CURB AND GUTTER PER CITY OF TURLOCK STD DWG C-1. DOWEL INTO EXISTING CURB AND GUTTER PER DETAIL 1, SHEET D5
CR	SAWCUT AND REMOVE (E) CURB RETURN, RAMPS, AND SIDEWALK AND CONSTRUCT NEW CURB RETURN, RAMP, AND SIDEWALK PER PROJECT SPECIFICATIONS AND SITE DETAILS
DA	RESIDENTIAL DRIVE APPROACH PER CITY OF TURLOCK STD DWG C-5
DA1	REMOVE AND REPLACE EXISTING DRIVE APPROACH TO MATCH AT EXISTING CONCRETE HINGE POINT PER CITY OF TURLOCK STD DWG C-5
DI	REMOVE AND REPLACE CATCH BASIN PER CITY OF TURLOCK STD SD-3 AND T-1
DOC	SAWCUT AND REMOVE (E) CURB AND GUTTER AND CONSTRUCT NEW DRIVE OVER CURB PER CITY OF TURLOCK PER DETAIL 3 ON SHEET D4. DOWEL INTO EXISTING CURB AND GUTTER PER DETAIL 1, SHEET D5
DW	DETECTABLE WARNING SURFACE PER CALTRANS STD DWG SHEET A88A
FH	CONSTRUCT FIRE HYDRANT PER CITY OF TURLOCK STD DWG W-1 AND T-1
MH	ADJUST MANHOLE TO FINISHED GRADE AFTER PAVING OPERATIONS PER DETAIL S-3
NDI	CONSTRUCT CATCH BASIN PER CITY OF TURLOCK STD SD-3 AND T-1
NMH	CONSTRUCT NEW MANHOLE PER CITY OF TURLOCK STD DWG S-3 AND T-1
PP	PROTECT IN PLACE
RC	RETAINING CURB
RD	REMOVE DRAINAGE INLET
RL	REMOVE AND RELOCATE
SW	CONSTRUCT SIDEWALK PER CITY OF TURLOCK STD DWG C-3. PROVIDE 2' SIDEWALK TRANSITION WITHIN LIMITS SHOWN TO MATCH (E) ELEVATIONS. SLOPES WITHIN TRANSITION AREA SHALL NOT EXCEED 4.5% LONGITUDINALLY. DOWEL INTO EXISTING SIDEWALK PER DETAIL 1, SHEET D5. PROTECT (E) ROOF DRAINS IN PLACE OR REPLACE IN KIND
VG	CONSTRUCT VALLEY GUTTER PER CITY OF TURLOCK STD DWG C-1

LEGEND	
[Pattern]	FDR-C RECONSTRUCTION PER DETAIL 2 SHEET D5
[Pattern]	6.0" TYPE A HMA PAVEMENT PLUG OVER 6" CNS COMPACTED TO 95%
[Pattern]	3.5" MINIMUM THICK CONCRETE OVER 6" CNS COMPACTED TO 90%
[Pattern]	ALLEY/DRIVE APPROACH CONCRETE THICKNESS PER CITY OF TURLOCK STD DWG C-5, C-7 & C-8
[Pattern]	8.0" TYPE A HMA PAVEMENT OVER 6" CNS COMPACTED TO 95%

- CONSTRUCTION NOTES**
- EXISTING DRIVEWAYS, CURB, AND GUTTER TO REMAIN UNLESS OTHERWISE NOTED ON THE PLANS.
  - STATION AND OFFSET ON CURB AND GUTTER REFERS TO A POINT ON THE FLOWLINE.
  - DETAILED RAMP AND DRIVE APPROACH GRADING IS PROVIDED ON SHEETS D7-D22.
  - PROTECT IN PLACE ALL (E) SIDEWALK DRAINS.
  - NOT ALL SEWER LATERALS ARE SHOWN ON THE PLANS.

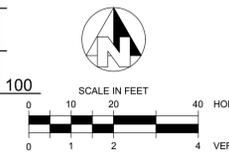

CITY OF TURLOCK  
MUNICIPAL SERVICES DEPARTMENT  
ROADS PROGRAM DIVISION  
156 S. BROADWAY, SUITE 150  
(209) 668-5520

**BID SET**  
1/22/2026

**CITY OF TURLOCK**  
ROADS PROGRAM CIP  
CITY PROJECT No. 23-068, PACKAGE 3  
STREET PLAN  
MARSHALL ST STA 51+00 - 56+00

**PROVOST & PRITCHARD**  
425 W. FIR AVENUE  
TURLOCK, CA 95259  
PHONE (209) 449-2700  
FAX (209) 449-2715  
www.provostandpritchard.com

DESIGN ENGINEER:  
JEFF DORN  
LICENSE NO:  
76,749

DRAFTED BY: AR  
CHECKED BY: JD

DATE: JAN 2026  
JOB NO: 229224001  
PROJECT NO: 229224001  
PHASE: 3



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SHEET **C7**  
10 OF 78

DATE SIGNED: \_\_\_\_\_  
NO. \_\_\_\_\_  
REVISION \_\_\_\_\_  
BY \_\_\_\_\_  
DATE \_\_\_\_\_


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MATCHLINE  
61+00 SEE SHEET C9


MATCHLINE  
56+00 SEE SHEET C7

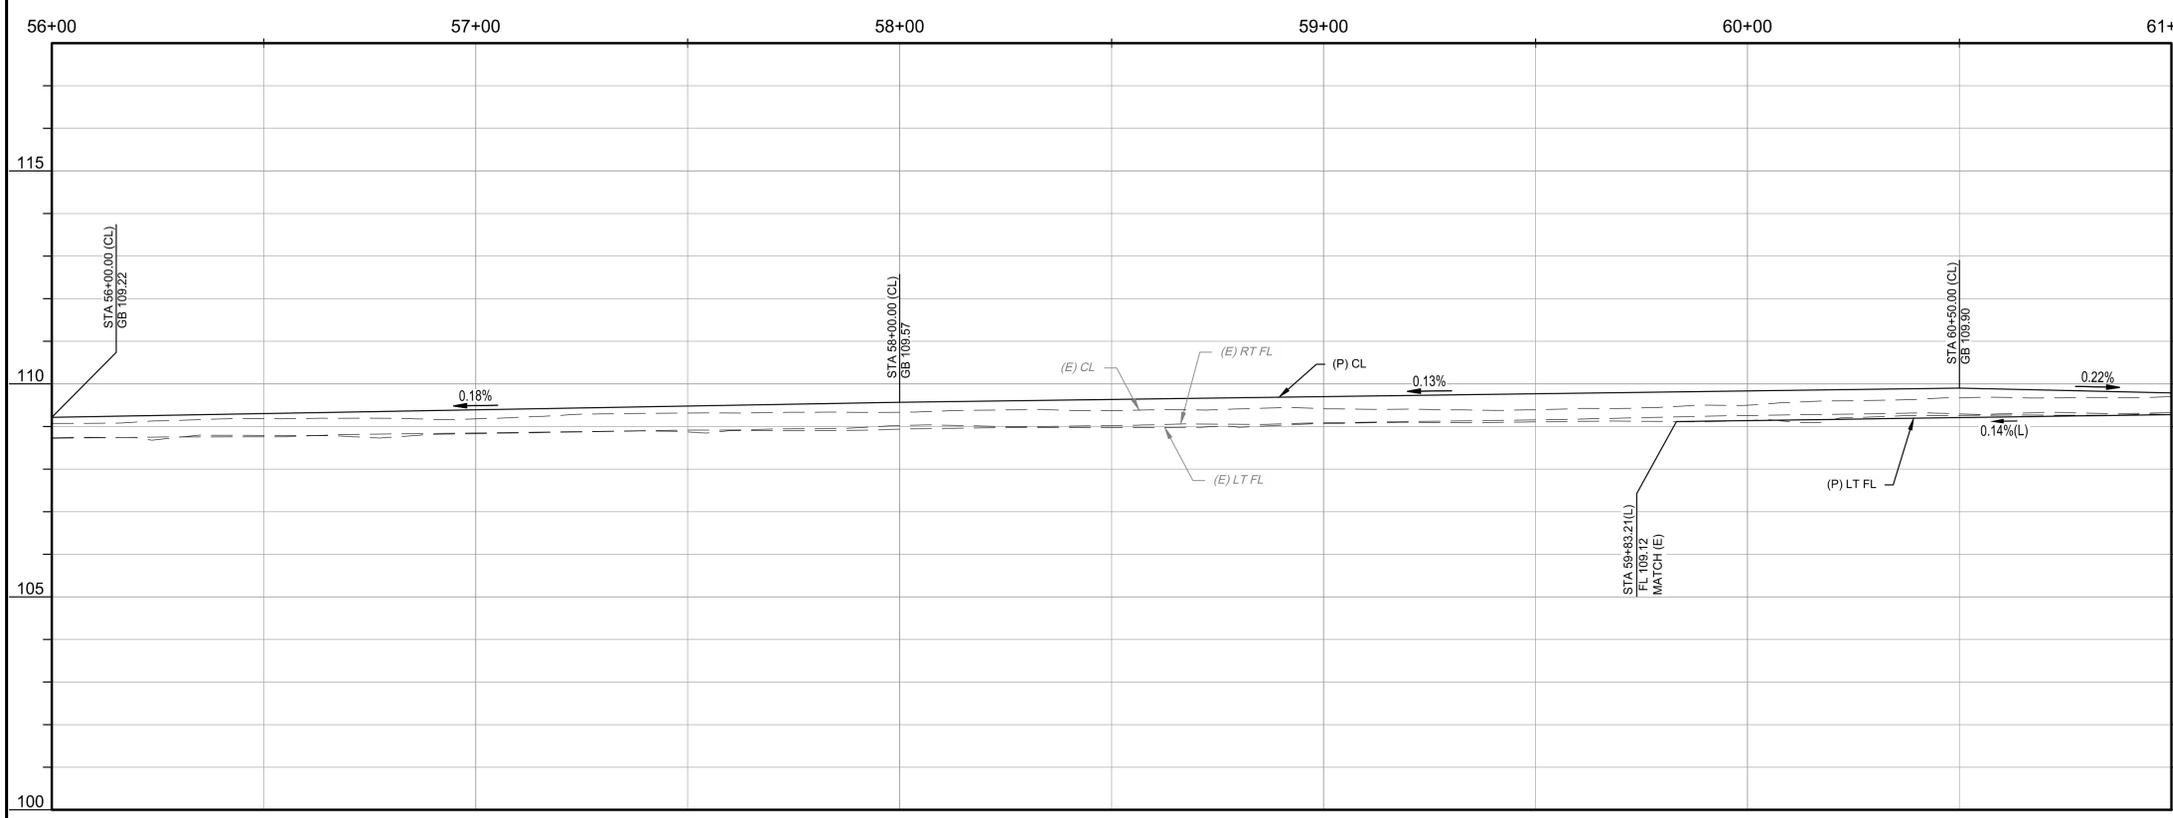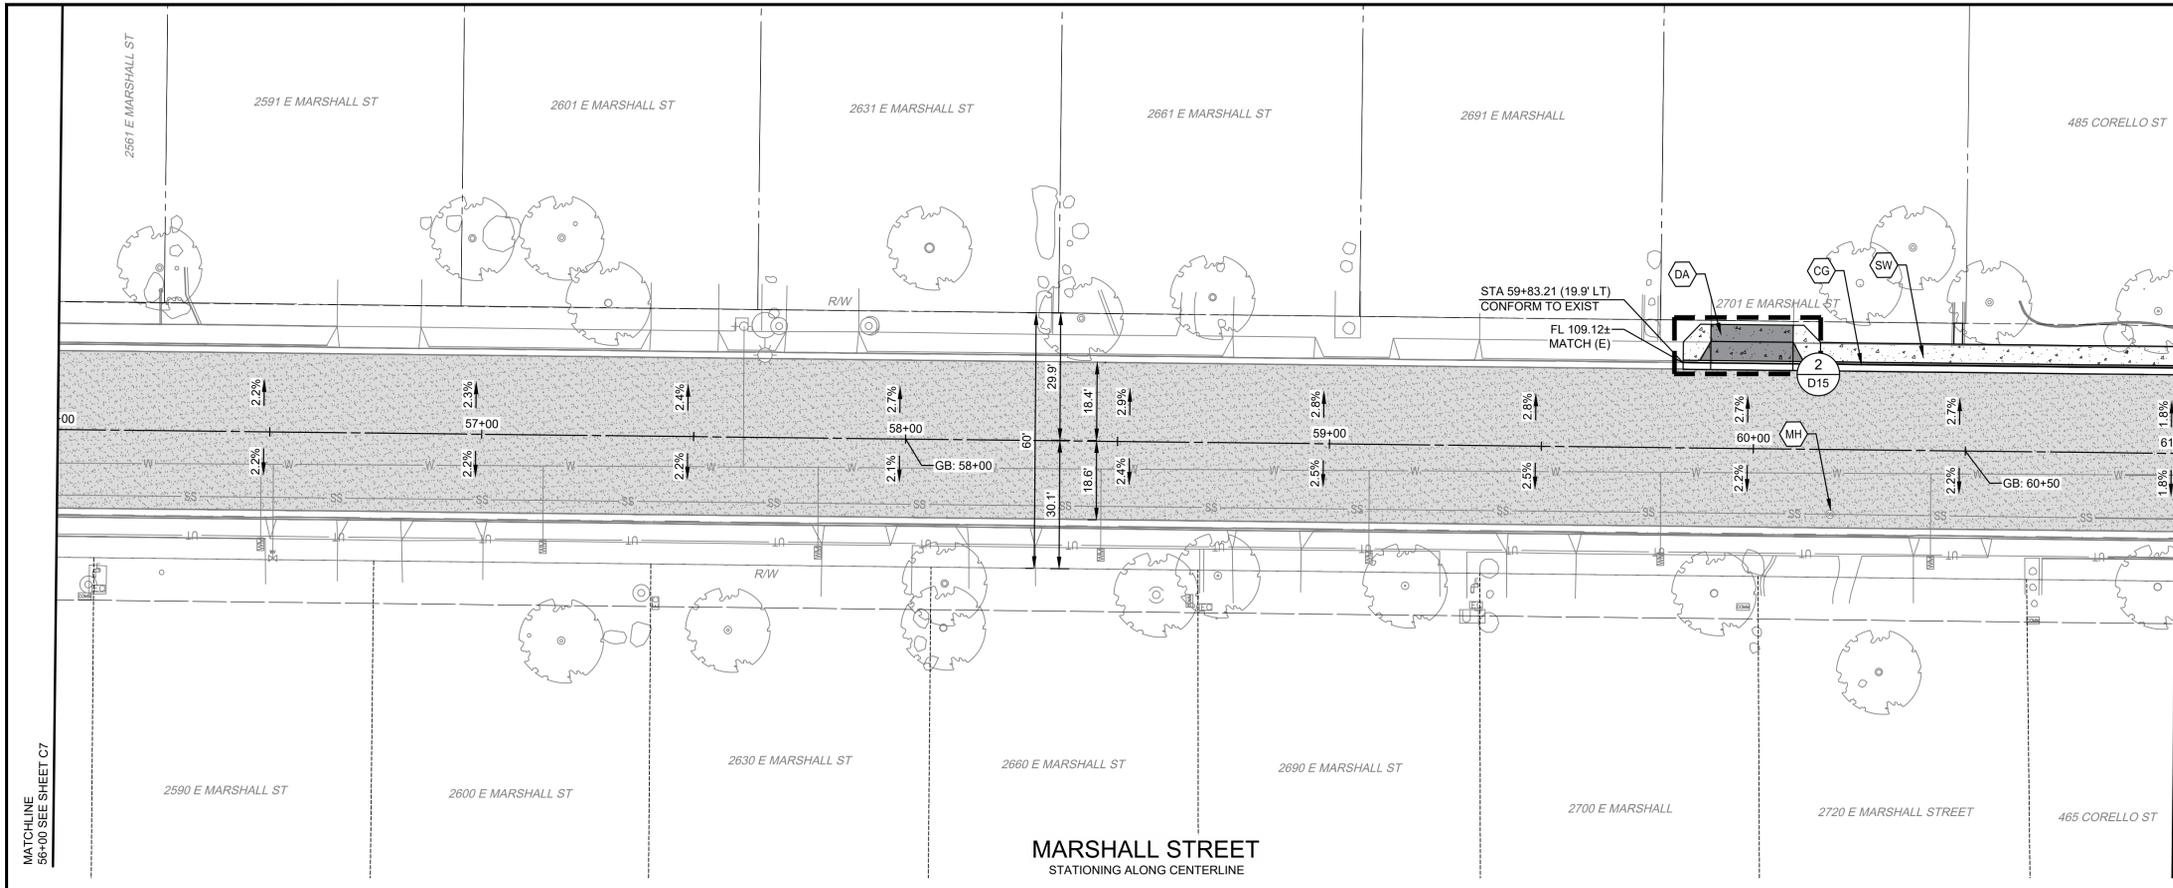

CONSTRUCTION CALLOUTS	
SYM	DESCRIPTION
AA	ALLEY APPROACH PER CITY OF TURLOCK STD DWG C-7
AG	ADJUST TO FINISHED GRADE
CGA	SAWCUT AND REMOVE (E) CURB AND GUTTER AND CONSTRUCT NEW CURB AND GUTTER PER CITY OF TURLOCK STD DWG C-1. DOWEL INTO EXISTING CURB AND GUTTER PER DETAIL 1, SHEET D5
CG	CONSTRUCT NEW CURB AND GUTTER PER CITY OF TURLOCK STD DWG C-1. DOWEL INTO EXISTING CURB AND GUTTER PER DETAIL 1, SHEET D5
CR	SAWCUT AND REMOVE (E) CURB RETURN, RAMPS, AND SIDEWALK AND CONSTRUCT NEW CURB RETURN, RAMP, AND SIDEWALK PER PROJECT SPECIFICATIONS AND SITE DETAILS
DA	RESIDENTIAL DRIVE APPROACH PER CITY OF TURLOCK STD DWG C-5
DA1	REMOVE AND REPLACE EXISTING DRIVE APPROACH TO MATCH AT EXISTING CONCRETE HINGE POINT PER CITY OF TURLOCK STD DWG C-5
DI	REMOVE AND REPLACE CATCH BASIN PER CITY OF TURLOCK STD SD-3 AND T-1
DOC	SAWCUT AND REMOVE (E) CURB AND GUTTER AND CONSTRUCT NEW DRIVE OVER CURB PER CITY OF TURLOCK PER DETAIL 3 ON SHEET D4. DOWEL INTO EXISTING CURB AND GUTTER PER DETAIL 1, SHEET D5
DW	DETECTABLE WARNING SURFACE PER CALTRANS STD DWG SHEET A88A
FH	CONSTRUCT FIRE HYDRANT PER CITY OF TURLOCK STD DWG W-1 AND T-1
MH	ADJUST MANHOLE TO FINISHED GRADE AFTER PAVING OPERATIONS PER DETAIL S-3
NDI	CONSTRUCT CATCH BASIN PER CITY OF TURLOCK STD SD-3 AND T-1
NMH	CONSTRUCT NEW MANHOLE PER CITY OF TURLOCK STD DWG S-3 AND T-1
PP	PROTECT IN PLACE
RC	RETAINING CURB
RDI	REMOVE DRAINAGE INLET
RL	REMOVE AND RELOCATE
SW	CONSTRUCT SIDEWALK PER CITY OF TURLOCK STD DWG C-3. PROVIDE 2' SIDEWALK TRANSITION WITHIN LIMITS SHOWN TO MATCH (E) ELEVATIONS. SLOPES WITHIN TRANSITION AREA SHALL NOT EXCEED 4.5% LONGITUDINALLY. DOWEL INTO EXISTING SIDEWALK PER DETAIL 1, SHEET D5. PROTECT (E) ROOF DRAINS IN PLACE OR REPLACE IN KIND
VG	CONSTRUCT VALLEY GUTTER PER CITY OF TURLOCK STD DWG C-1

LEGEND	
[Pattern]	FDR-C RECONSTRUCTION PER DETAIL 2 SHEET D5
[Pattern]	6.0" TYPE A HMA PAVEMENT PLUG OVER 6" CNS COMPACTED TO 95%
[Pattern]	3.5" MINIMUM THICK CONCRETE OVER 6" CNS COMPACTED TO 90%
[Pattern]	ALLEY/DRIVE APPROACH CONCRETE THICKNESS PER CITY OF TURLOCK STD DWG C-5, C-7 & C-8
[Pattern]	8.0" TYPE A HMA PAVEMENT OVER 6" CNS COMPACTED TO 95%

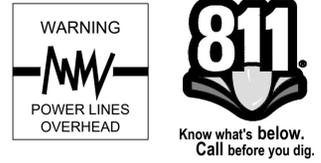- CONSTRUCTION NOTES**
- EXISTING DRIVEWAYS, CURB, AND GUTTER TO REMAIN UNLESS OTHERWISE NOTED ON THE PLANS.
  - STATION AND OFFSET ON CURB AND GUTTER REFERS TO A POINT ON THE FLOWLINE.
  - DETAILED RAMP AND DRIVE APPROACH GRADING IS PROVIDED ON SHEETS D7-D22.
  - PROTECT IN PLACE ALL (E) SIDEWALK DRAINS.
  - NOT ALL SEWER LATERALS ARE SHOWN ON THE PLANS.

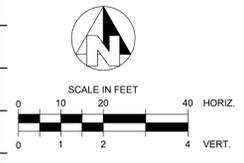

CITY OF TURLOCK  
MUNICIPAL SERVICES DEPARTMENT  
ROADS PROGRAM DIVISION  
156 S. BROADWAY, SUITE 150  
(209) 668-5520

**BID SET**  
1/22/2026

CITY OF TURLOCK  
ROADS PROGRAM CIP  
CITY PROJECT No. 23-068, PACKAGE 3  
STREET PLAN

**MARSHALL ST STA 56+00 - 61+00**

DESIGN ENGINEER:  
JEFF DORN  
LICENSE NO:  
76,749

DRAFTED BY: AR  
CHECKED BY: JD

DATE: JAN 2026  
JOB NO: 229224001  
PROJECT NO: 229224001  
PHASE: 3




ORIGINAL SCALE SHOWN IS ONE INCH. ADJUST SCALE FOR REDUCED OR ENLARGED PLANS.

SHEET **C8**  
11 OF 78

DATE SIGNED: [Signature]  
NO. [ ]  
REVISION [ ]  
BY [ ]  
DATE [ ]

PROVOST & PRITCHARD  
425 W FIR AVENUE  
TURLOCK, CA 95259  
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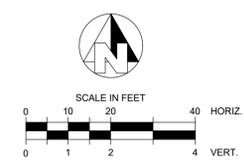
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CONSTRUCTION CALLOUTS	
SYM	DESCRIPTION
AA	ALLEY APPROACH PER CITY OF TURLOCK STD DWG C-7
AG	ADJUST TO FINISHED GRADE
CGA	SAWCUT AND REMOVE (E) CURB AND GUTTER AND CONSTRUCT NEW CURB AND GUTTER PER CITY OF TURLOCK STD DWG C-1. DOWEL INTO EXISTING CURB AND GUTTER PER DETAIL 1, SHEET D5
CG	CONSTRUCT NEW CURB AND GUTTER PER CITY OF TURLOCK STD DWG C-1. DOWEL INTO EXISTING CURB AND GUTTER PER DETAIL 1, SHEET D5
CR	SAWCUT AND REMOVE (E) CURB RETURN, RAMPS, AND SIDEWALK AND CONSTRUCT NEW CURB RETURN, RAMP, AND SIDEWALK PER PROJECT SPECIFICATIONS AND SITE DETAILS
DA	RESIDENTIAL DRIVE APPROACH PER CITY OF TURLOCK STD DWG C-5
DA1	REMOVE AND REPLACE EXISTING DRIVE APPROACH TO MATCH AT EXISTING CONCRETE HINGE POINT PER CITY OF TURLOCK STD DWG C-5
DI	REMOVE AND REPLACE CATCH BASIN PER CITY OF TURLOCK STD SD-3 AND T-1
DOC	SAWCUT AND REMOVE (E) CURB AND GUTTER AND CONSTRUCT NEW DRIVE OVER CURB PER CITY OF TURLOCK PER DETAIL 3 ON SHEET D4. DOWEL INTO EXISTING CURB AND GUTTER PER DETAIL 1, SHEET D5
DW	DETECTABLE WARNING SURFACE PER CALTRANS STD DWG SHEET A88A
FH	CONSTRUCT FIRE HYDRANT PER CITY OF TURLOCK STD DWG W-1 AND T-1
MH	ADJUST MANHOLE TO FINISHED GRADE AFTER PAVING OPERATIONS PER DETAIL S-3
NDI	CONSTRUCT CATCH BASIN PER CITY OF TURLOCK STD SD-3 AND T-1
NMH	CONSTRUCT NEW MANHOLE PER CITY OF TURLOCK STD DWG S-3 AND T-1
PP	PROTECT IN PLACE
RC	RETAINING CURB
RD	REMOVE DRAINAGE INLET
RL	REMOVE AND RELOCATE
SW	CONSTRUCT SIDEWALK PER CITY OF TURLOCK STD DWG C-3. PROVIDE 2' SIDEWALK TRANSITION WITHIN LIMITS SHOWN TO MATCH (E) ELEVATIONS. SLOPES WITHIN TRANSITION AREA SHALL NOT EXCEED 4.5% LONGITUDINALLY. DOWEL INTO EXISTING SIDEWALK PER DETAIL 1, SHEET D5. PROTECT (E) ROOF DRAINS IN PLACE OR REPLACE IN KIND
VG	CONSTRUCT VALLEY GUTTER PER CITY OF TURLOCK STD DWG C-1

LEGEND	
[Pattern]	FDR-C RECONSTRUCTION PER DETAIL 2 SHEET D5
[Pattern]	6.0" TYPE A HMA PAVEMENT PLUG OVER 6" CNS COMPACTED TO 95%
[Pattern]	3.5" MINIMUM THICK CONCRETE OVER 6" CNS COMPACTED TO 90%
[Pattern]	ALLEY/DRIVE APPROACH CONCRETE THICKNESS PER CITY OF TURLOCK STD DWG C-5, C-7 & C-8
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- CONSTRUCTION NOTES**
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  - STATION AND OFFSET ON CURB AND GUTTER REFERS TO A POINT ON THE FLOWLINE.
  - DETAILED RAMP AND DRIVE APPROACH GRADING IS PROVIDED ON SHEETS D7-D22.
  - PROTECT IN PLACE ALL (E) SIDEWALK DRAINS.
  - NOT ALL SEWER LATERALS ARE SHOWN ON THE PLANS.

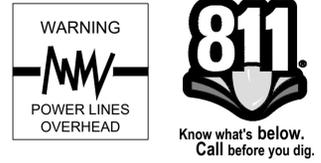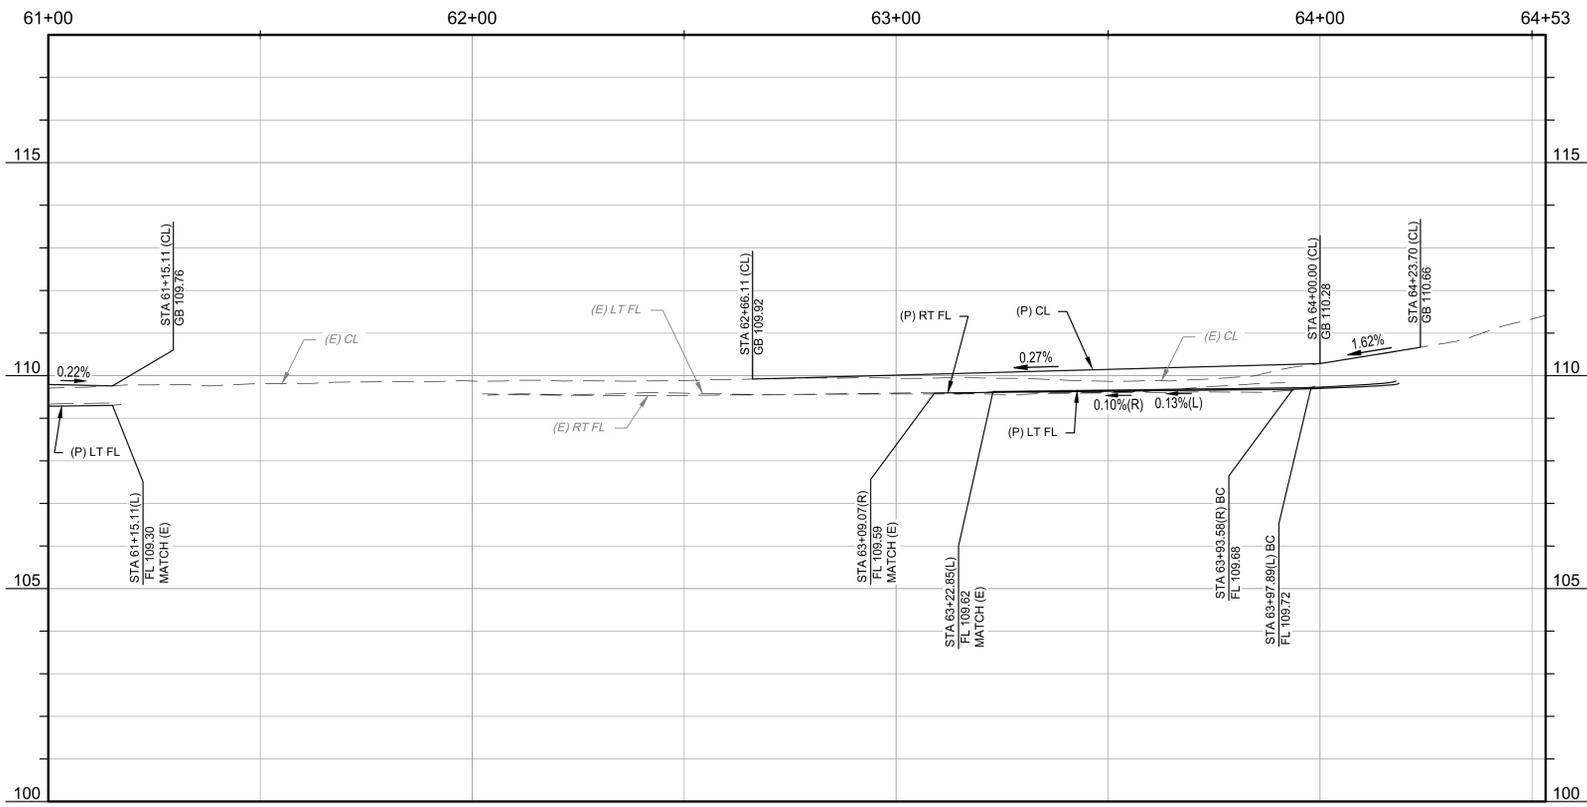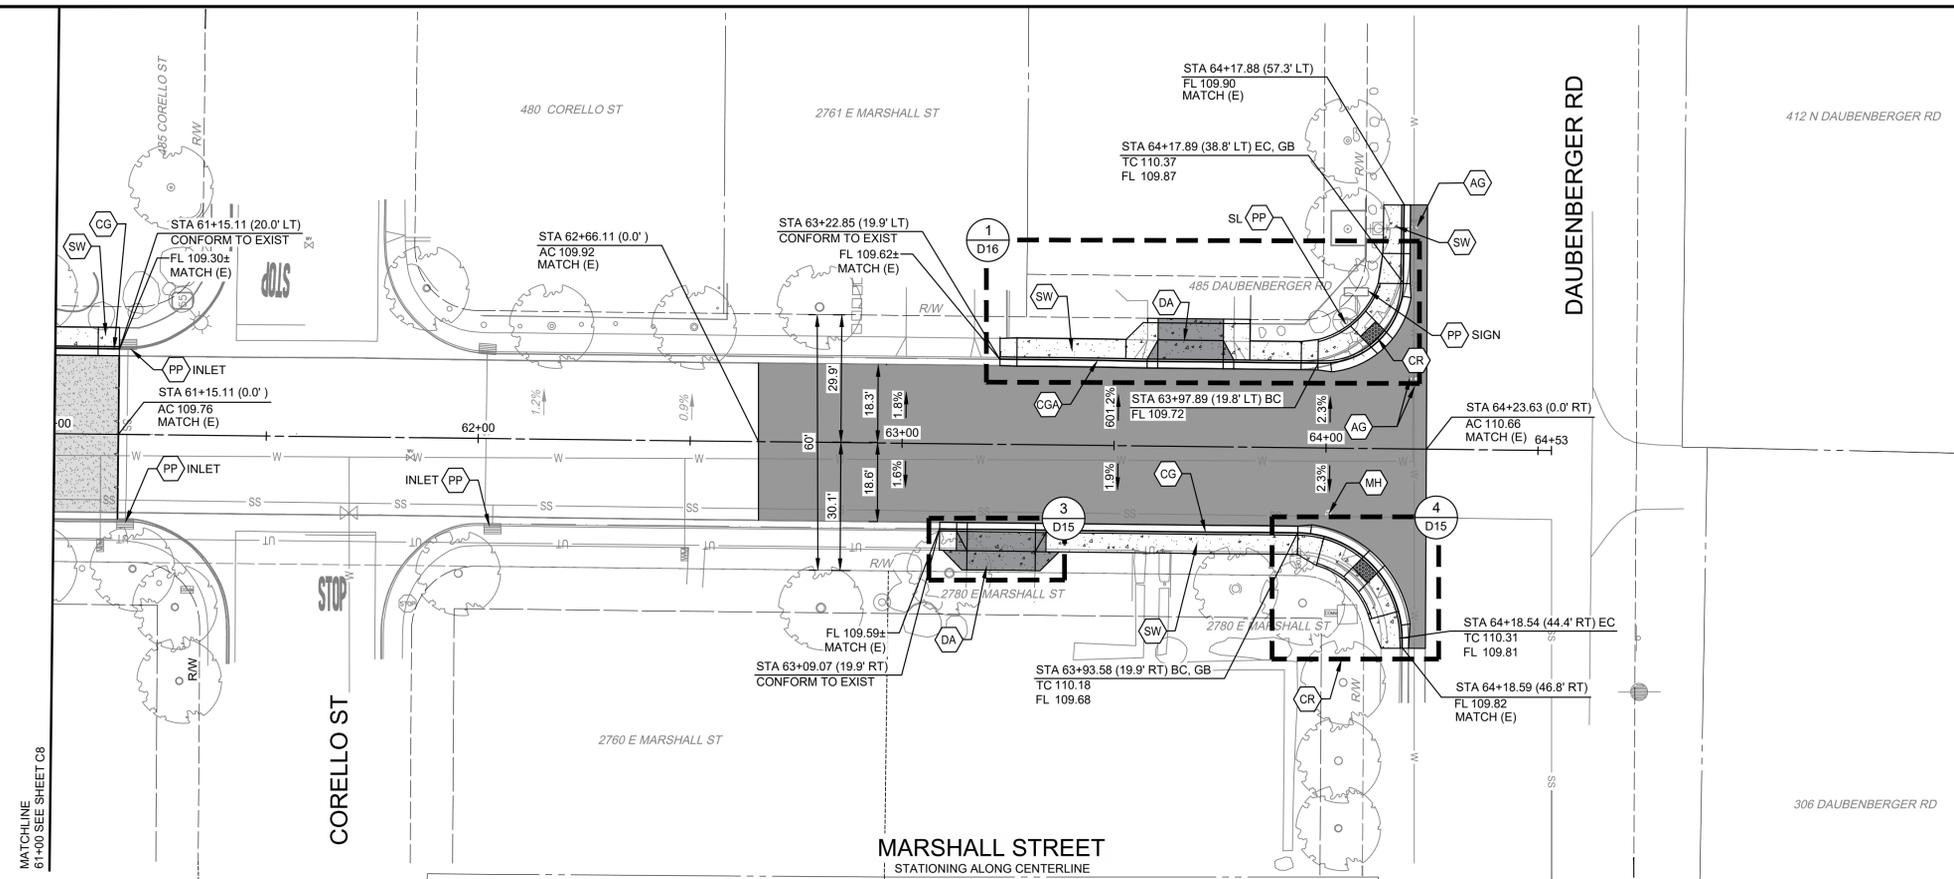

CITY OF TURLOCK  
MUNICIPAL SERVICES DEPARTMENT  
ROADS PROGRAM DIVISION  
156 S. BROADWAY, SUITE 150  
(209) 668-5520

**BID SET**  
1/22/2026

**CITY OF TURLOCK**  
ROADS PROGRAM CIP  
CITY PROJECT No. 23-068, PACKAGE 3  
STREET PLAN  
MARSHALL ST STA 61+00 - 64+53

DESIGN ENGINEER:  
JEFF DORN  
LICENSE NO:  
76,749



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CHECKED BY: JD

DATE: JAN 2026  
JOB NO: 229224001  
PROJECT NO: 229224001  
PHASE: 3


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SHEET **C9**  
12 OF 78

1/19/2026 9:01 AM G:\Turlock\_City of 229224001\2024 Road Rehab\300 CAD\343 Sheet\02\_Plans\_Maps\C8 MARSHALL ST STA 61+00 - 64+53.dwg - Annamare Fox

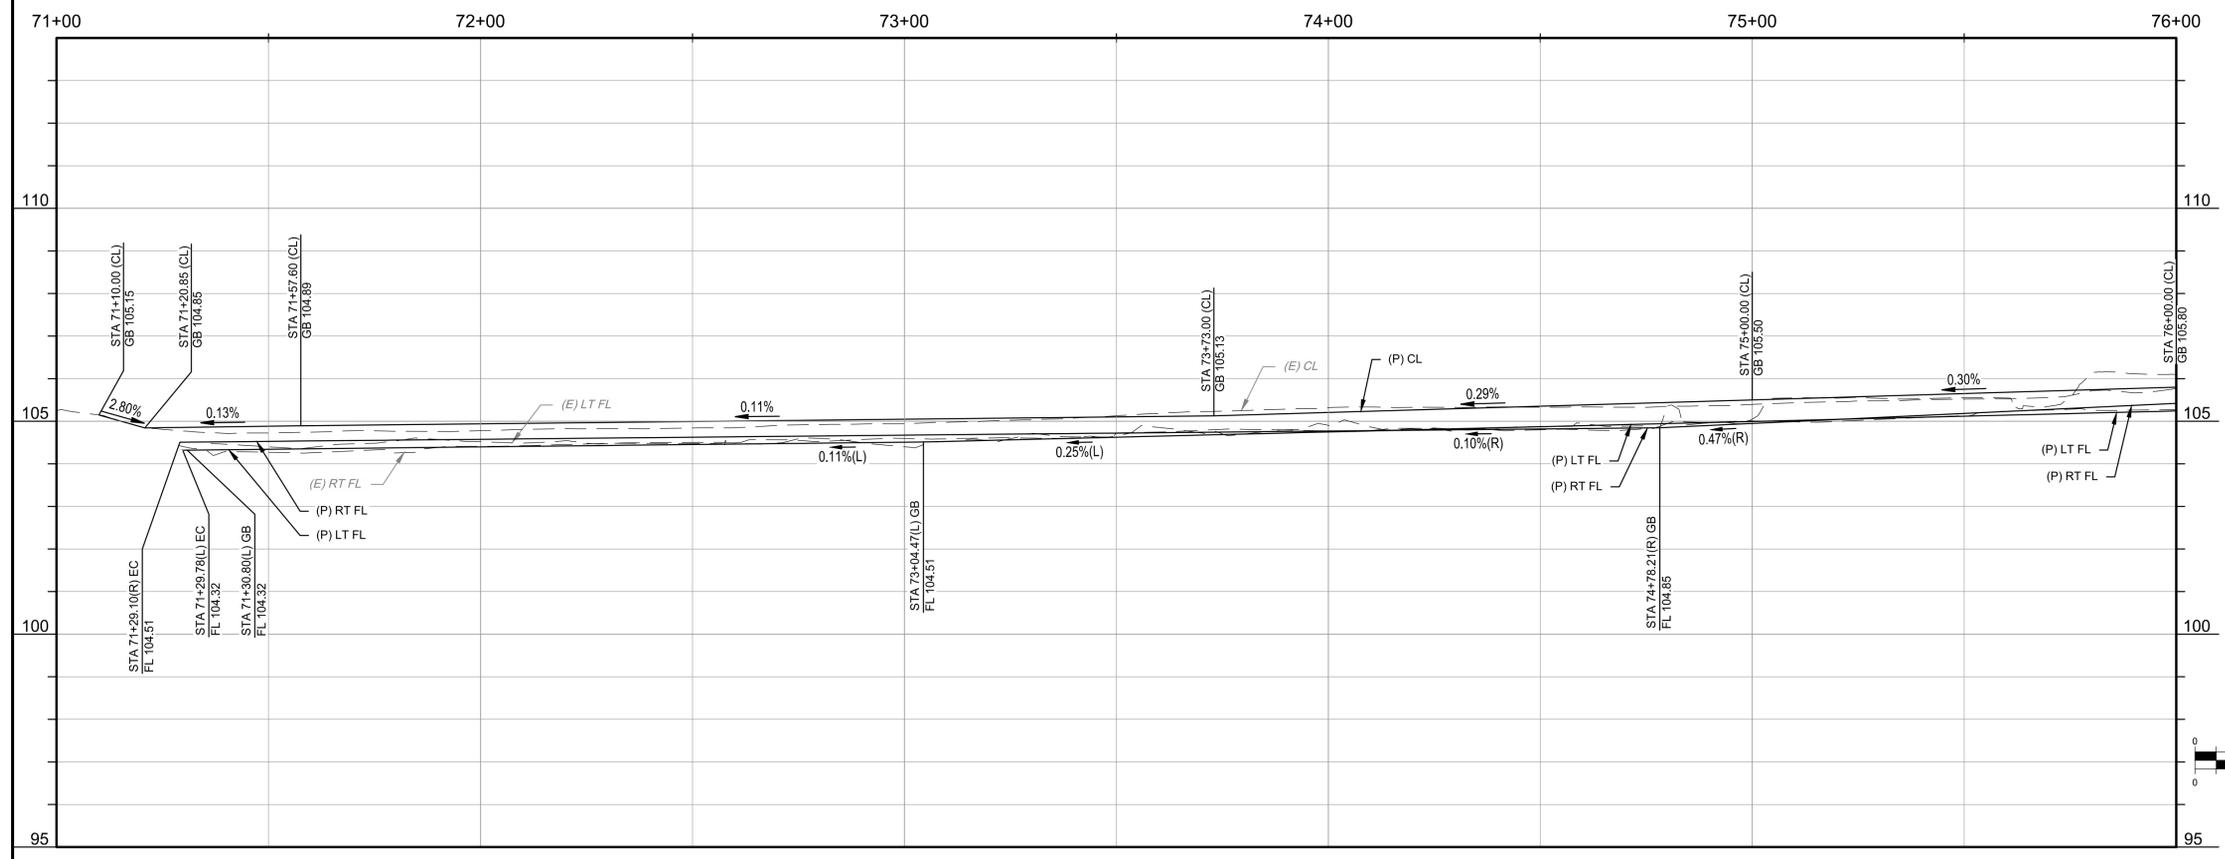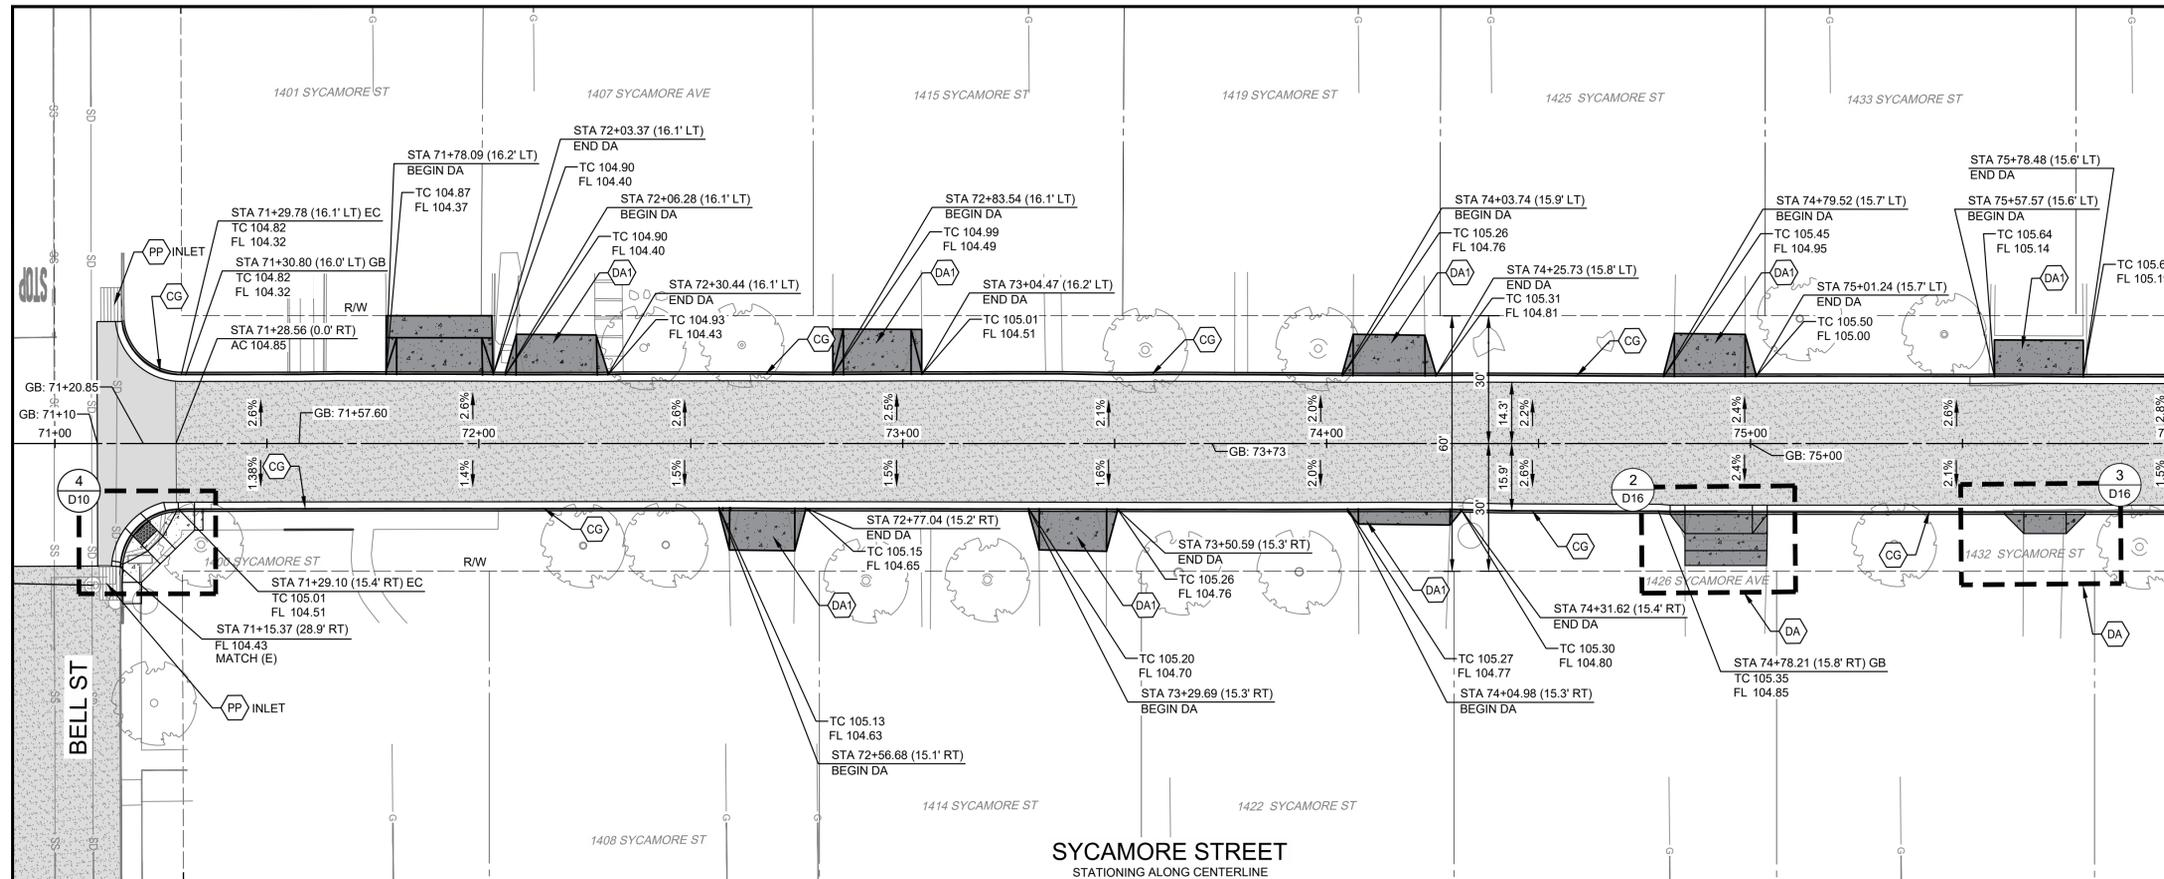


MATCHLINE  
76+00 SEE SHEET C11

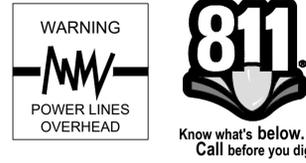

CONSTRUCTION CALLOUTS	
SYM	DESCRIPTION
AA	ALLEY APPROACH PER CITY OF TURLOCK STD DWG C-7
AG	ADJUST TO FINISHED GRADE
CGA	SAWCUT AND REMOVE (E) CURB AND GUTTER AND CONSTRUCT NEW CURB AND GUTTER PER CITY OF TURLOCK STD DWG C-1. DOWEL INTO EXISTING CURB AND GUTTER PER DETAIL 1, SHEET D5
CG	CONSTRUCT NEW CURB AND GUTTER PER CITY OF TURLOCK STD DWG C-1. DOWEL INTO EXISTING CURB AND GUTTER PER DETAIL 1, SHEET D5
CR	SAWCUT AND REMOVE (E) CURB RETURN, RAMPS, AND SIDEWALK AND CONSTRUCT NEW CURB RETURN, RAMP, AND SIDEWALK PER PROJECT SPECIFICATIONS AND SITE DETAILS
DA	RESIDENTIAL DRIVE APPROACH PER CITY OF TURLOCK STD DWG C-5
DA1	REMOVE AND REPLACE EXISTING DRIVE APPROACH TO MATCH AT EXISTING CONCRETE HINGE POINT PER CITY OF TURLOCK STD DWG C-5
DI	REMOVE AND REPLACE CATCH BASIN PER CITY OF TURLOCK STD DWG C-5
DOC	SAWCUT AND REMOVE (E) CURB AND GUTTER AND CONSTRUCT NEW DRIVE OVER CURB PER CITY OF TURLOCK PER DETAIL 3 ON SHEET D4. DOWEL INTO EXISTING CURB AND GUTTER PER DETAIL 1, SHEET D5
DW	DETECTABLE WARNING SURFACE PER CALTRANS STD DWG SHEET A88A
FH	CONSTRUCT FIRE HYDRANT PER CITY OF TURLOCK STD DWG W-1 AND T-1
MH	ADJUST MANHOLE TO FINISHED GRADE AFTER PAVING OPERATIONS PER DETAIL S-3
NDI	CONSTRUCT CATCH BASIN PER CITY OF TURLOCK STD SD-3 AND T-1
NMH	CONSTRUCT NEW MANHOLE PER CITY OF TURLOCK STD DWG S-3 AND T-1
PP	PROTECT IN PLACE
RC	RETAINING CURB
RD1	REMOVE DRAINAGE INLET
RL	REMOVE AND RELOCATE
SW	CONSTRUCT SIDEWALK PER CITY OF TURLOCK STD DWG C-3. PROVIDE 2' SIDEWALK TRANSITION WITHIN LIMITS SHOWN TO MATCH (E) ELEVATIONS. SLOPES WITHIN TRANSITION AREA SHALL NOT EXCEED 4.5% LONGITUDINALLY. DOWEL INTO EXISTING SIDEWALK PER DETAIL 1, SHEET D5. PROTECT (E) ROOF DRAINS IN PLACE OR REPLACE IN KIND
VG	CONSTRUCT VALLEY GUTTER PER CITY OF TURLOCK STD DWG C-1

LEGEND	
	FDR-C RECONSTRUCTION PER DETAIL 2 SHEET D5
	6.0" TYPE A HMA PAVEMENT PLUG OVER
	6" CNS COMPACTED TO 95%
	3.5" MINIMUM THICK CONCRETE OVER 6" CNS COMPACTED TO 90%
	ALLEY/DRIVE APPROACH CONCRETE THICKNESS PER CITY OF TURLOCK STD DWG C-5, C-7 & C-8
	8.0" TYPE A HMA PAVEMENT OVER 6" CNS COMPACTED TO 95%

- CONSTRUCTION NOTES**
- EXISTING DRIVEWAYS, CURB, AND GUTTER TO REMAIN UNLESS OTHERWISE NOTED ON THE PLANS.
  - STATION AND OFFSET ON CURB AND GUTTER REFERS TO A POINT ON THE FLOWLINE.
  - DETAILED RAMP AND DRIVE APPROACH GRADING IS PROVIDED ON SHEETS D7-D22.
  - PROTECT IN PLACE ALL (E) SIDEWALK DRAINS.
  - NOT ALL SEWER LATERALS ARE SHOWN ON THE PLANS.

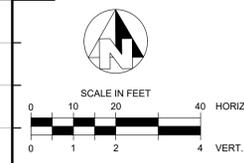

CITY OF TURLOCK  
MUNICIPAL SERVICES DEPARTMENT  
ROADS PROGRAM DIVISION  
156 S. BROADWAY, SUITE 150  
(209) 668-5520

**BID SET**  
1/22/2026

**CITY OF TURLOCK**  
ROADS PROGRAM CIP  
CITY PROJECT No. 23-068, PACKAGE 3  
STREET PLAN  
SYCAMORE ST STA 71+00 - 76+00

**PROVOST & PRITCHARD**  
425 W. FIR AVENUE  
TURLOCK, CA 95259  
PHONE (209) 449-2700  
FAX (209) 449-2719  
www.provostandpritchard.com

DESIGN ENGINEER:  
JEFF DORN  
LICENSE NO:  
76,749

DRAFTED BY: AR  
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DATE: JAN 2026  
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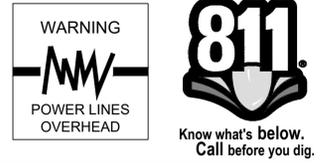
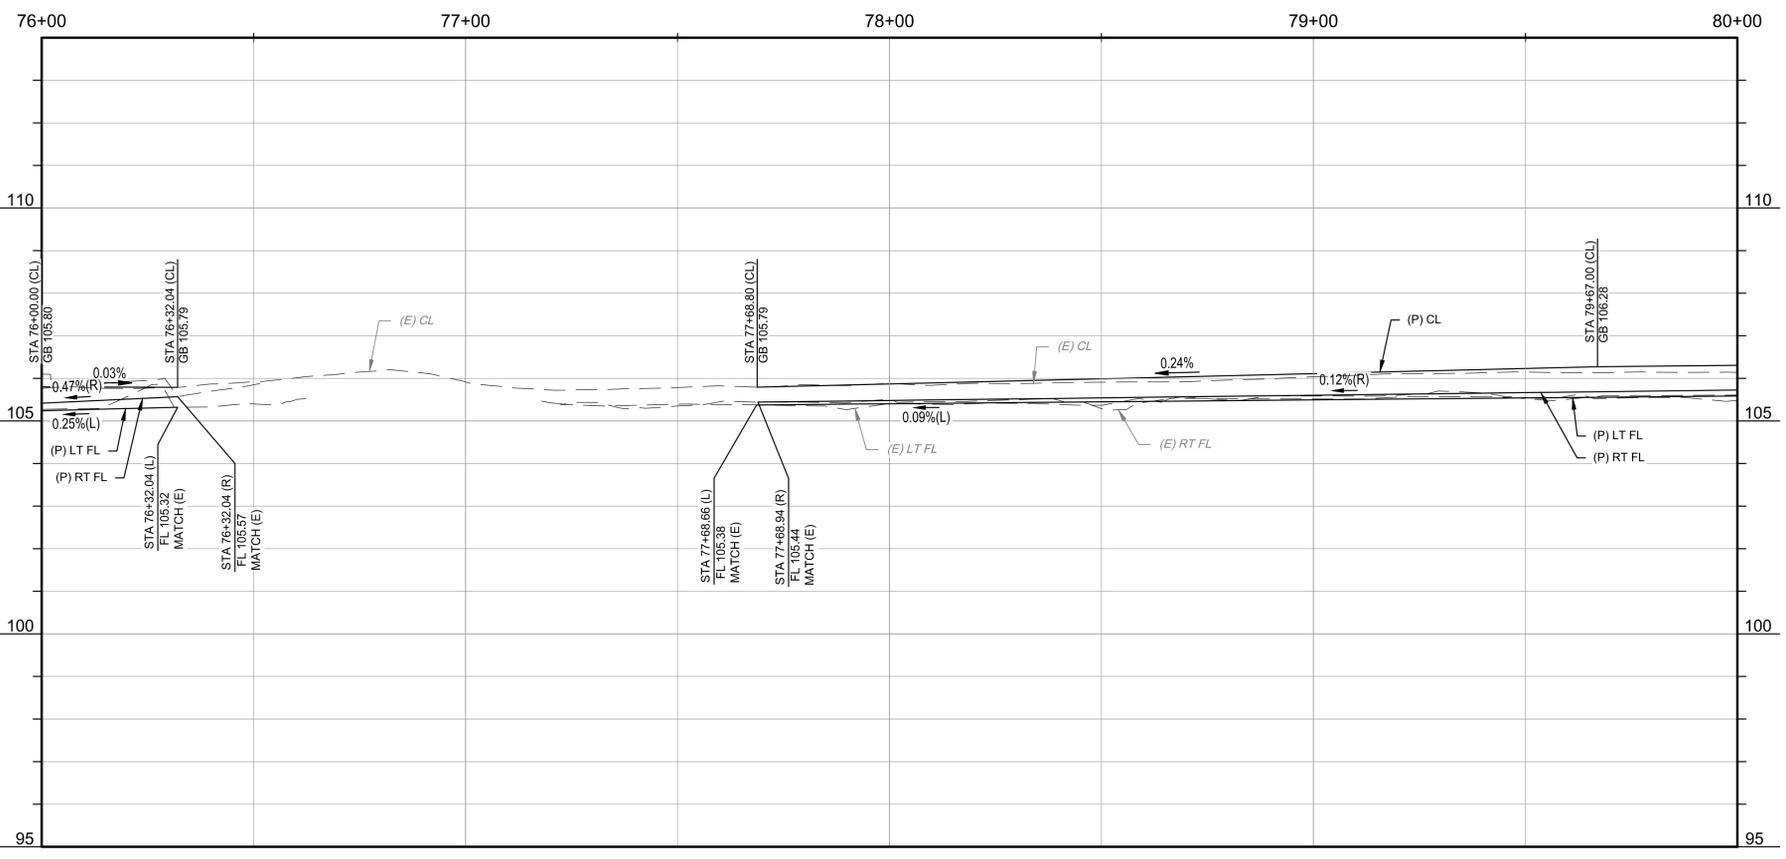
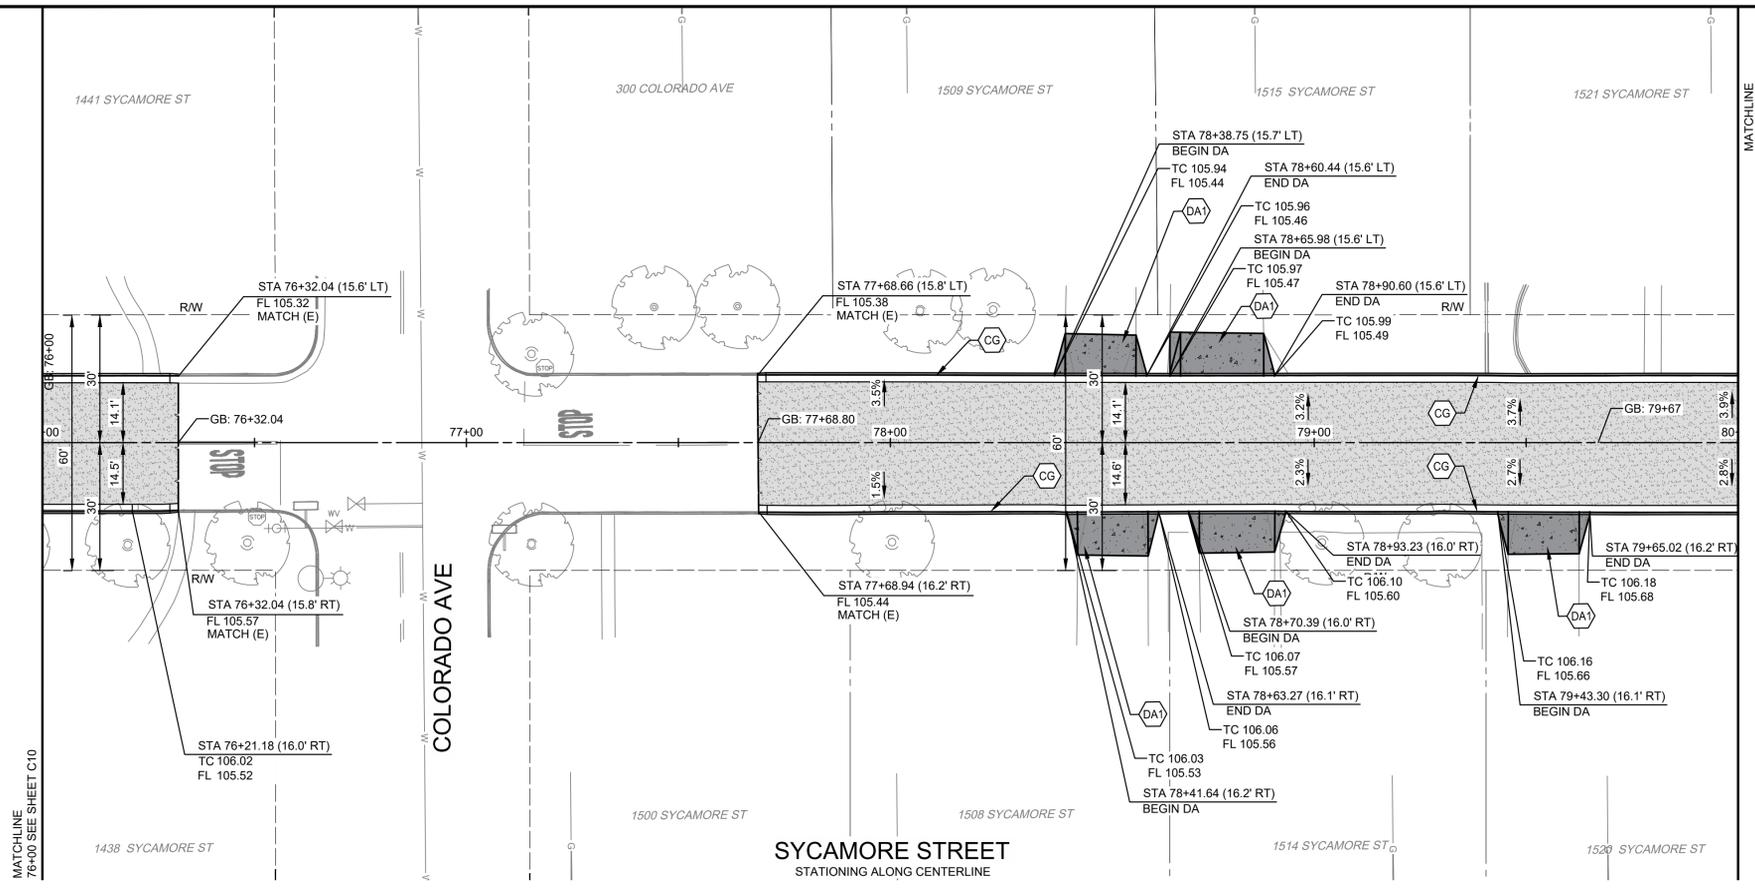
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ORIGINAL SCALE SHOWN IS ONE INCH. ADJUST SCALE FOR REDUCED OR ENLARGED PLANS.

SHEET **C10**  
13 OF 78

DATE SIGNED: [Signature]  
NO. [ ]  
BY: [ ]  
REVISION: [ ]

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CONSTRUCTION CALLOUTS	
SYM	DESCRIPTION
AA	ALLEY APPROACH PER CITY OF TURLOCK STD DWG C-7
AG	ADJUST TO FINISHED GRADE
CGA	SAWCUT AND REMOVE (E) CURB AND GUTTER AND CONSTRUCT NEW CURB AND GUTTER PER CITY OF TURLOCK STD DWG C-1. DOWEL INTO EXISTING CURB AND GUTTER PER DETAIL 1, SHEET D5
CG	CONSTRUCT NEW CURB AND GUTTER PER CITY OF TURLOCK STD DWG C-1. DOWEL INTO EXISTING CURB AND GUTTER PER DETAIL 1, SHEET D5
CR	SAWCUT AND REMOVE (E) CURB RETURN, RAMPS, AND SIDEWALK AND CONSTRUCT NEW CURB RETURN, RAMP, AND SIDEWALK PER PROJECT SPECIFICATIONS AND SITE DETAILS
DA	RESIDENTIAL DRIVE APPROACH PER CITY OF TURLOCK STD DWG C-5
DA1	REMOVE AND REPLACE EXISTING DRIVE APPROACH TO MATCH AT EXISTING CONCRETE HINGE POINT PER CITY OF TURLOCK STD DWG C-5
DI	REMOVE AND REPLACE CATCH BASIN PER CITY OF TURLOCK STD SD-3 AND T-1
DOC	SAWCUT AND REMOVE (E) CURB AND GUTTER AND CONSTRUCT NEW DRIVE OVER CURB PER CITY OF TURLOCK PER DETAIL 3 ON SHEET D4. DOWEL INTO EXISTING CURB AND GUTTER PER DETAIL 1, SHEET D5
DW	DETECTABLE WARNING SURFACE PER CALTRANS STD DWG SHEET A88A
FH	CONSTRUCT FIRE HYDRANT PER CITY OF TURLOCK STD DWG W-1 AND T-1
MH	ADJUST MANHOLE TO FINISHED GRADE AFTER PAVING OPERATIONS PER DETAIL S-3
NDI	CONSTRUCT CATCH BASIN PER CITY OF TURLOCK STD SD-3 AND T-1
NMH	CONSTRUCT NEW MANHOLE PER CITY OF TURLOCK STD DWG S-3 AND T-1
PP	PROTECT IN PLACE
RC	RETAINING CURB
RDI	REMOVE DRAINAGE INLET
RL	REMOVE AND RELOCATE
SW	CONSTRUCT SIDEWALK PER CITY OF TURLOCK STD DWG C-3. PROVIDE 2' SIDEWALK TRANSITION WITHIN LIMITS SHOWN TO MATCH (E) ELEVATIONS. SLOPES WITHIN TRANSITION AREA SHALL NOT EXCEED 4.5% LONGITUDINALLY. DOWEL INTO EXISTING SIDEWALK PER DETAIL 1, SHEET D5. PROTECT (E) ROOF DRAINS IN PLACE OR REPLACE IN KIND
VG	CONSTRUCT VALLEY GUTTER PER CITY OF TURLOCK STD DWG C-1

- LEGEND**
- FDR-C RECONSTRUCTION PER DETAIL 2 SHEET D5
  - 6.0" TYPE A HMA PAVEMENT PLUG OVER 6" CNS COMPACTED TO 95%
  - 3.5" MINIMUM THICK CONCRETE OVER 6" CNS COMPACTED TO 90%
  - ALLEY/DRIVE APPROACH CONCRETE THICKNESS PER CITY OF TURLOCK STD DWG C-5, C-7 & C-8
  - 8.0" TYPE A HMA PAVEMENT OVER 6" CNS COMPACTED TO 95%

- CONSTRUCTION NOTES**
1. EXISTING DRIVEWAYS, CURB, AND GUTTER TO REMAIN UNLESS OTHERWISE NOTED ON THE PLANS.
  2. STATION AND OFFSET ON CURB AND GUTTER REFERS TO A POINT ON THE FLOWLINE.
  3. DETAILED RAMP AND DRIVE APPROACH GRADING IS PROVIDED ON SHEETS D7-D22.
  4. PROTECT IN PLACE ALL (E) SIDEWALK DRAINS.
  5. NOT ALL SEWER LATERALS ARE SHOWN ON THE PLANS.

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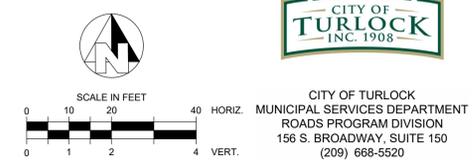
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1/22/2026

	DATE SIGNED: _____ NO. _____ REVISION _____ BY _____ DATE _____
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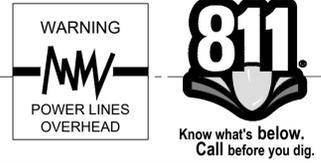
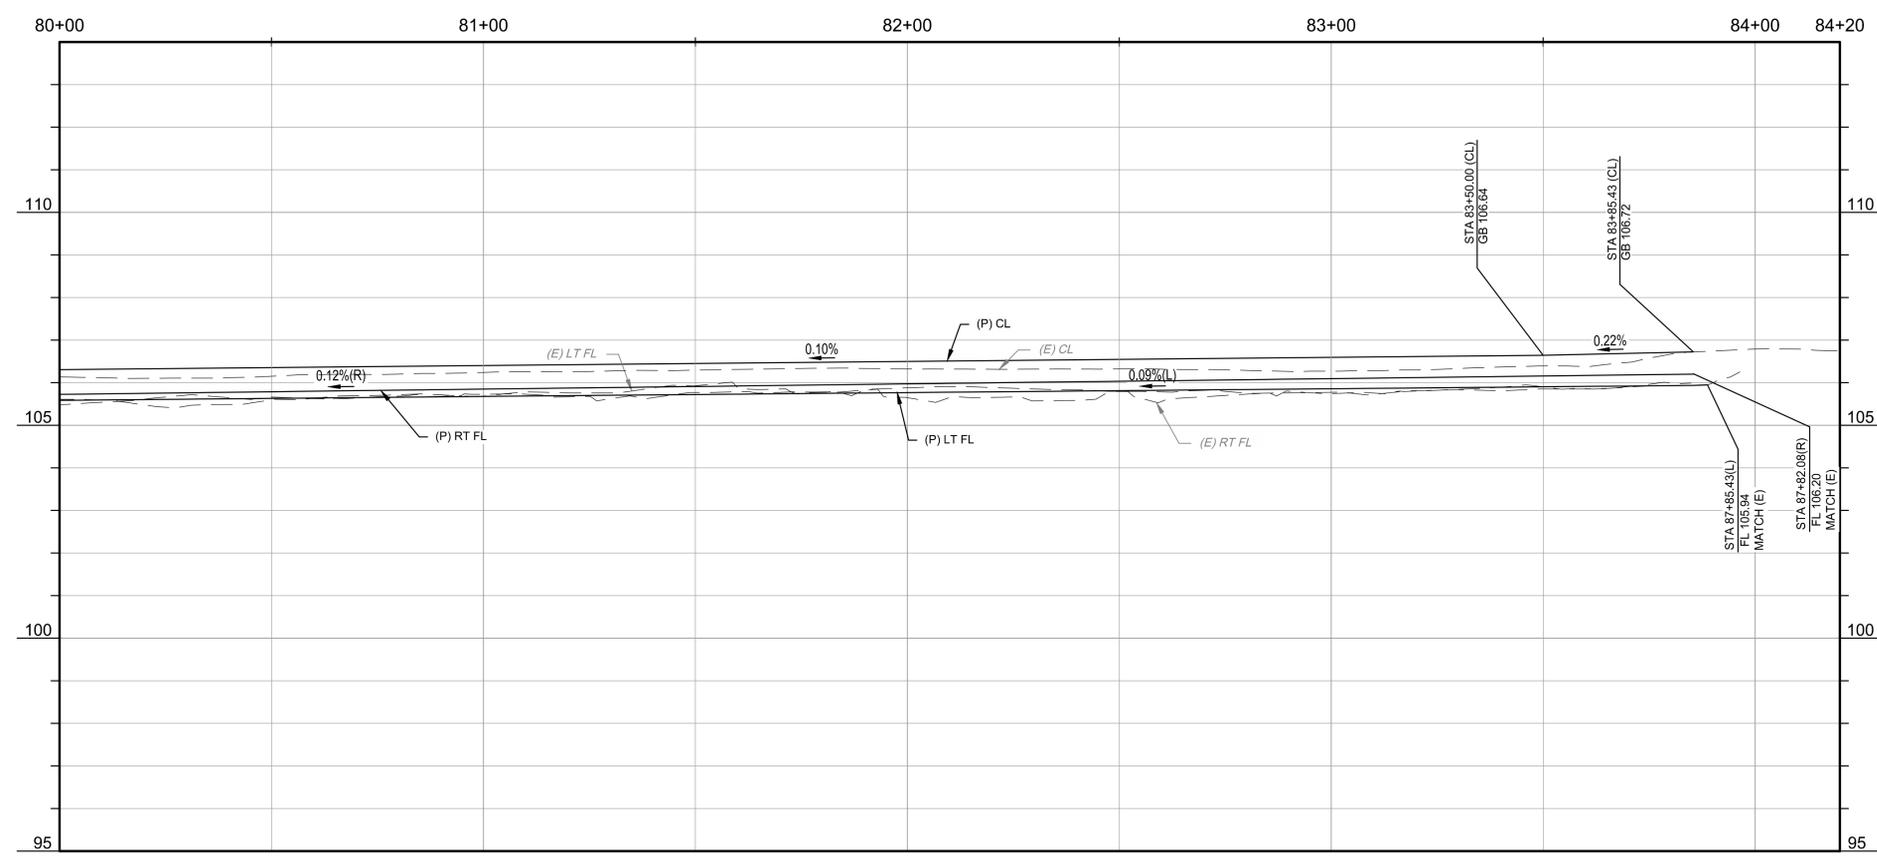
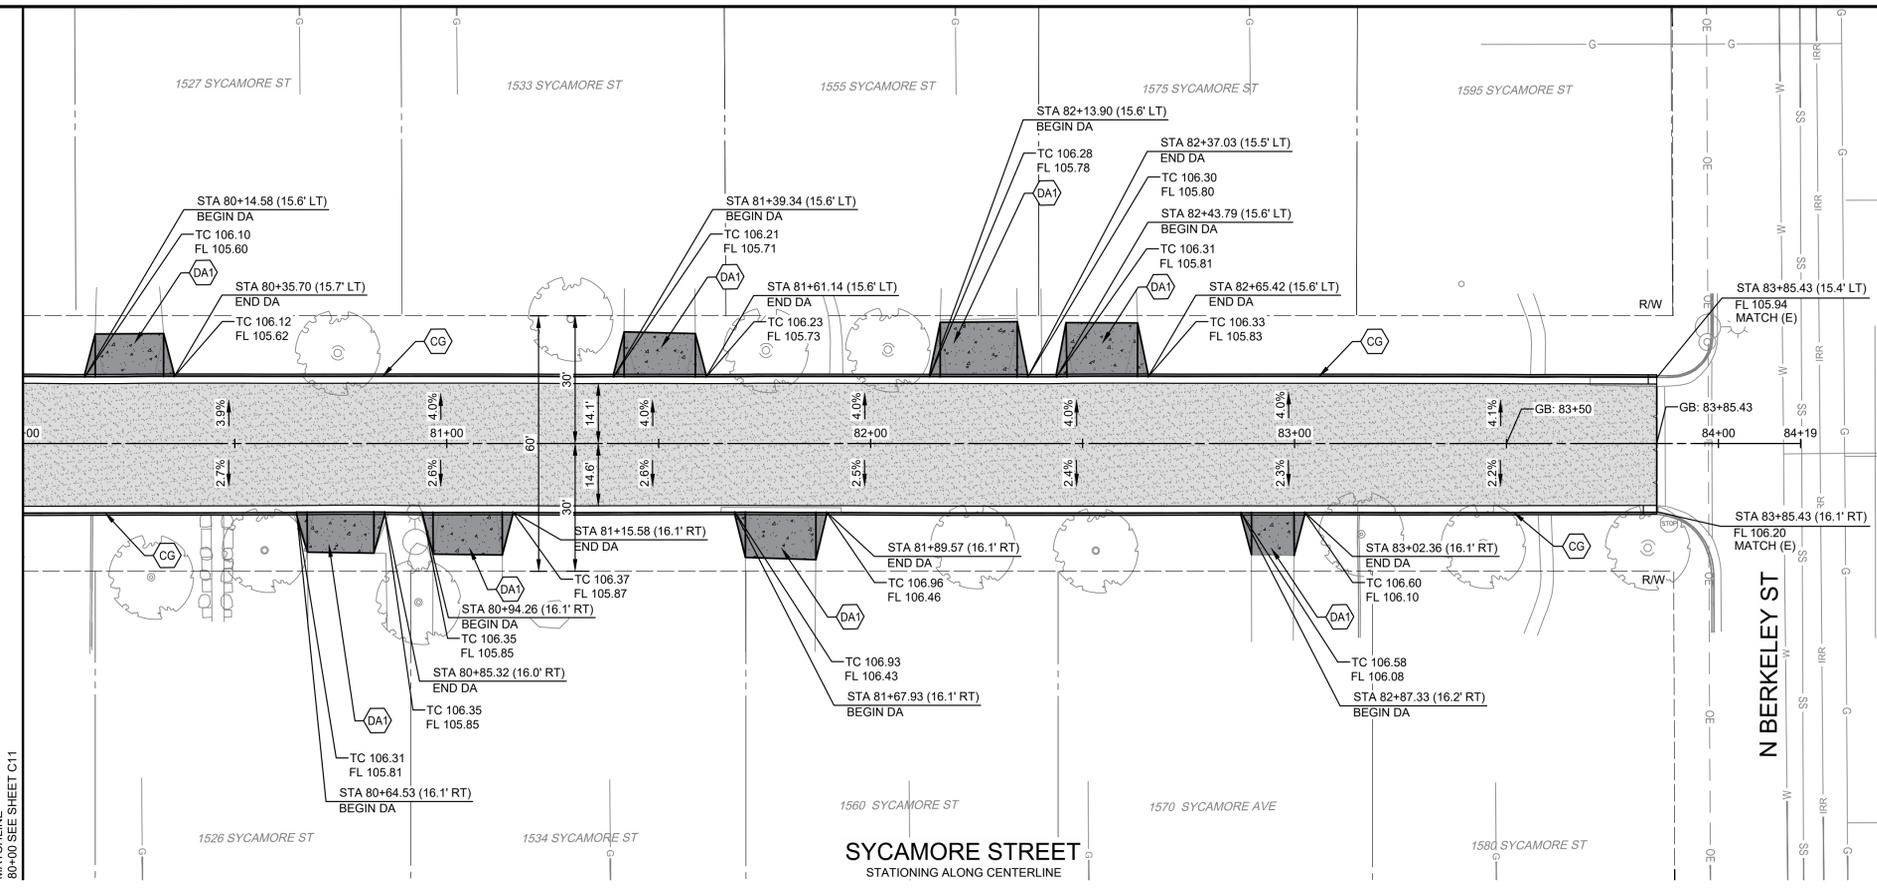
CITY OF TURLOCK  
 ROADS PROGRAM CIP  
 CITY PROJECT No. 23-068, PACKAGE 3  
 STREET PLAN  
 SYCAMORE ST STA 76+00 - 80+00

**PROVOST & PRITCHARD**  
 425 W. FIR AVENUE  
 TURLOCK, CA 95259  
 PHONE (559) 449-2700  
 FAX (559) 449-2715  
 www.provostandpritchard.com

DESIGN ENGINEER: JEFF DORN	
LICENSE NO: 76,749	
DRAFTED BY: AR	CHECKED BY: JD
DATE: JAN 2026	
JOB NO: 229224001	
PROJECT NO: 229224001	
PHASE: 3	
ORIGINAL SCALE SHOWN IS ONE INCH. ADJUST SCALE FOR REDUCED OR ENLARGED PLANS.	
SHEET <b>C11</b>	
14 OF 78	



CITY OF TURLOCK  
 MUNICIPAL SERVICES DEPARTMENT  
 ROADS PROGRAM DIVISION  
 156 S. BROADWAY, SUITE 150  
 (209) 668-5520




SYM	DESCRIPTION
AA	ALLEY APPROACH PER CITY OF TURLOCK STD DWG C-7
AG	ADJUST TO FINISHED GRADE
CGA	SAWCUT AND REMOVE (E) CURB AND GUTTER AND CONSTRUCT NEW CURB AND GUTTER PER CITY OF TURLOCK STD DWG C-1. DOWEL INTO EXISTING CURB AND GUTTER PER DETAIL 1, SHEET D5
CG	CONSTRUCT NEW CURB AND GUTTER PER CITY OF TURLOCK STD DWG C-1. DOWEL INTO EXISTING CURB AND GUTTER PER DETAIL 1, SHEET D5
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DA1	REMOVE AND REPLACE EXISTING DRIVE APPROACH TO MATCH AT EXISTING CONCRETE HINGE POINT PER CITY OF TURLOCK STD DWG C-5
DI	REMOVE AND REPLACE CATCH BASIN PER CITY OF TURLOCK STD SD-3 AND T-1
DOC	SAWCUT AND REMOVE (E) CURB AND GUTTER AND CONSTRUCT NEW DRIVE OVER CURB PER CITY OF TURLOCK PER DETAIL 3 ON SHEET D4. DOWEL INTO EXISTING CURB AND GUTTER PER DETAIL 1, SHEET D5
DW	DETECTABLE WARNING SURFACE PER CALTRANS STD DWG SHEET A88A
FH	CONSTRUCT FIRE HYDRANT PER CITY OF TURLOCK STD DWG W-1 AND T-1
MH	ADJUST MANHOLE TO FINISHED GRADE AFTER PAVING OPERATIONS PER DETAIL S-3
NDI	CONSTRUCT CATCH BASIN PER CITY OF TURLOCK STD SD-3 AND T-1
NMH	CONSTRUCT NEW MANHOLE PER CITY OF TURLOCK STD DWG S-3 AND T-1
PP	PROTECT IN PLACE
RC	RETAINING CURB
RDI	REMOVE DRAINAGE INLET
RL	REMOVE AND RELOCATE
SW	CONSTRUCT SIDEWALK PER CITY OF TURLOCK STD DWG C-3. PROVIDE 2' SIDEWALK TRANSITION WITHIN LIMITS SHOWN TO MATCH (E) ELEVATIONS. SLOPES WITHIN TRANSITION AREA SHALL NOT EXCEED 4.5% LONGITUDINALLY. DOWEL INTO EXISTING SIDEWALK PER DETAIL 1, SHEET D5. PROTECT (E) ROOF DRAINS IN PLACE OR REPLACE IN KIND
VG	CONSTRUCT VALLEY GUTTER PER CITY OF TURLOCK STD DWG C-1

- LEGEND**
- FDR-C RECONSTRUCTION PER DETAIL 2 SHEET D5
  - 6.0" TYPE A HMA PAVEMENT PLUG OVER 6" CNS COMPACTED TO 95%
  - 3.5" MINIMUM THICK CONCRETE OVER 6" CNS COMPACTED TO 90%
  - ALLEY/DRIVE APPROACH CONCRETE THICKNESS PER CITY OF TURLOCK STD DWG C-5, C-7 & C-8
  - 8.0" TYPE A HMA PAVEMENT OVER 6" CNS COMPACTED TO 95%

- CONSTRUCTION NOTES**
- EXISTING DRIVEWAYS, CURB, AND GUTTER TO REMAIN UNLESS OTHERWISE NOTED ON THE PLANS.
  - STATION AND OFFSET ON CURB AND GUTTER REFERS TO A POINT ON THE FLOWLINE.
  - DETAILED RAMP AND DRIVE APPROACH GRADING IS PROVIDED ON SHEETS D7-D22.
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  - NOT ALL SEWER LATERALS ARE SHOWN ON THE PLANS.

**BID SET**  
1/22/2026

NO.	REVISION	BY	DATE

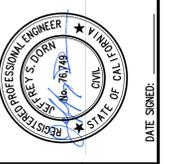

CITY OF TURLOCK  
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CITY PROJECT No. 23-068, PACKAGE 3  
STREET PLAN  
SYCAMORE ST STA 80+00 - 84+20

**PROVOST & PRITCHARD**  
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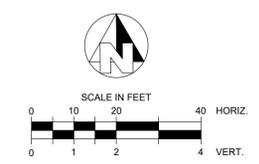
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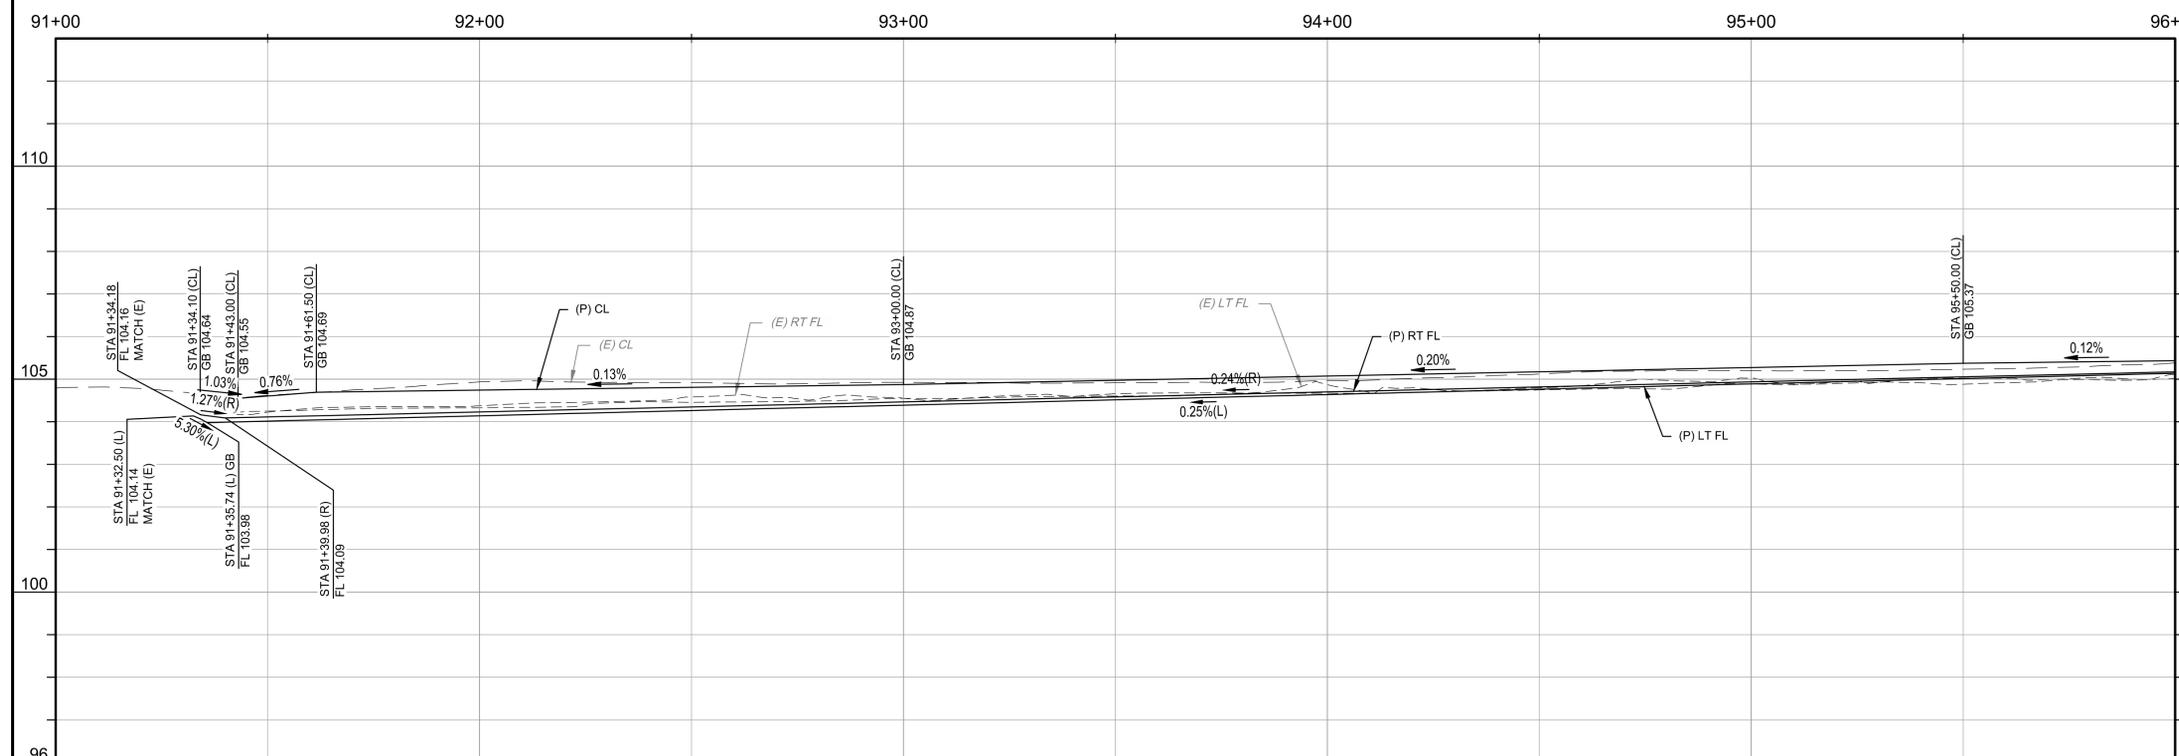
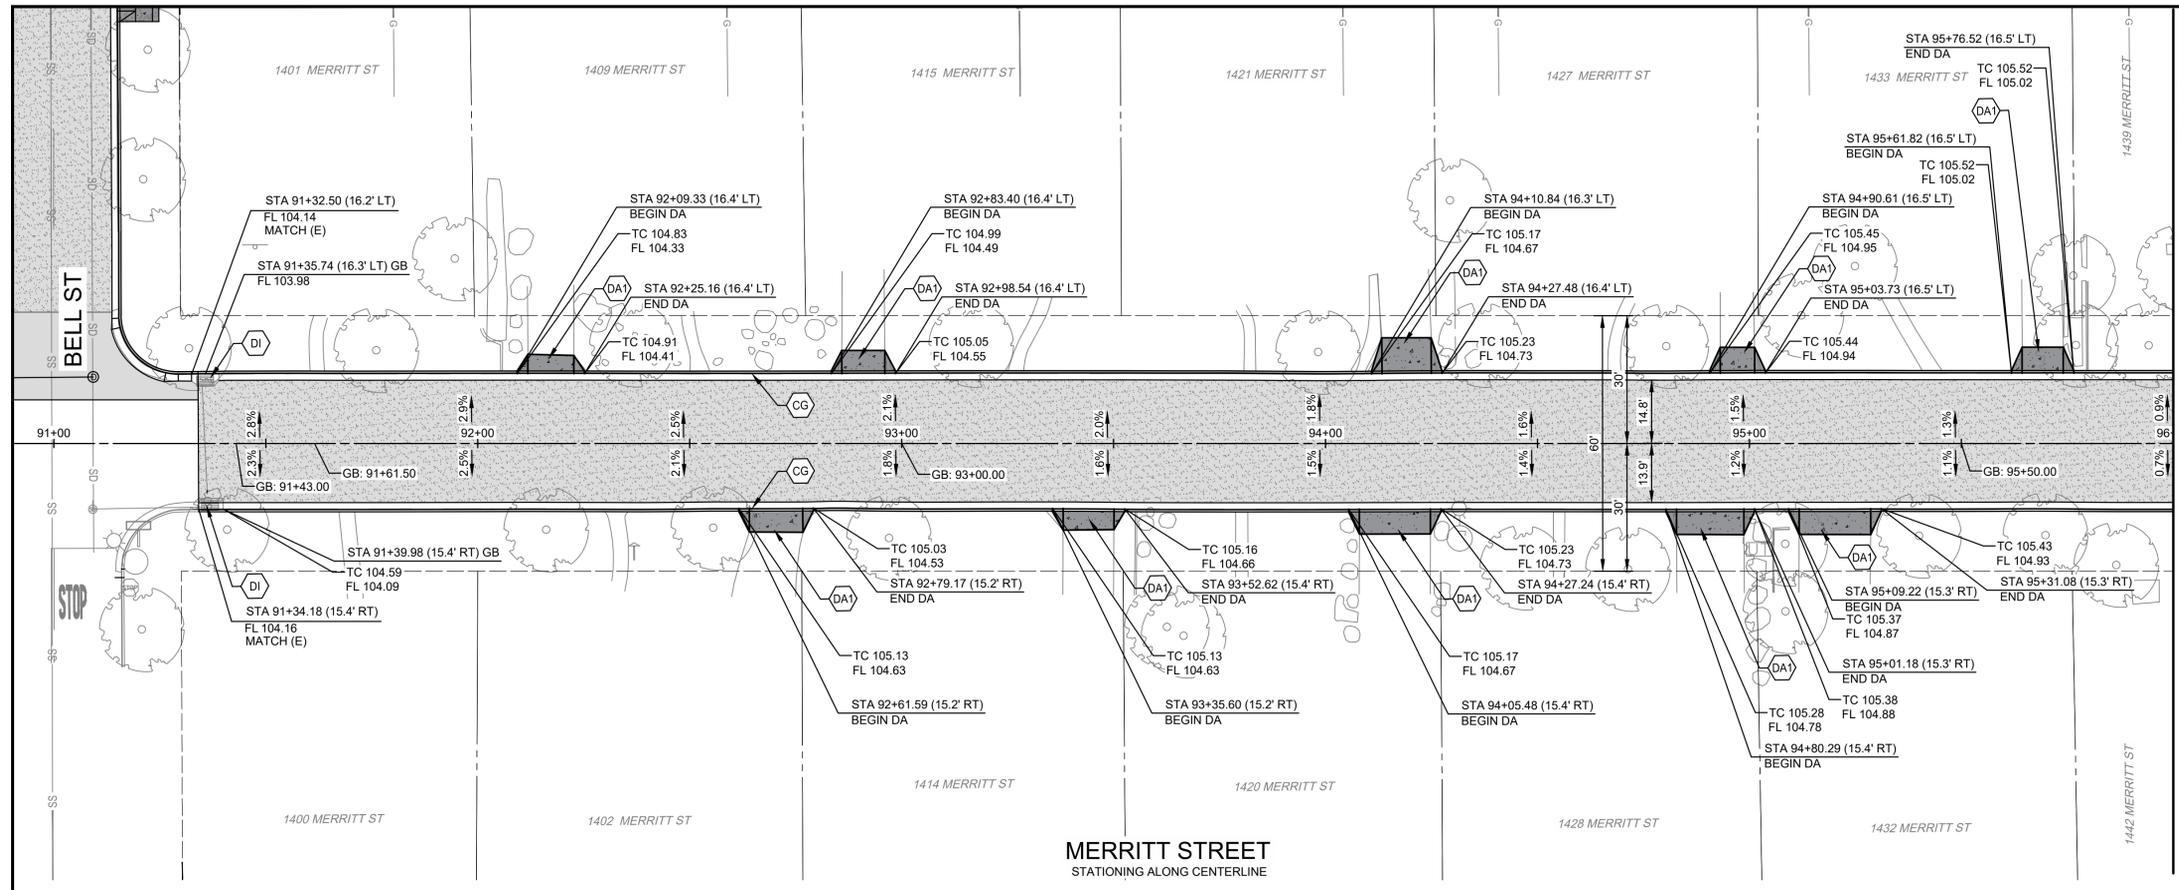
DATE: JAN 2026  
JOB NO: 229224001  
PROJECT NO: 229224001  
PHASE: 3

ORIGINAL SCALE SHOWN IS ONE INCH. ADJUST SCALE FOR REDUCED OR ENLARGED PLANS.

SHEET **C12**  
15 OF 78



CITY OF TURLOCK  
MUNICIPAL SERVICES DEPARTMENT  
ROADS PROGRAM DIVISION  
156 S. BROADWAY, SUITE 150  
(209) 668-5520



**WARNING**  
  
**POWER LINES OVERHEAD**

**811**  
 Know what's below.  
 Call before you dig.

CONSTRUCTION CALLOUTS	
SYM	DESCRIPTION
AA	ALLEY APPROACH PER CITY OF TURLOCK STD DWG C-7
AG	ADJUST TO FINISHED GRADE
CGA	SAWCUT AND REMOVE (E) CURB AND GUTTER AND CONSTRUCT NEW CURB AND GUTTER PER CITY OF TURLOCK STD DWG C-1. DOWEL INTO EXISTING CURB AND GUTTER PER DETAIL 1, SHEET D5
CG	CONSTRUCT NEW CURB AND GUTTER PER CITY OF TURLOCK STD DWG C-1. DOWEL INTO EXISTING CURB AND GUTTER PER DETAIL 1, SHEET D5
CR	SAWCUT AND REMOVE (E) CURB RETURN, RAMPS, AND SIDEWALK AND CONSTRUCT NEW CURB RETURN, RAMP, AND SIDEWALK PER PROJECT SPECIFICATIONS AND SITE DETAILS
DA	RESIDENTIAL DRIVE APPROACH PER CITY OF TURLOCK STD DWG C-5
DA1	REMOVE AND REPLACE EXISTING DRIVE APPROACH TO MATCH AT EXISTING CONCRETE HINGE POINT PER CITY OF TURLOCK STD DWG C-5
DI	REMOVE AND REPLACE CATCH BASIN PER CITY OF TURLOCK STD SD-3 AND T-1
DOC	SAWCUT AND REMOVE (E) CURB AND GUTTER AND CONSTRUCT NEW DRIVE OVER CURB PER CITY OF TURLOCK PER DETAIL 3 ON SHEET D4. DOWEL INTO EXISTING CURB AND GUTTER PER DETAIL 1, SHEET D5
DW	DETECTABLE WARNING SURFACE PER CALTRANS STD DWG SHEET A88A
FH	CONSTRUCT FIRE HYDRANT PER CITY OF TURLOCK STD DWG W-1 AND T-1
MH	ADJUST MANHOLE TO FINISHED GRADE AFTER PAVING OPERATIONS PER DETAIL S-3
NDI	CONSTRUCT CATCH BASIN PER CITY OF TURLOCK STD SD-3 AND T-1
NMH	CONSTRUCT NEW MANHOLE PER CITY OF TURLOCK STD DWG S-3 AND T-1
PP	PROTECT IN PLACE
RC	RETAINING CURB
RD1	REMOVE DRAINAGE INLET
RL	REMOVE AND RELOCATE
SW	CONSTRUCT SIDEWALK PER CITY OF TURLOCK STD DWG C-3. PROVIDE 2' SIDEWALK TRANSITION WITHIN LIMITS SHOWN TO MATCH (E) ELEVATIONS. SLOPES WITHIN TRANSITION AREA SHALL NOT EXCEED 4.5% LONGITUDINALLY. DOWEL INTO EXISTING SIDEWALK PER DETAIL 1, SHEET D5. PROTECT (E) ROOF DRAINS IN PLACE OR REPLACE IN KIND
VG	CONSTRUCT VALLEY GUTTER PER CITY OF TURLOCK STD DWG C-1

**LEGEND**

- FDR-C RECONSTRUCTION PER DETAIL 2 SHEET D5
- 6.0" TYPE A HMA PAVEMENT PLUG OVER 6" CNS COMPACTED TO 95%
- 3.5" MINIMUM THICK CONCRETE OVER 6" CNS COMPACTED TO 90%
- ALLEY/DRIVE APPROACH CONCRETE THICKNESS PER CITY OF TURLOCK STD DWG C-5, C-7 & C-8
- 8.0" TYPE A HMA PAVEMENT OVER 6" CNS COMPACTED TO 95%

- CONSTRUCTION NOTES**
- EXISTING DRIVEWAYS, CURB, AND GUTTER TO REMAIN UNLESS OTHERWISE NOTED ON THE PLANS.
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 MUNICIPAL SERVICES DEPARTMENT  
 ROADS PROGRAM DIVISION  
 156 S. BROADWAY, SUITE 150  
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**BID SET**  
 1/22/2026

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 STREET PLAN  
 MERRITT ST STA 91+00 - 96+00

**PROVOST & PRITCHARD**  
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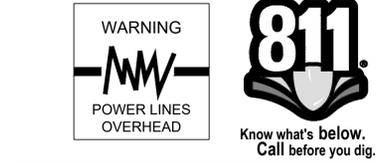
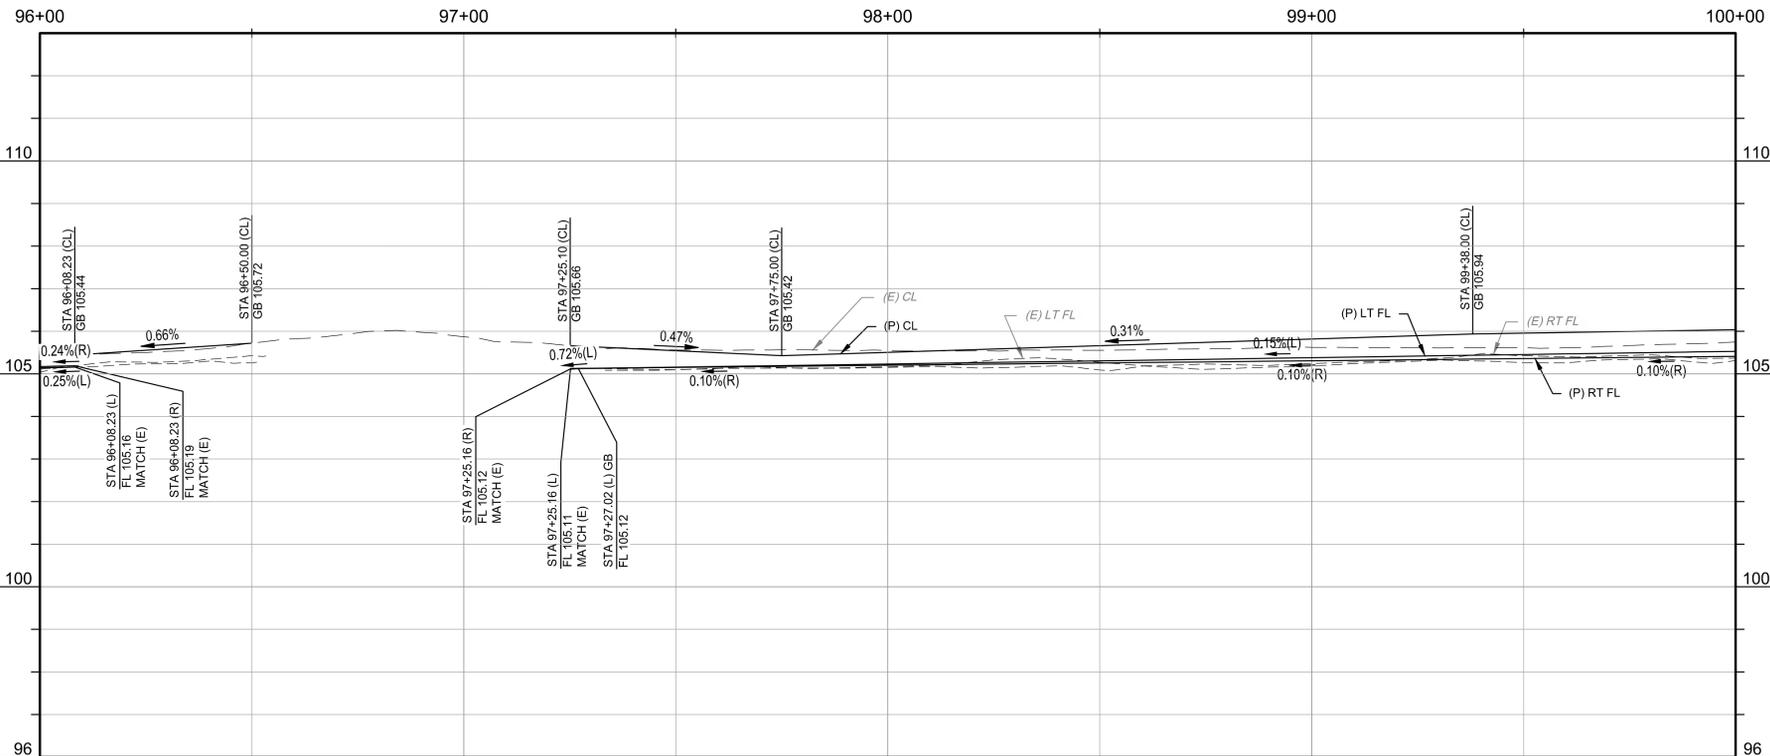
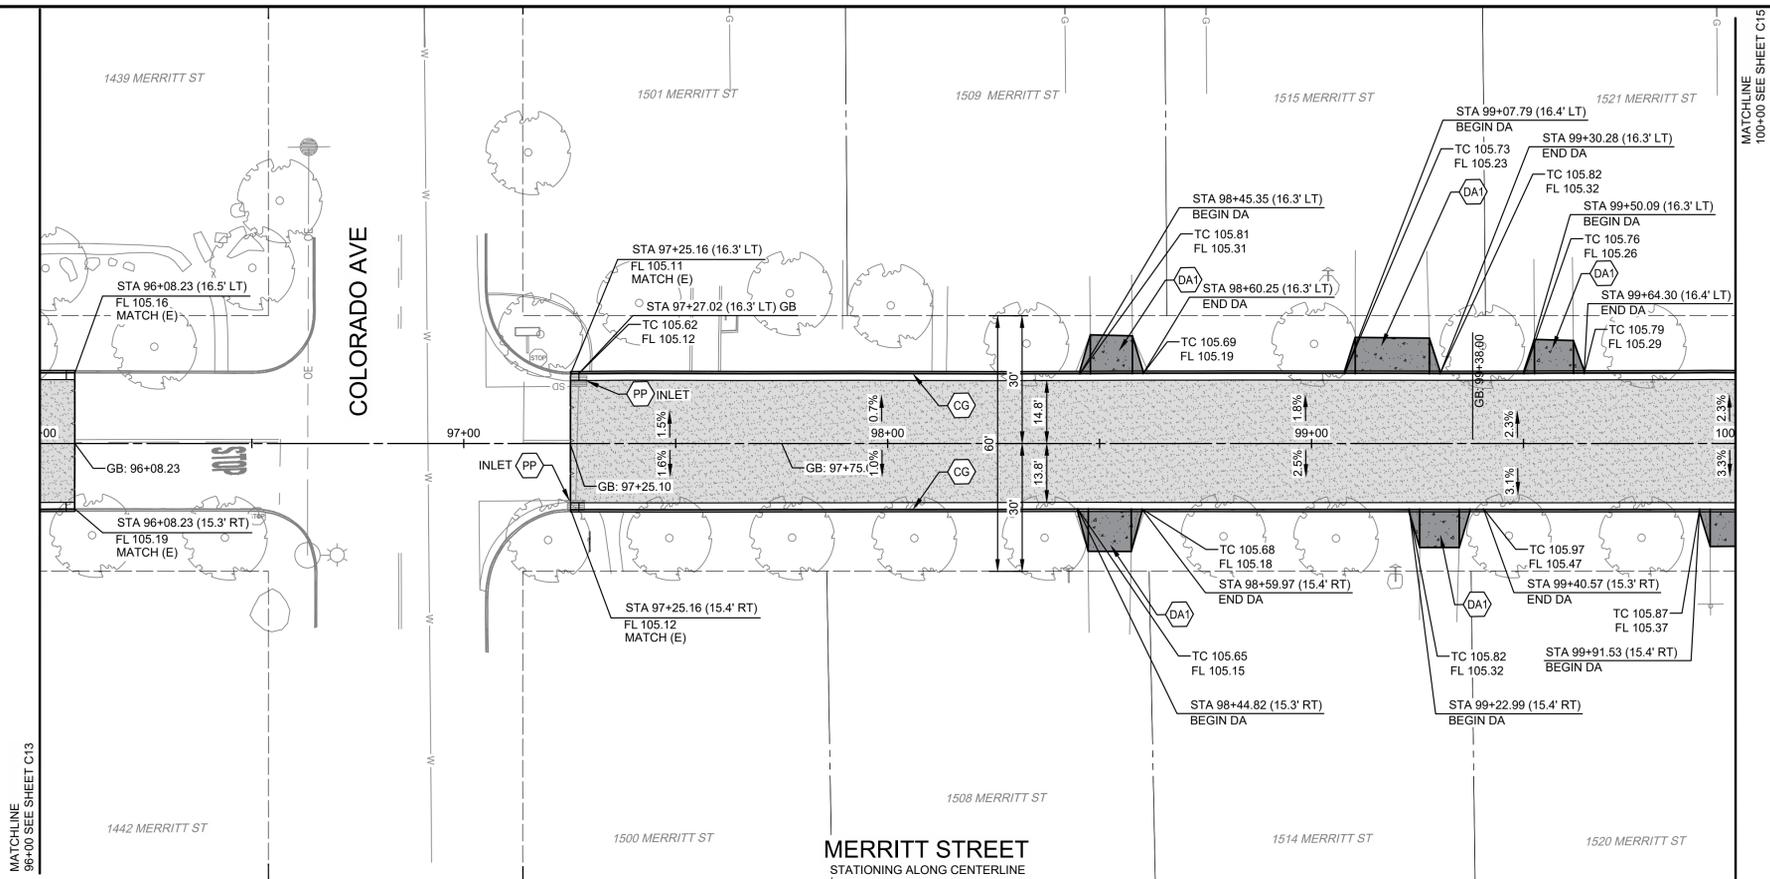
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SHEET **C13**  
 16 OF 78

1/19/2026 9:04 AM G:\Turlock\_City of 229224001\2024 Road Rehab\300 CAD\343 Sheet C13.dwg - Annamaria Fox






CONSTRUCTION CALLOUTS	
SYM	DESCRIPTION
AA	ALLEY APPROACH PER CITY OF TURLOCK STD DWG C-7
AG	ADJUST TO FINISHED GRADE
CGA	SAWCUT AND REMOVE (E) CURB AND GUTTER AND CONSTRUCT NEW CURB AND GUTTER PER CITY OF TURLOCK STD DWG C-1. DOWEL INTO EXISTING CURB AND GUTTER PER DETAIL 1, SHEET D5
CG	CONSTRUCT NEW CURB AND GUTTER PER CITY OF TURLOCK STD DWG C-1. DOWEL INTO EXISTING CURB AND GUTTER PER DETAIL 1, SHEET D5
CR	SAWCUT AND REMOVE (E) CURB RETURN, RAMPS, AND SIDEWALK AND CONSTRUCT NEW CURB RETURN, RAMP, AND SIDEWALK PER PROJECT SPECIFICATIONS AND SITE DETAILS
DA	RESIDENTIAL DRIVE APPROACH PER CITY OF TURLOCK STD DWG C-5
DA1	REMOVE AND REPLACE EXISTING DRIVE APPROACH TO MATCH AT EXISTING CONCRETE HINGE POINT PER CITY OF TURLOCK STD DWG C-5
DI	REMOVE AND REPLACE CATCH BASIN PER CITY OF TURLOCK STD SD-3 AND T-1
DOC	SAWCUT AND REMOVE (E) CURB AND GUTTER AND CONSTRUCT NEW DRIVE OVER CURB PER CITY OF TURLOCK PER DETAIL 3 ON SHEET D4. DOWEL INTO EXISTING CURB AND GUTTER PER DETAIL 1, SHEET D5
DW	DETECTABLE WARNING SURFACE PER CALTRANS STD DWG SHEET A88A
FH	CONSTRUCT FIRE HYDRANT PER CITY OF TURLOCK STD DWG W-1 AND T-1
MH	ADJUST MANHOLE TO FINISHED GRADE AFTER PAVING OPERATIONS PER DETAIL S-3
NDI	CONSTRUCT CATCH BASIN PER CITY OF TURLOCK STD SD-3 AND T-1
NMH	CONSTRUCT NEW MANHOLE PER CITY OF TURLOCK STD DWG S-3 AND T-1
PP	PROTECT IN PLACE
RC	RETAINING CURB
RD	REMOVE DRAINAGE INLET
RL	REMOVE AND RELOCATE
SW	CONSTRUCT SIDEWALK PER CITY OF TURLOCK STD DWG C-3. PROVIDE 2' SIDEWALK TRANSITION WITHIN LIMITS SHOWN TO MATCH (E) ELEVATIONS. SLOPES WITHIN TRANSITION AREA SHALL NOT EXCEED 4.5% LONGITUDINALLY. DOWEL INTO EXISTING SIDEWALK PER DETAIL 1, SHEET D5. PROTECT (E) ROOF DRAINS IN PLACE OR REPLACE IN KIND
VG	CONSTRUCT VALLEY GUTTER PER CITY OF TURLOCK STD DWG C-1

LEGEND	
	FDR-C RECONSTRUCTION PER DETAIL 2 SHEET D5
	6.0" TYPE A HMA PAVEMENT PLUG OVER
	6" CNS COMPACTED TO 95%
	3.5" MINIMUM THICK CONCRETE OVER 6" CNS COMPACTED TO 90%
	ALLEY/DRIVE APPROACH CONCRETE THICKNESS PER CITY OF TURLOCK STD DWG C-5, C-7 & C-8
	8.0" TYPE A HMA PAVEMENT OVER 6" CNS COMPACTED TO 95%

- CONSTRUCTION NOTES**
- EXISTING DRIVEWAYS, CURB, AND GUTTER TO REMAIN UNLESS OTHERWISE NOTED ON THE PLANS.
  - STATION AND OFFSET ON CURB AND GUTTER REFERS TO A POINT ON THE FLOWLINE.
  - DETAILED RAMP AND DRIVE APPROACH GRADING IS PROVIDED ON SHEETS D7-D22.
  - PROTECT IN PLACE ALL (E) SIDEWALK DRAINS.
  - NOT ALL SEWER LATERALS ARE SHOWN ON THE PLANS.

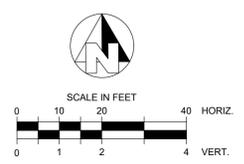

CITY OF TURLOCK  
MUNICIPAL SERVICES DEPARTMENT  
ROADS PROGRAM DIVISION  
156 S. BROADWAY, SUITE 150  
(209) 668-5520

**BID SET**  
1/22/2026

CITY OF TURLOCK  
ROADS PROGRAM CIP  
CITY PROJECT No. 23-068, PACKAGE 3  
STREET PLAN  
MERRITT ST STA 96+00 - 100+00

DESIGN ENGINEER:  
JEFF DORN  
LICENSE NO:  
76,749




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CHECKED BY: JD

DATE: JAN 2026  
JOB NO: 229224001  
PROJECT NO: 229224001  
PHASE: 3

ORIGINAL SCALE SHOWN IS ONE INCH. ADJUST SCALE FOR REDUCED OR ENLARGED PLANS.

SHEET **C14**  
17 OF 78


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CONSTRUCTION CALLOUTS	
SYM	DESCRIPTION
AA	ALLEY APPROACH PER CITY OF TURLOCK STD DWG C-7
AG	ADJUST TO FINISHED GRADE
CGA	SAWCUT AND REMOVE (E) CURB AND GUTTER AND CONSTRUCT NEW CURB AND GUTTER PER CITY OF TURLOCK STD DWG C-1. DOWEL INTO EXISTING CURB AND GUTTER PER DETAIL 1, SHEET D5
CG	CONSTRUCT NEW CURB AND GUTTER PER CITY OF TURLOCK STD DWG C-1. DOWEL INTO EXISTING CURB AND GUTTER PER DETAIL 1, SHEET D5
CR	SAWCUT AND REMOVE (E) CURB RETURN, RAMPS, AND SIDEWALK AND CONSTRUCT NEW CURB RETURN, RAMP, AND SIDEWALK PER PROJECT SPECIFICATIONS AND SITE DETAILS
DA	RESIDENTIAL DRIVE APPROACH PER CITY OF TURLOCK STD DWG C-5
DA1	REMOVE AND REPLACE EXISTING DRIVE APPROACH TO MATCH AT EXISTING CONCRETE HINGE POINT PER CITY OF TURLOCK STD DWG C-5
DI	REMOVE AND REPLACE CATCH BASIN PER CITY OF TURLOCK STD SD-3 AND T-1
DOC	SAWCUT AND REMOVE (E) CURB AND GUTTER AND CONSTRUCT NEW DRIVE OVER CURB PER CITY OF TURLOCK PER DETAIL 3 ON SHEET D4. DOWEL INTO EXISTING CURB AND GUTTER PER DETAIL 1, SHEET D5
DW	DETECTABLE WARNING SURFACE PER CALTRANS STD DWG SHEET A88A
FH	CONSTRUCT FIRE HYDRANT PER CITY OF TURLOCK STD DWG W-1 AND T-1
MH	ADJUST MANHOLE TO FINISHED GRADE AFTER PAVING OPERATIONS PER DETAIL S-3
NDI	CONSTRUCT CATCH BASIN PER CITY OF TURLOCK STD SD-3 AND T-1
NMH	CONSTRUCT NEW MANHOLE PER CITY OF TURLOCK STD DWG S-3 AND T-1
PP	PROTECT IN PLACE
RC	RETAINING CURB
RDI	REMOVE DRAINAGE INLET
RL	REMOVE AND RELOCATE
SW	CONSTRUCT SIDEWALK PER CITY OF TURLOCK STD DWG C-3. PROVIDE 2' SIDEWALK TRANSITION WITHIN LIMITS SHOWN TO MATCH (E) ELEVATIONS. SLOPES WITHIN TRANSITION AREA SHALL NOT EXCEED 4.5% LONGITUDINALLY. DOWEL INTO EXISTING SIDEWALK PER DETAIL 1, SHEET D5. PROTECT (E) ROOF DRAINS IN PLACE OR REPLACE IN KIND
VG	CONSTRUCT VALLEY GUTTER PER CITY OF TURLOCK STD DWG C-1

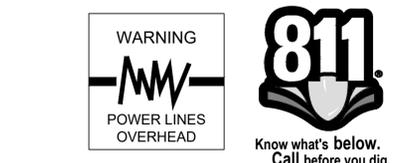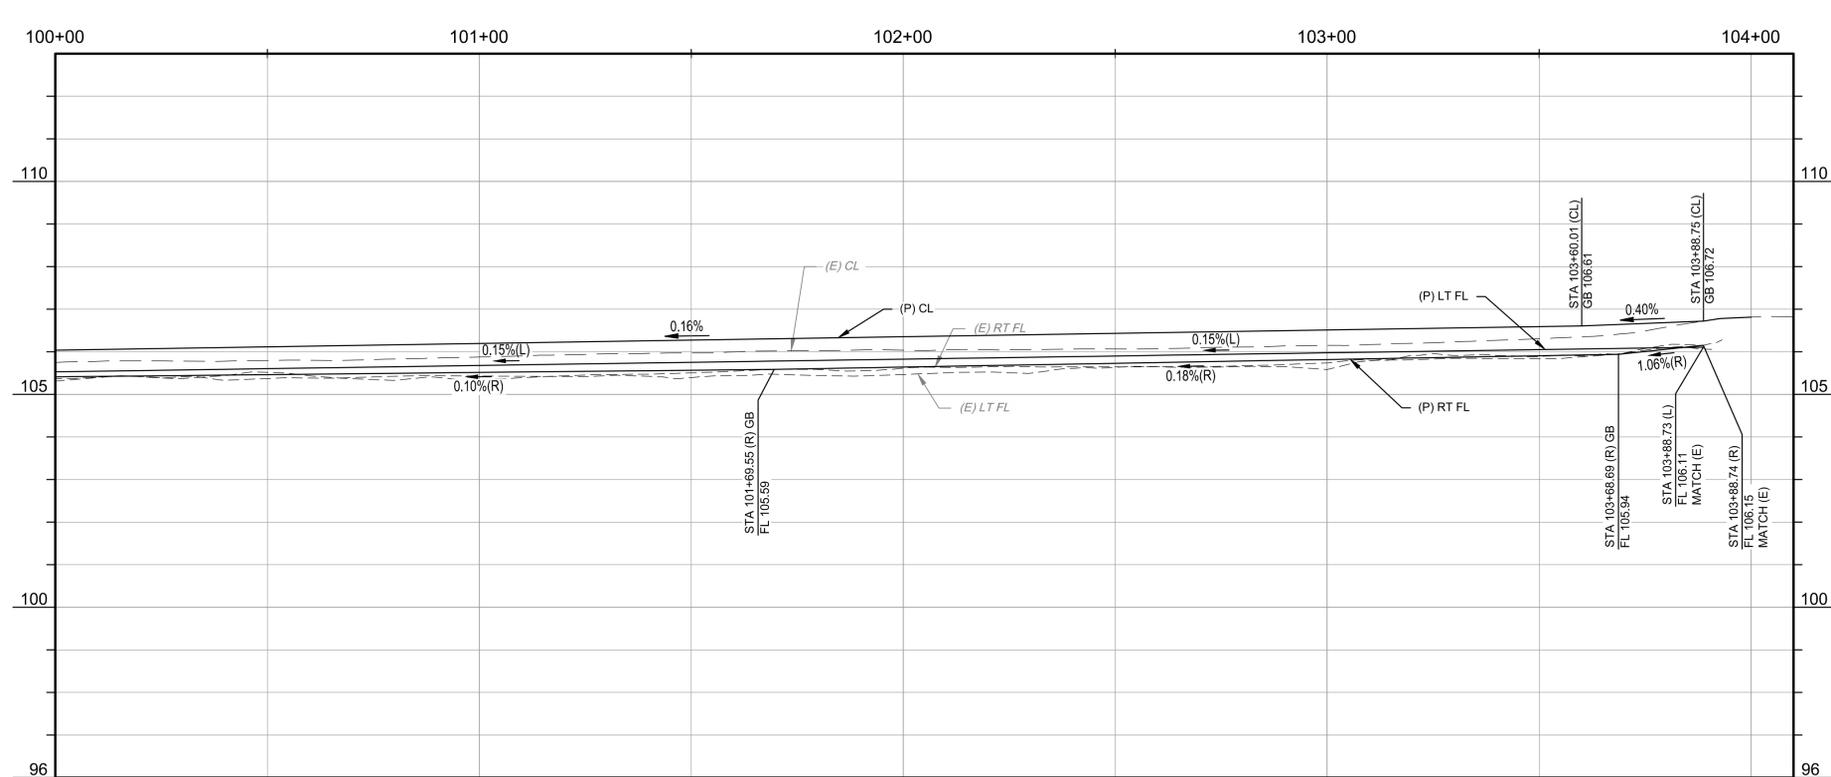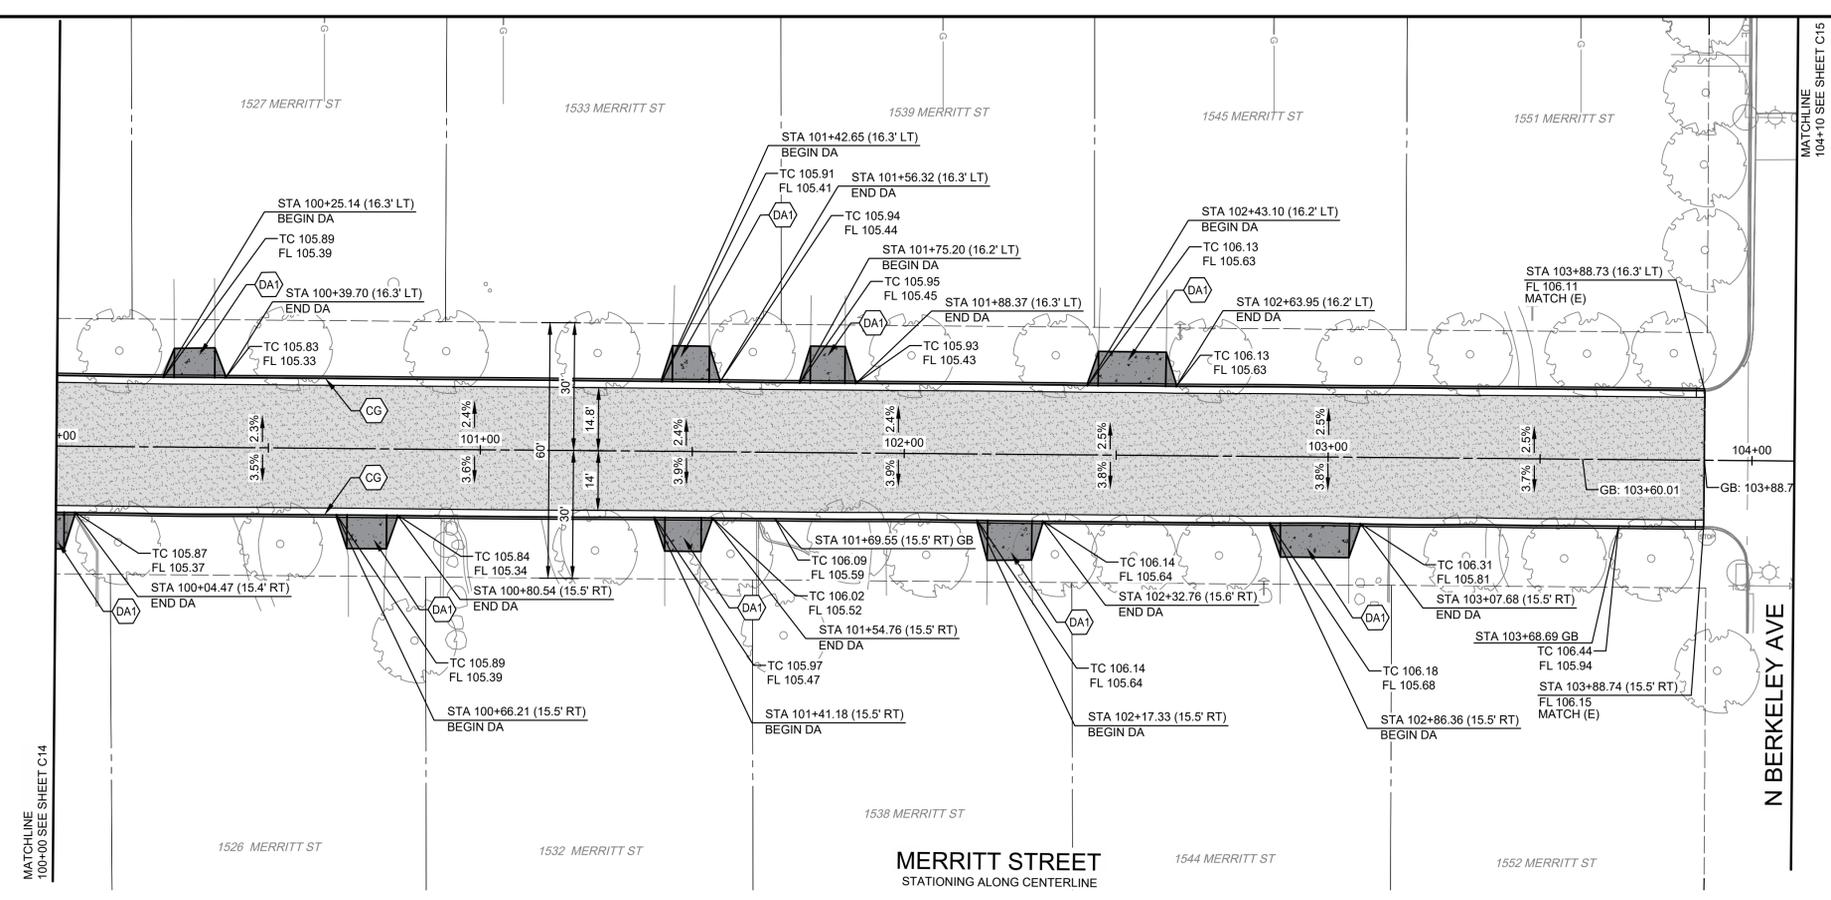LEGEND	
	FDR-C RECONSTRUCTION PER DETAIL 2 SHEET D5
	6.0" TYPE A HMA PAVEMENT PLUG OVER
	6" CNS COMPACTED TO 95%
	3.5" MINIMUM THICK CONCRETE OVER
	6" CNS COMPACTED TO 90%
	ALLEY/DRIVE APPROACH CONCRETE THICKNESS PER CITY OF TURLOCK STD DWG C-5, C-7 & C-8
	8.0" TYPE A HMA PAVEMENT OVER
	6" CNS COMPACTED TO 95%

- CONSTRUCTION NOTES**
- EXISTING DRIVEWAYS, CURB, AND GUTTER TO REMAIN UNLESS OTHERWISE NOTED ON THE PLANS.
  - STATION AND OFFSET ON CURB AND GUTTER REFERS TO A POINT ON THE FLOWLINE.
  - DETAILED RAMP AND DRIVE APPROACH GRADING IS PROVIDED ON SHEETS D7-D22.
  - PROTECT IN PLACE ALL (E) SIDEWALK DRAINS.
  - NOT ALL SEWER LATERALS ARE SHOWN ON THE PLANS.



CITY OF TURLOCK  
MUNICIPAL SERVICES DEPARTMENT  
ROADS PROGRAM DIVISION  
156 S. BROADWAY, SUITE 150  
(209) 668-5520

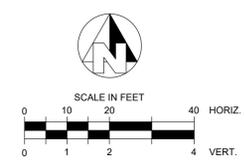**BID SET**  
1/22/2026

CITY OF TURLOCK  
ROADS PROGRAM CIP  
CITY PROJECT No. 23-068, PACKAGE 3  
STREET PLAN  
MERRITT ST STA 100+00 - 104+10

PROVOST & PRITCHARD  
425 W. FIR AVENUE  
TURLOCK, CA 95259  
PHONE (209) 449-2700  
FAX (209) 449-2715  
www.provostandpritchard.com

DESIGN ENGINEER:  
JEFF DORN  
LICENSE NO:  
76,749

DRAFTED BY: AR  
CHECKED BY: JD




DATE: JAN 2026  
JOB NO: 229224001  
PROJECT NO: 229224001  
PHASE: 3

ORIGINAL SCALE SHOWN IS ONE INCH. ADJUST SCALE FOR REDUCED OR ENLARGED PLANS.

SHEET **C15**  
18 OF 78

DATE SIGNED: \_\_\_\_\_  
NO. \_\_\_\_\_  
REVISION \_\_\_\_\_  
BY \_\_\_\_\_  
DATE \_\_\_\_\_


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CONSTRUCTION CALLOUTS	
SYM	DESCRIPTION
AA	ALLEY APPROACH PER CITY OF TURLOCK STD DWG C-7
AG	ADJUST TO FINISHED GRADE
CGA	SAWCUT AND REMOVE (E) CURB AND GUTTER AND CONSTRUCT NEW CURB AND GUTTER PER CITY OF TURLOCK STD DWG C-1. DOWEL INTO EXISTING CURB AND GUTTER PER DETAIL 1, SHEET D5
CG	CONSTRUCT NEW CURB AND GUTTER PER CITY OF TURLOCK STD DWG C-1. DOWEL INTO EXISTING CURB AND GUTTER PER DETAIL 1, SHEET D5
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DA	RESIDENTIAL DRIVE APPROACH PER CITY OF TURLOCK STD DWG C-5
DA1	REMOVE AND REPLACE EXISTING DRIVE APPROACH TO MATCH AT EXISTING CONCRETE HINGE POINT PER CITY OF TURLOCK STD DWG C-5
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DW	DETECTABLE WARNING SURFACE PER CALTRANS STD DWG SHEET A88A
FH	CONSTRUCT FIRE HYDRANT PER CITY OF TURLOCK STD DWG W-1 AND T-1
MH	ADJUST MANHOLE TO FINISHED GRADE AFTER PAVING OPERATIONS PER DETAIL S-3
NDI	CONSTRUCT CATCH BASIN PER CITY OF TURLOCK STD SD-3 AND T-1
NMH	CONSTRUCT NEW MANHOLE PER CITY OF TURLOCK STD DWG S-3 AND T-1
PP	PROTECT IN PLACE
RC	RETAINING CURB
RDI	REMOVE DRAINAGE INLET
RL	REMOVE AND RELOCATE
SW	CONSTRUCT SIDEWALK PER CITY OF TURLOCK STD DWG C-3. PROVIDE 2' SIDEWALK TRANSITION WITHIN LIMITS SHOWN TO MATCH (E) ELEVATIONS. SLOPES WITHIN TRANSITION AREA SHALL NOT EXCEED 4.5% LONGITUDINALLY. DOWEL INTO EXISTING SIDEWALK PER DETAIL 1, SHEET D5. PROTECT (E) ROOF DRAINS IN PLACE OR REPLACE IN KIND
VG	CONSTRUCT VALLEY GUTTER PER CITY OF TURLOCK STD DWG C-1

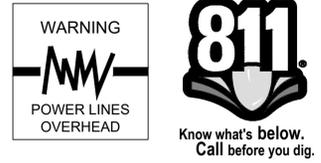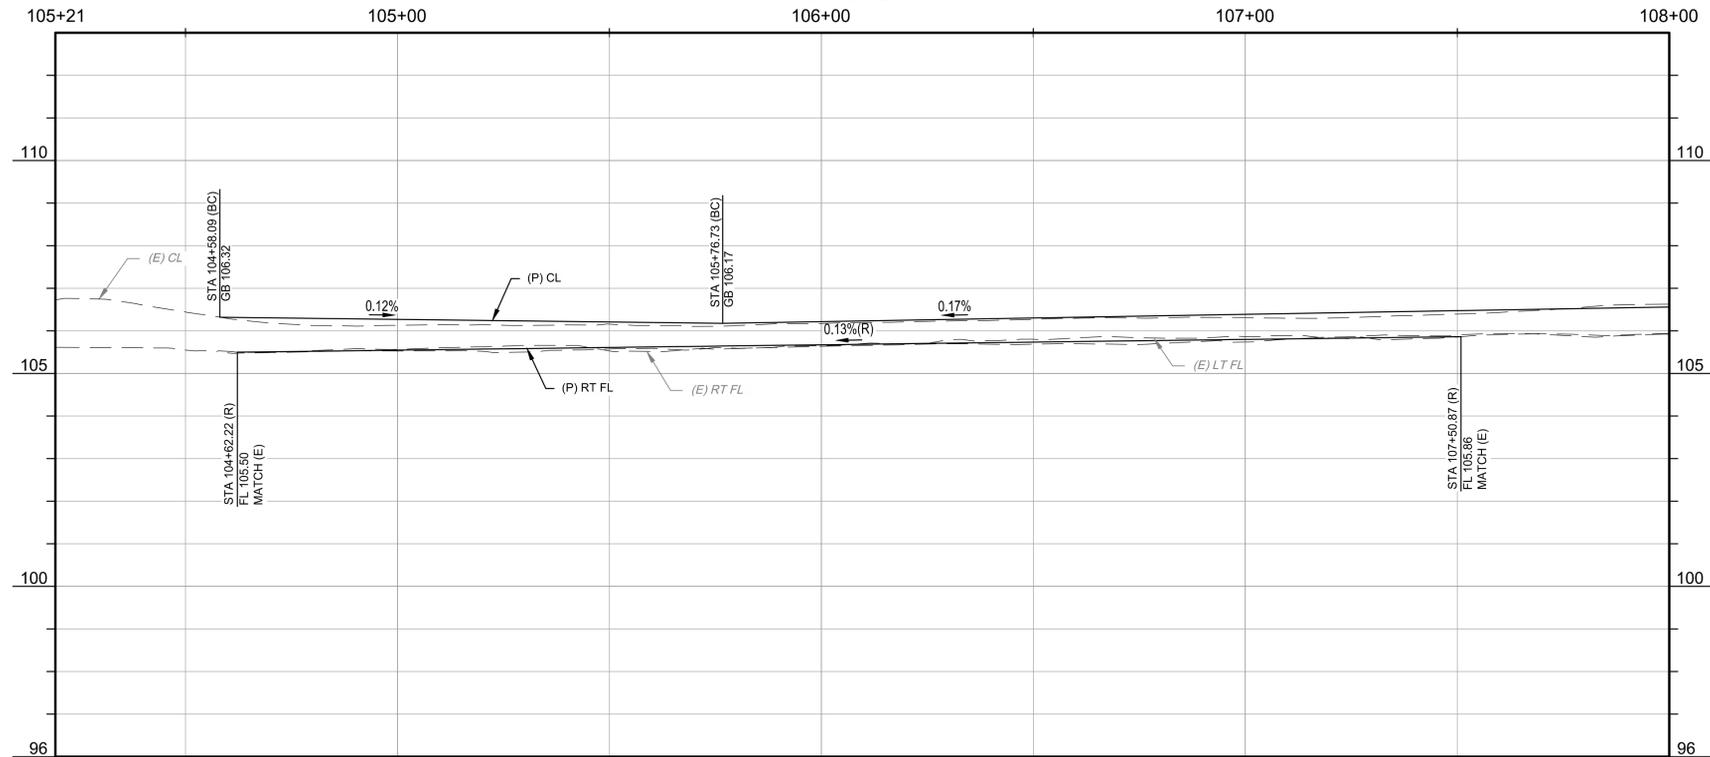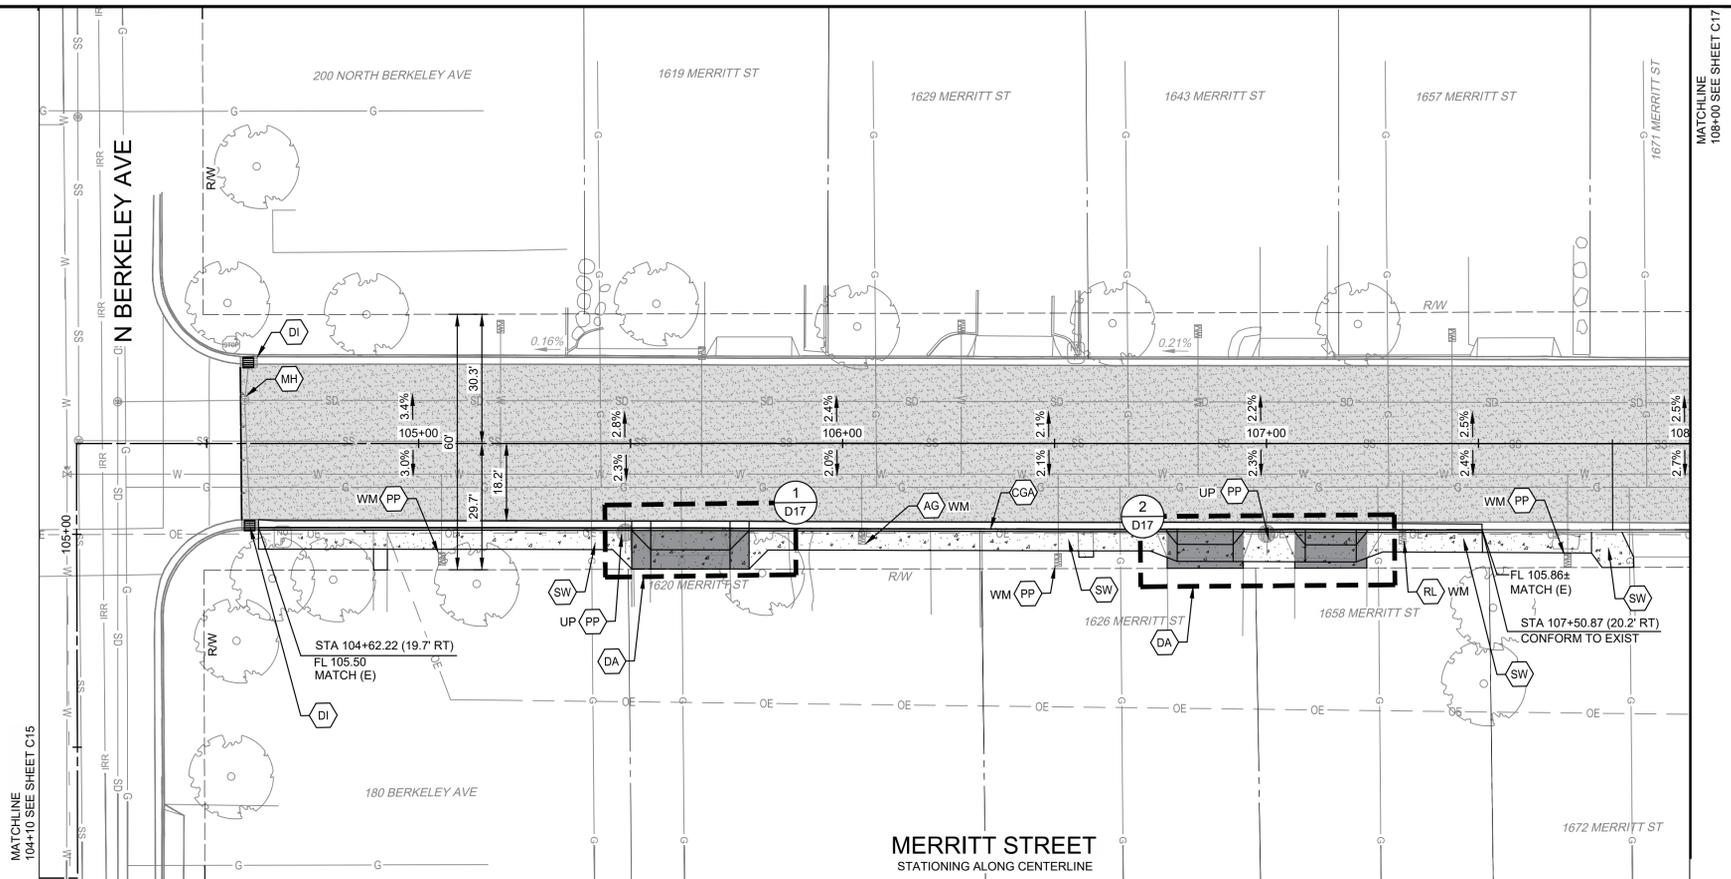LEGEND	
	FDR-C RECONSTRUCTION PER DETAIL 2 SHEET D5
	6.0" TYPE A HMA PAVEMENT PLUG OVER 6" CNS COMPACTED TO 95%
	3.5" MINIMUM THICK CONCRETE OVER 6" CNS COMPACTED TO 90%
	ALLEY/DRIVE APPROACH CONCRETE THICKNESS PER CITY OF TURLOCK STD DWG C-5, C-7 & C-8
	8.0" TYPE A HMA PAVEMENT OVER 6" CNS COMPACTED TO 95%

- CONSTRUCTION NOTES**
- EXISTING DRIVEWAYS, CURB, AND GUTTER TO REMAIN UNLESS OTHERWISE NOTED ON THE PLANS.
  - STATION AND OFFSET ON CURB AND GUTTER REFERS TO A POINT ON THE FLOWLINE.
  - DETAILED RAMP AND DRIVE APPROACH GRADING IS PROVIDED ON SHEETS D7-D22.
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CITY OF TURLOCK  
MUNICIPAL SERVICES DEPARTMENT  
ROADS PROGRAM DIVISION  
156 S. BROADWAY, SUITE 150  
(209) 668-5520

**BID SET**  
1/22/2026

**CITY OF TURLOCK**  
ROADS PROGRAM CIP  
CITY PROJECT No. 23-068, PACKAGE 3  
STREET PLAN  
MERRITT ST STA 104+10 - 108+00

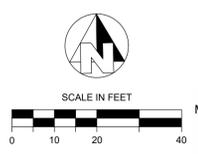**PROVOST & PRITCHARD**  
425 W. FIR AVENUE  
TURLOCK, CA 95259  
PHONE (209) 449-2700  
FAX (209) 449-2715  
www.provostandpritchard.com

DESIGN ENGINEER:  
JEFF DORN  
LICENSE NO:  
76,749

DRAFTED BY: AR  
CHECKED BY: JD

DATE: JAN 2026  
JOB NO: 229224001  
PROJECT NO: 229224001  
PHASE: 3


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SHEET **C16**  
19 OF 78

DATE SIGNED: \_\_\_\_\_  
REVISION: \_\_\_\_\_  
BY: \_\_\_\_\_  
DATE: \_\_\_\_\_

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**WARNING**  
  
**POWER LINES OVERHEAD**

**811**  
 Know what's below.  
 Call before you dig.

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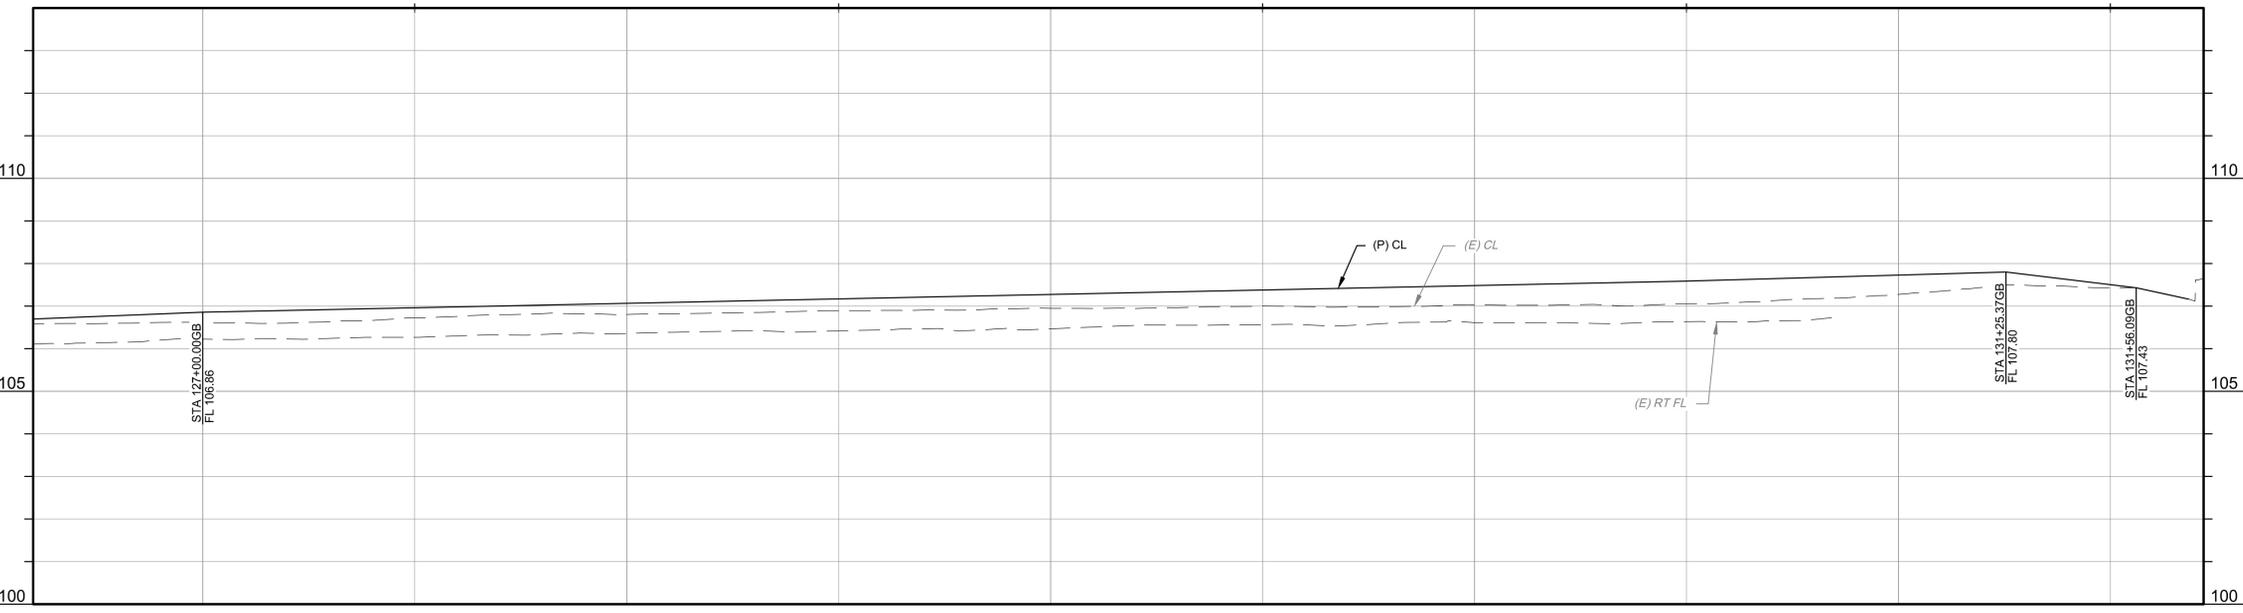
**BID SET**  
1/22/2026

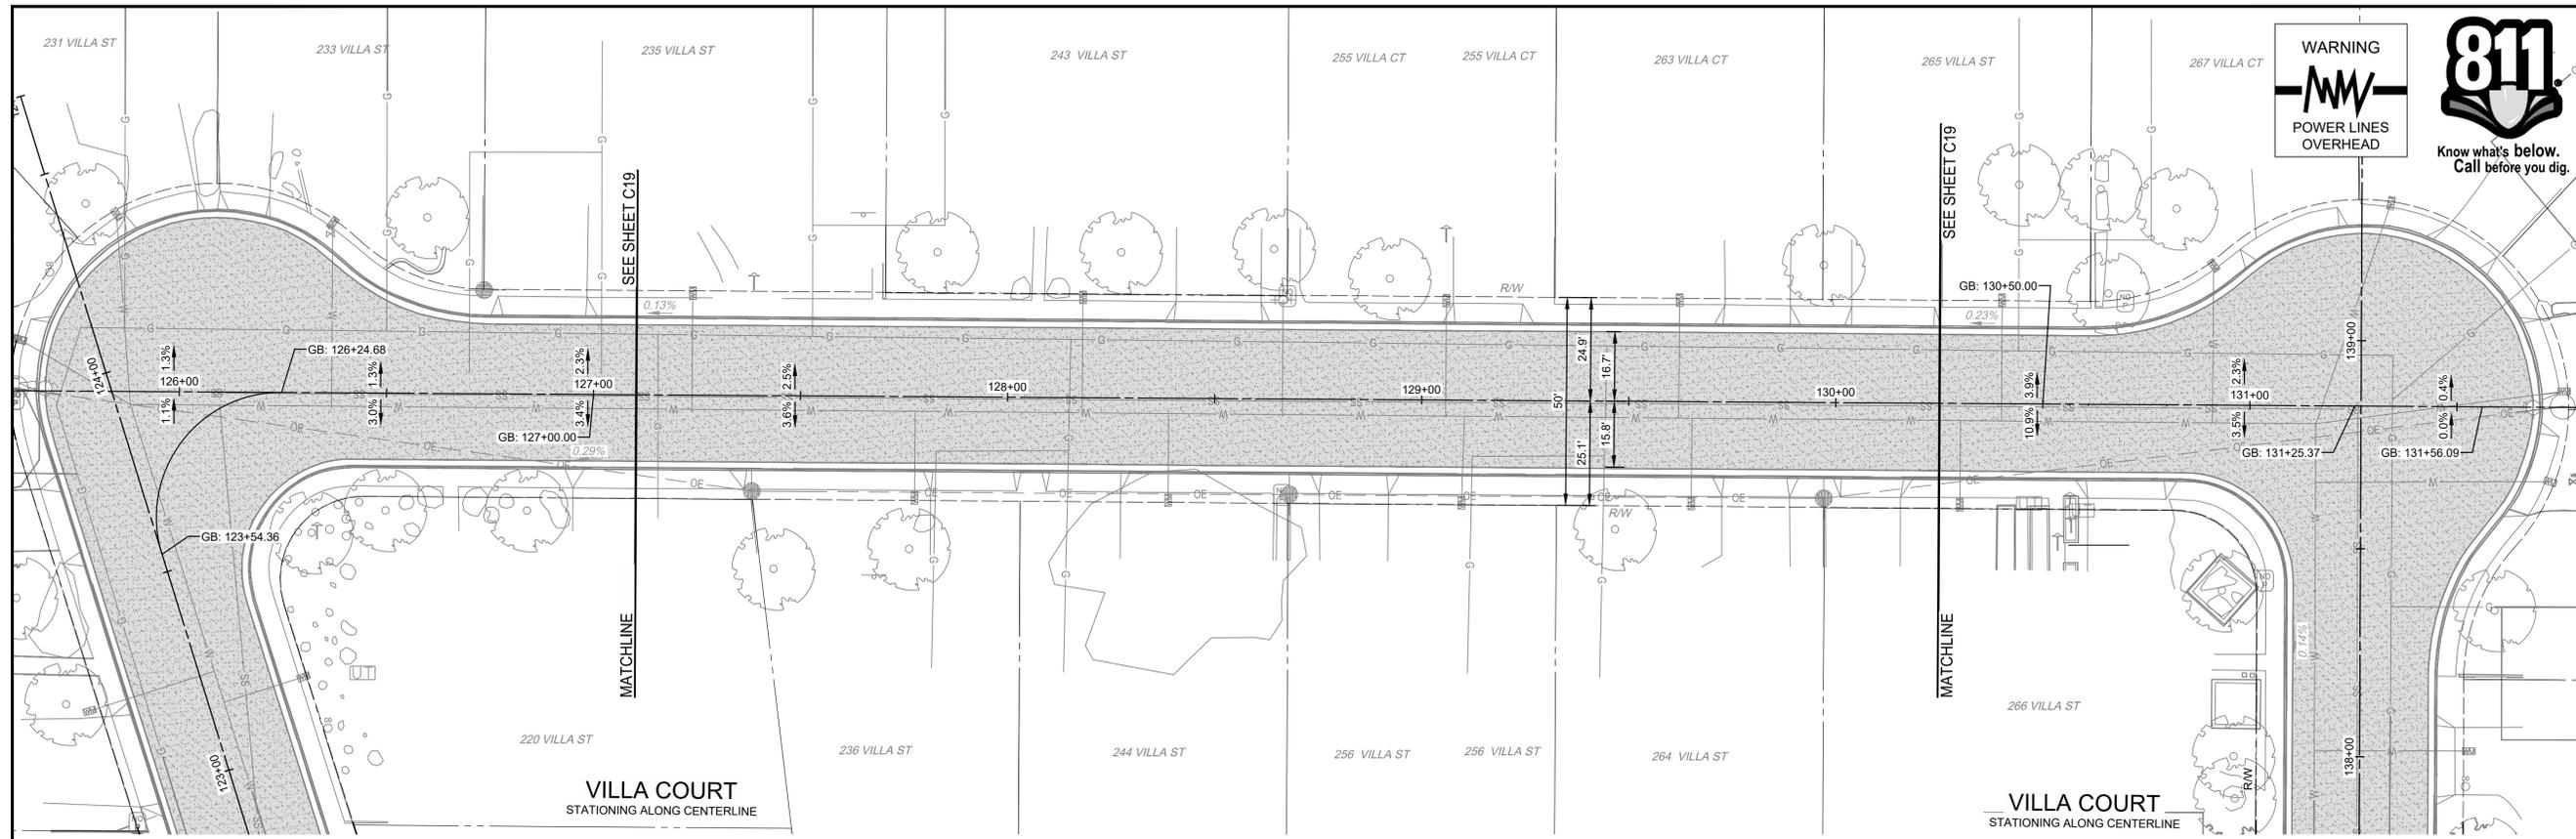NO.	REVISION	BY	DATE

DATE SIGNED: \_\_\_\_\_

PROFESSIONAL ENGINEER  
 JEFF DORN  
 LICENSE NO. 76,749  
 CIVIL  
 STATE OF CALIFORNIA

SYM	DESCRIPTION
AA	ALLEY APPROACH PER CITY OF TURLOCK STD DWG C-7
AG	ADJUST TO FINISHED GRADE
CGA	SAWCUT AND REMOVE (E) CURB AND GUTTER AND CONSTRUCT NEW CURB AND GUTTER PER CITY OF TURLOCK STD DWG C-1. DOWEL INTO EXISTING CURB AND GUTTER PER DETAIL 1, SHEET D5
CG	CONSTRUCT NEW CURB AND GUTTER PER CITY OF TURLOCK STD DWG C-1. DOWEL INTO EXISTING CURB AND GUTTER PER DETAIL 1, SHEET D5
CR	SAWCUT AND REMOVE (E) CURB RETURN, RAMP, AND SIDEWALK AND CONSTRUCT NEW CURB RETURN, RAMP, AND SIDEWALK PER PROJECT SPECIFICATIONS AND SITE DETAILS
DA	RESIDENTIAL DRIVE APPROACH PER CITY OF TURLOCK STD DWG C-5
DA1	REMOVE AND REPLACE EXISTING DRIVE APPROACH TO MATCH AT EXISTING CONCRETE HINGE POINT PER CITY OF TURLOCK STD DWG C-5
DI	REMOVE AND REPLACE CATCH BASIN PER CITY OF TURLOCK STD SD-3 AND T-1
DOC	SAWCUT AND REMOVE (E) CURB AND GUTTER AND CONSTRUCT NEW DRIVE OVER CURB PER CITY OF TURLOCK PER DETAIL 3 ON SHEET D4. DOWEL INTO EXISTING CURB AND GUTTER PER DETAIL 1, SHEET D5
DW	DETECTABLE WARNING SURFACE PER CALTRANS STD DWG SHEET A88A
FH	CONSTRUCT FIRE HYDRANT PER CITY OF TURLOCK STD DWG W-1 AND T-1
MH	ADJUST MANHOLE TO FINISHED GRADE AFTER PAVING OPERATIONS PER DETAIL S-3
NDI	CONSTRUCT CATCH BASIN PER CITY OF TURLOCK STD SD-3 AND T-1
NMH	CONSTRUCT NEW MANHOLE PER CITY OF TURLOCK STD DWG S-3 AND T-1
PP	PROTECT IN PLACE
RC	RETAINING CURB
RDI	REMOVE DRAINAGE INLET
RL	REMOVE AND RELOCATE
SW	CONSTRUCT SIDEWALK PER CITY OF TURLOCK STD DWG C-3. PROVIDE 2" SIDEWALK TRANSITION WITHIN LIMITS SHOWN TO MATCH (E) ELEVATIONS. SLOPES WITHIN TRANSITION AREA SHALL NOT EXCEED 4.5% LONGITUDINALLY. DOWEL INTO EXISTING SIDEWALK PER DETAIL 1, SHEET D5. PROTECT (E) ROOF DRAINS IN PLACE OR REPLACE IN KIND
VG	CONSTRUCT VALLEY GUTTER PER CITY OF TURLOCK STD DWG C-1



**LEGEND**

- FDR-C RECONSTRUCTION PER DETAIL 2 SHEET D5
- 6.0" TYPE A HMA PAVEMENT PLUG OVER 6" CNS COMPACTED TO 95%
- 3.5" MINIMUM THICK CONCRETE OVER 6" CNS COMPACTED TO 90%
- ALLEY/DRIVE APPROACH CONCRETE THICKNESS PER CITY OF TURLOCK STD DWG C-5, C-7 & C-8
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- EXISTING DRIVEWAYS, CURB, AND GUTTER TO REMAIN UNLESS OTHERWISE NOTED ON THE PLANS.
  - STATION AND OFFSET ON CURB AND GUTTER REFERS TO A POINT ON THE FLOWLINE.
  - DETAILED RAMP AND DRIVE APPROACH GRADING IS PROVIDED ON SHEETS D7-D22.
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CITY OF TURLOCK  
 ROADS PROGRAM CIP  
 CITY PROJECT NO. 23-068, PACKAGE 3  
 STREET PLAN  
 VILLA CT ST STA 125+00 - 132+00

**PROVOST & PRITCHARD**  
 425 W FIR AVENUE  
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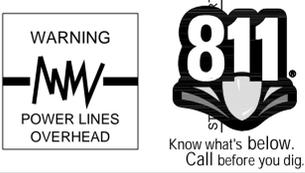
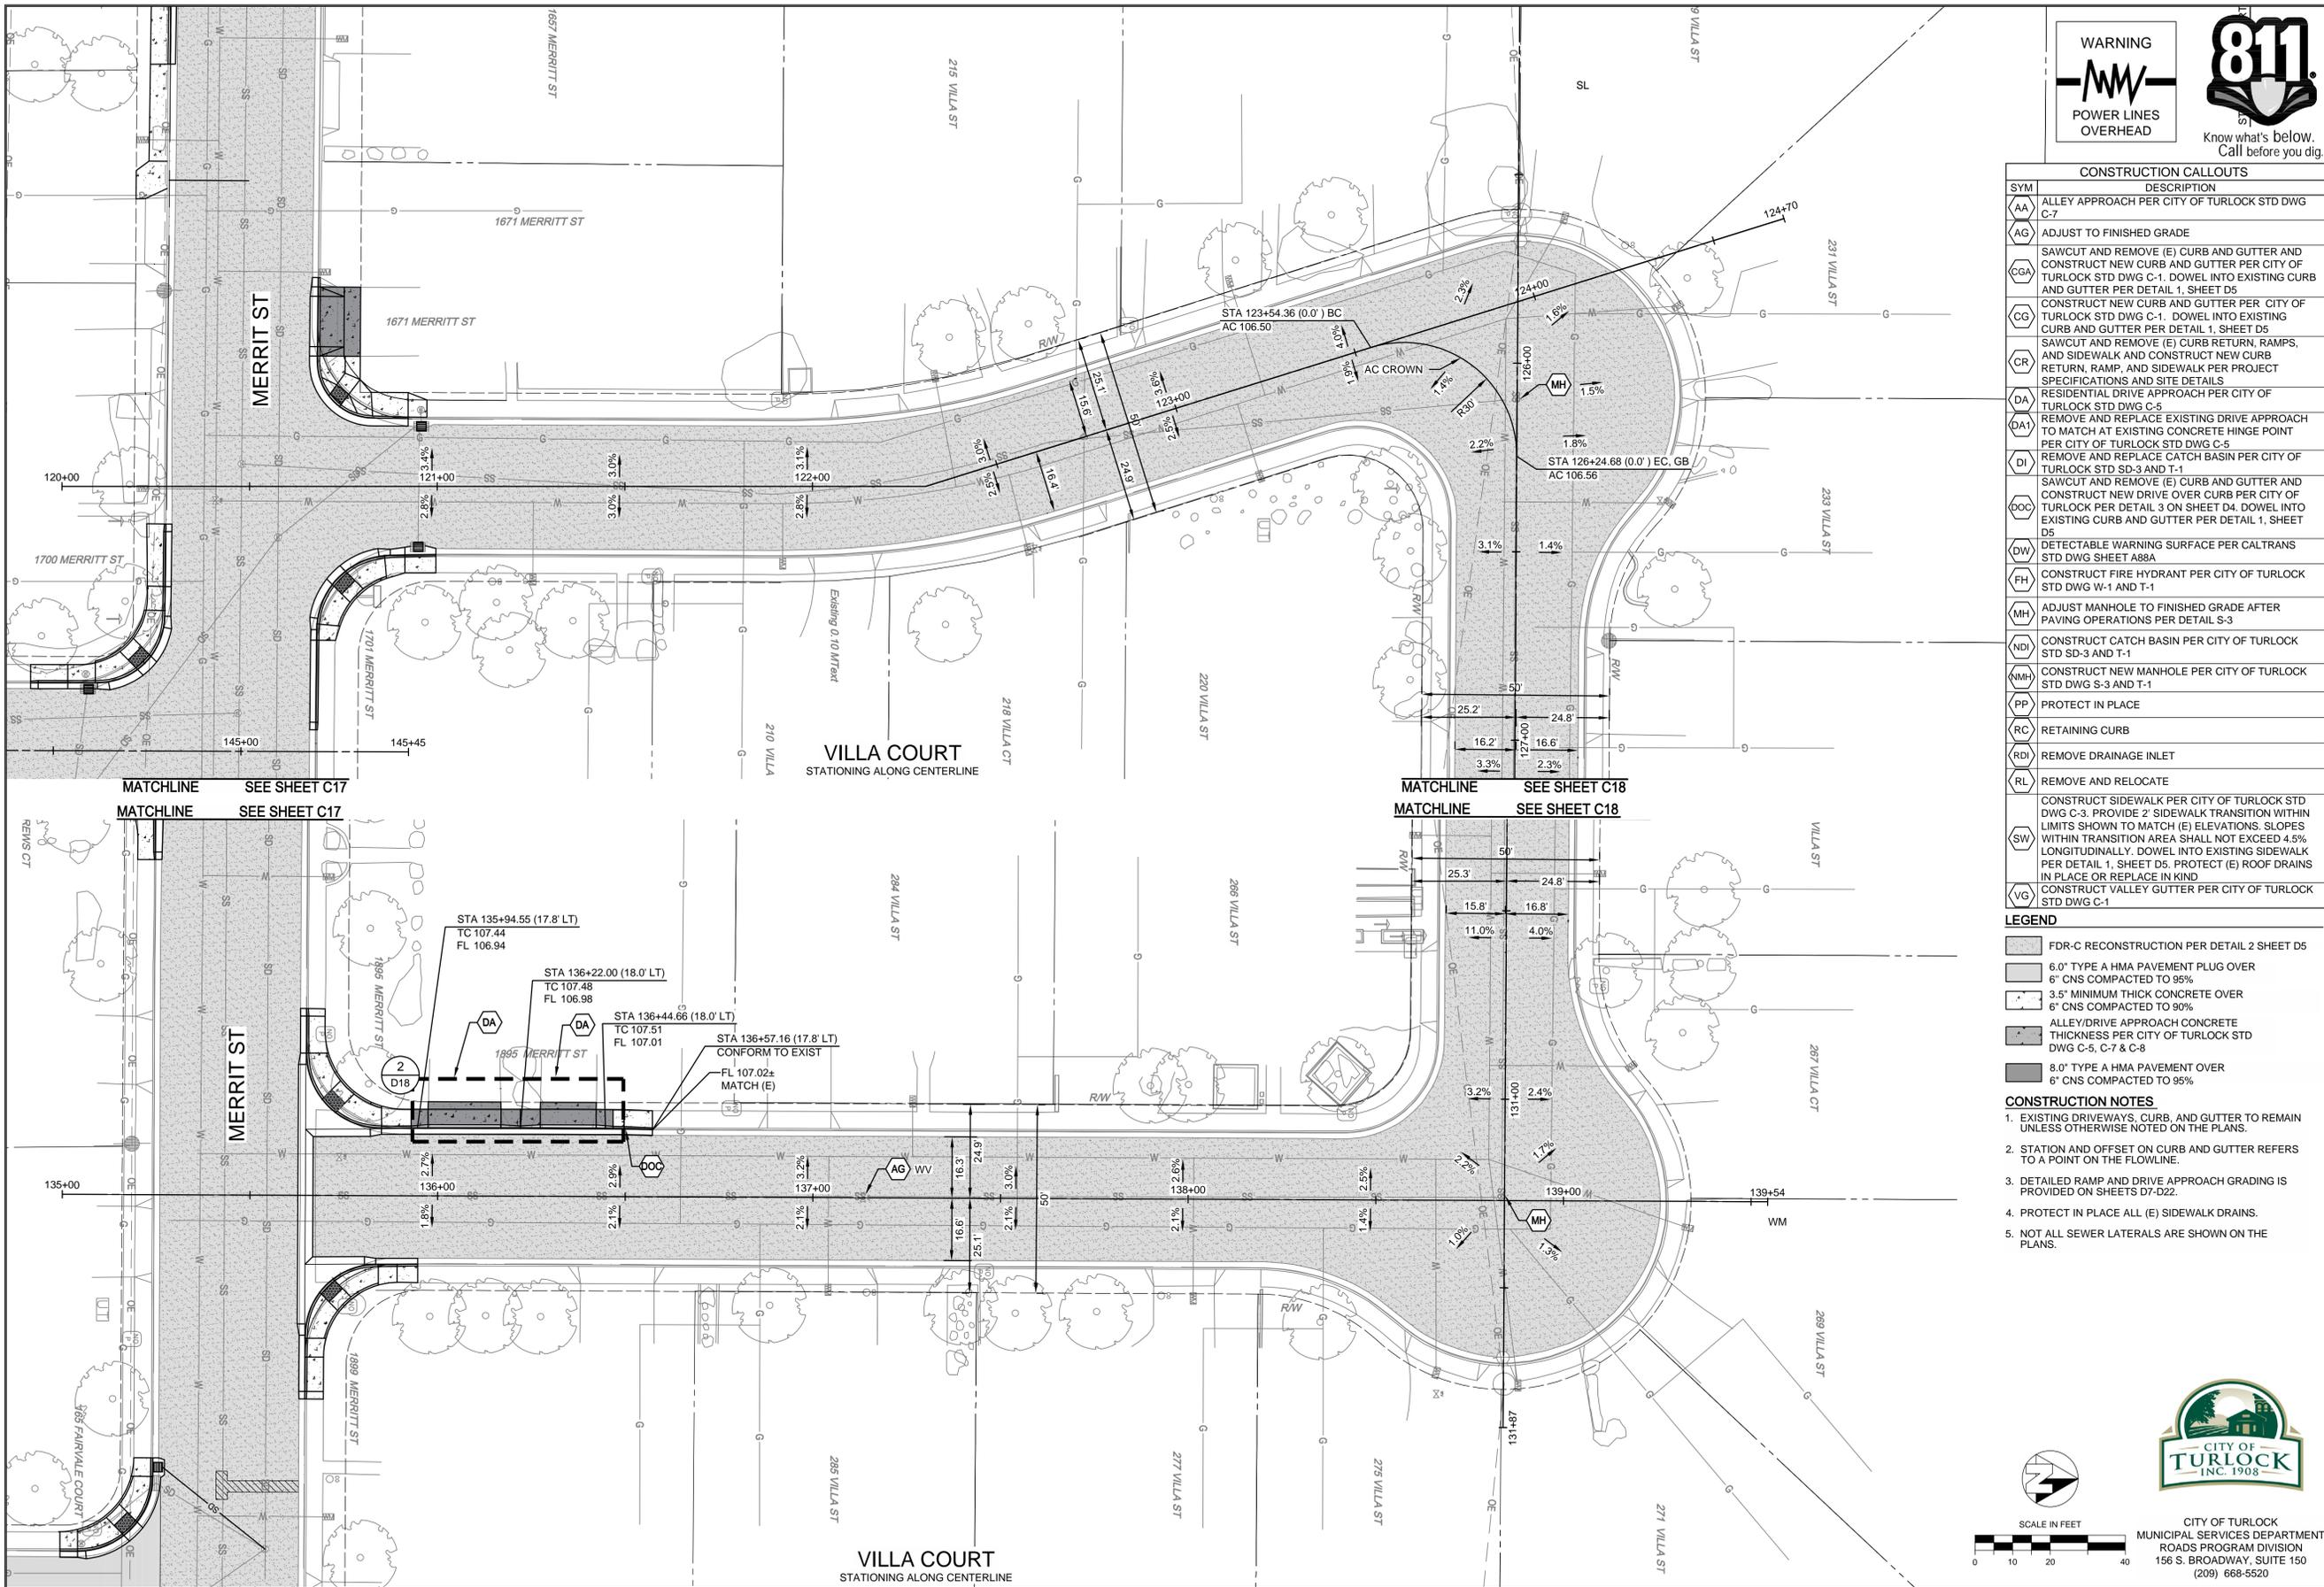
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 DATE: JAN 2026  
 JOB NO: 229224001  
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 PHASE: 3

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 SHEET **C18**  
 21 OF 78

SCALE IN FEET

CITY OF TURLOCK  
 MUNICIPAL SERVICES DEPARTMENT  
 ROADS PROGRAM DIVISION  
 156 S. BROADWAY, SUITE 150  
 (209) 668-5520

1/19/2026 9:07 AM C:\Turlock\_City of 229224001\2024 Road Rehab\300 CAD\343 Sheet C18.dwg - 132+00.dwg - Arnette Fox



CONSTRUCTION CALLOUTS	
SYM	DESCRIPTION
AA	ALLEY APPROACH PER CITY OF TURLOCK STD DWG C-7
AG	ADJUST TO FINISHED GRADE
CGA	SAWCUT AND REMOVE (E) CURB AND GUTTER AND CONSTRUCT NEW CURB AND GUTTER PER CITY OF TURLOCK STD DWG C-1. DOWEL INTO EXISTING CURB AND GUTTER PER DETAIL 1, SHEET D5
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VG	CONSTRUCT VALLEY GUTTER PER CITY OF TURLOCK STD DWG C-1


**LEGEND**

- FDR-C RECONSTRUCTION PER DETAIL 2 SHEET D5
- 6.0" TYPE A HMA PAVEMENT PLUG OVER 6" CNS COMPACTED TO 95%
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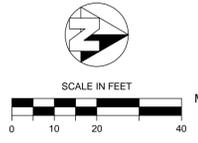
NO.	REVISION	BY	DATE





**CITY OF TURLOCK**  
ROADS PROGRAM CIP  
CITY PROJECT NO. 23-068, PACKAGE 3  
STREET PLAN  
VILLA CT STA 120+00 - 124+70 AND 135+00 - 139+50

**PROVOST & PRITCHARD**  
405 W FIR AVENUE  
TURLOCK, CA 95259  
PHONE (559) 449-2700  
FAX (559) 449-2715  
www.provostandpritchard.com

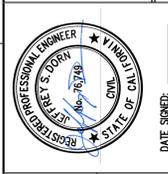DESIGN ENGINEER: JEFF DORN	LICENSE NO: 76749
DRAFTED BY: AR	CHECKED BY: JD
DATE: JAN 2026	
JOB NO: 229224001	
PROJECT NO: 229224001	
PHASE: 3	
ORIGINAL SCALE SHOWN IS ONE INCH. ADJUST SCALE FOR REDUCED OR ENLARGED PLANS.	
SHEET <b>C19</b>	
22 OF 78	



CITY OF TURLOCK  
MUNICIPAL SERVICES DEPARTMENT  
ROADS PROGRAM DIVISION  
156 S. BROADWAY, SUITE 150  
(209) 668-5520

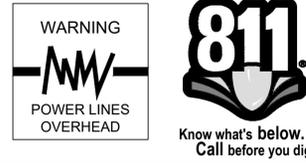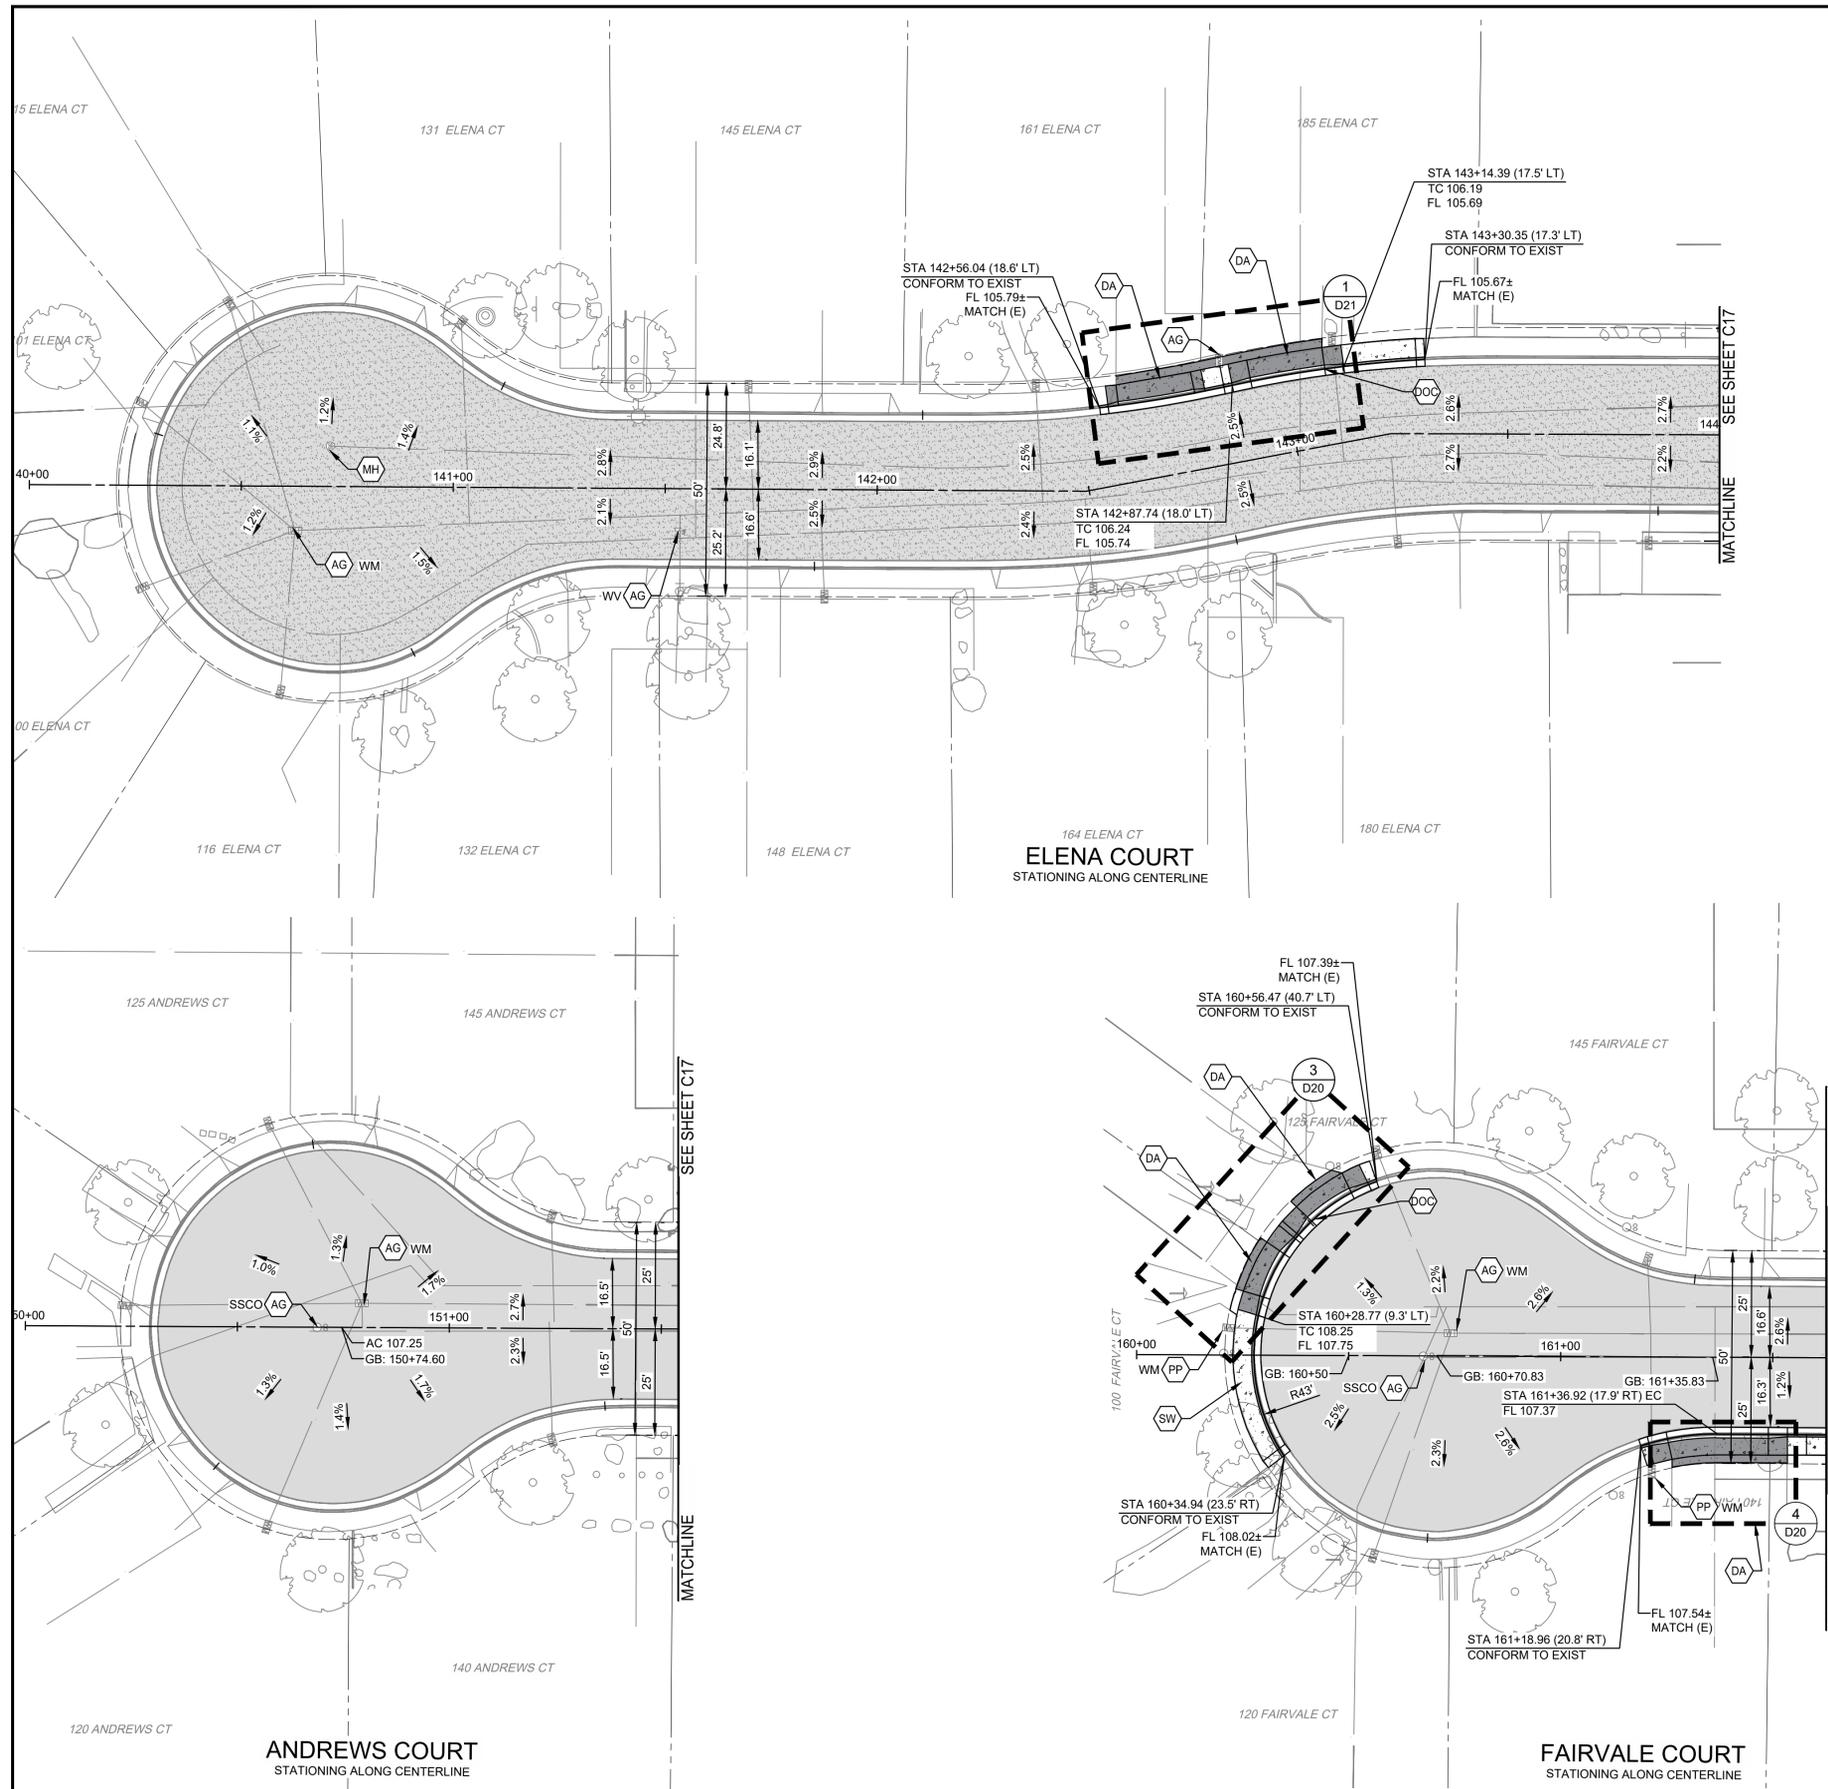


CONSTRUCTION CALLOUTS	
SYM	DESCRIPTION
AA	ALLEY APPROACH PER CITY OF TURLOCK STD DWG C-7
AG	ADJUST TO FINISHED GRADE
CGA	SAWCUT AND REMOVE (E) CURB AND GUTTER AND CONSTRUCT NEW CURB AND GUTTER PER CITY OF TURLOCK STD DWG C-1. DOWEL INTO EXISTING CURB AND GUTTER PER DETAIL 1, SHEET D5
CG	CONSTRUCT NEW CURB AND GUTTER PER CITY OF TURLOCK STD DWG C-1. DOWEL INTO EXISTING CURB AND GUTTER PER DETAIL 1, SHEET D5
CR	SAWCUT AND REMOVE (E) CURB RETURN, RAMPS, AND SIDEWALK AND CONSTRUCT NEW CURB RETURN, RAMP, AND SIDEWALK PER PROJECT SPECIFICATIONS AND SITE DETAILS
DA	RESIDENTIAL DRIVE APPROACH PER CITY OF TURLOCK STD DWG C-5
DA1	REMOVE AND REPLACE EXISTING DRIVE APPROACH TO MATCH AT EXISTING CONCRETE HINGE POINT PER CITY OF TURLOCK STD DWG C-5
DI	REMOVE AND REPLACE CATCH BASIN PER CITY OF TURLOCK STD SD-3 AND T-1
DOC	SAWCUT AND REMOVE (E) CURB AND GUTTER AND CONSTRUCT NEW DRIVE OVER CURB PER CITY OF TURLOCK PER DETAIL 3 ON SHEET D4. DOWEL INTO EXISTING CURB AND GUTTER PER DETAIL 1, SHEET D5
DW	DETECTABLE WARNING SURFACE PER CALTRANS STD DWG SHEET A88A
FH	CONSTRUCT FIRE HYDRANT PER CITY OF TURLOCK STD DWG W-1 AND T-1
MH	ADJUST MANHOLE TO FINISHED GRADE AFTER PAVING OPERATIONS PER DETAIL S-3
NDI	CONSTRUCT CATCH BASIN PER CITY OF TURLOCK STD SD-3 AND T-1
NMH	CONSTRUCT NEW MANHOLE PER CITY OF TURLOCK STD DWG S-3 AND T-1
PP	PROTECT IN PLACE
RC	RETAINING CURB
RDI	REMOVE DRAINAGE INLET
RL	REMOVE AND RELOCATE
SW	CONSTRUCT SIDEWALK PER CITY OF TURLOCK STD DWG C-3. PROVIDE 2' SIDEWALK TRANSITION WITHIN LIMITS SHOWN TO MATCH (E) ELEVATIONS. SLOPES WITHIN TRANSITION AREA SHALL NOT EXCEED 4.5% LONGITUDINALLY. DOWEL INTO EXISTING SIDEWALK PER DETAIL 1, SHEET D5. PROTECT (E) ROOF DRAINS IN PLACE OR REPLACE IN KIND
VG	CONSTRUCT VALLEY GUTTER PER CITY OF TURLOCK STD DWG C-1

**LEGEND**

- FDR-C RECONSTRUCTION PER DETAIL 2 SHEET D5
- 6.0" TYPE A HMA PAVEMENT PLUG OVER 6" CNS COMPACTED TO 95%
- 3.5" MINIMUM THICK CONCRETE OVER 6" CNS COMPACTED TO 90%
- ALLEY/DRIVE APPROACH CONCRETE THICKNESS PER CITY OF TURLOCK STD DWG C-5, C-7 & C-8
- 8.0" TYPE A HMA PAVEMENT OVER 6" CNS COMPACTED TO 95%

- CONSTRUCTION NOTES**
- EXISTING DRIVEWAYS, CURB, AND GUTTER TO REMAIN UNLESS OTHERWISE NOTED ON THE PLANS.
  - STATION AND OFFSET ON CURB AND GUTTER REFERS TO A POINT ON THE FLOWLINE.
  - DETAILED RAMP AND DRIVE APPROACH GRADING IS PROVIDED ON SHEETS D7-D22.
  - PROTECT IN PLACE ALL (E) SIDEWALK DRAINS.
  - NOT ALL SEWER LATERALS ARE SHOWN ON THE PLANS.

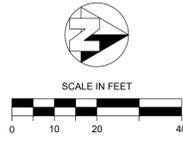

CITY OF TURLOCK  
MUNICIPAL SERVICES DEPARTMENT  
ROADS PROGRAM DIVISION  
156 S. BROADWAY, SUITE 150  
(209) 668-5520

**BID SET**  
1/22/2026

**CITY OF TURLOCK**  
ROADS PROGRAM CIP  
CITY PROJECT No. 23-068, PACKAGE 3  
STREET PLAN  
ELENA CR ANDREWS CT AND FAIRVALE CT

**PROVOST & PRITCHARD**  
425 W. FIR AVENUE  
TURLOCK, CA 95259  
PHONE (209) 449-2700  
FAX (209) 449-2719  
www.provostandpritchard.com

DESIGN ENGINEER:  
JEFF DORN  
LICENSE NO:  
76,749

DRAFTED BY: AR  
CHECKED BY: JD

DATE: JAN 2026  
JOB NO: 229224001  
PROJECT NO: 229224001  
PHASE: 3




ORIGINAL SCALE SHOWN IS ONE INCH. ADJUST SCALE FOR REDUCED OR ENLARGED PLANS.

SHEET **C20**  
23 OF 78

DATE SIGNED: \_\_\_\_\_  
NO. \_\_\_\_\_  
REVISION \_\_\_\_\_  
BY \_\_\_\_\_  
DATE \_\_\_\_\_

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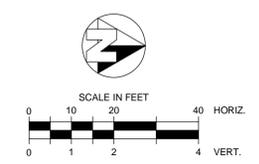


CONSTRUCTION CALLOUTS	
SYM	DESCRIPTION
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AG	ADJUST TO FINISHED GRADE
CGA	SAWCUT AND REMOVE (E) CURB AND GUTTER AND CONSTRUCT NEW CURB AND GUTTER PER CITY OF TURLOCK STD DWG C-1. DOWEL INTO EXISTING CURB AND GUTTER PER DETAIL 1, SHEET D5
CG	CONSTRUCT NEW CURB AND GUTTER PER CITY OF TURLOCK STD DWG C-1. DOWEL INTO EXISTING CURB AND GUTTER PER DETAIL 1, SHEET D5
CR	SAWCUT AND REMOVE (E) CURB RETURN, RAMPS, AND SIDEWALK AND CONSTRUCT NEW CURB RETURN, RAMP, AND SIDEWALK PER PROJECT SPECIFICATIONS AND SITE DETAILS
DA	RESIDENTIAL DRIVE APPROACH PER CITY OF TURLOCK STD DWG C-5
DA1	REMOVE AND REPLACE EXISTING DRIVE APPROACH TO MATCH AT EXISTING CONCRETE HINGE POINT PER CITY OF TURLOCK STD DWG C-5
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RC	RETAINING CURB
RDI	REMOVE DRAINAGE INLET
RL	REMOVE AND RELOCATE
SW	CONSTRUCT SIDEWALK PER CITY OF TURLOCK STD DWG C-3. PROVIDE 2' SIDEWALK TRANSITION WITHIN LIMITS SHOWN TO MATCH (E) ELEVATIONS. SLOPES WITHIN TRANSITION AREA SHALL NOT EXCEED 4.5% LONGITUDINALLY. DOWEL INTO EXISTING SIDEWALK PER DETAIL 1, SHEET D5. PROTECT (E) ROOF DRAINS IN PLACE OR REPLACE IN KIND
VG	CONSTRUCT VALLEY GUTTER PER CITY OF TURLOCK STD DWG C-1

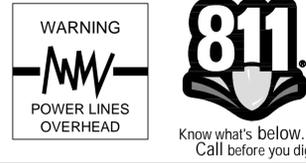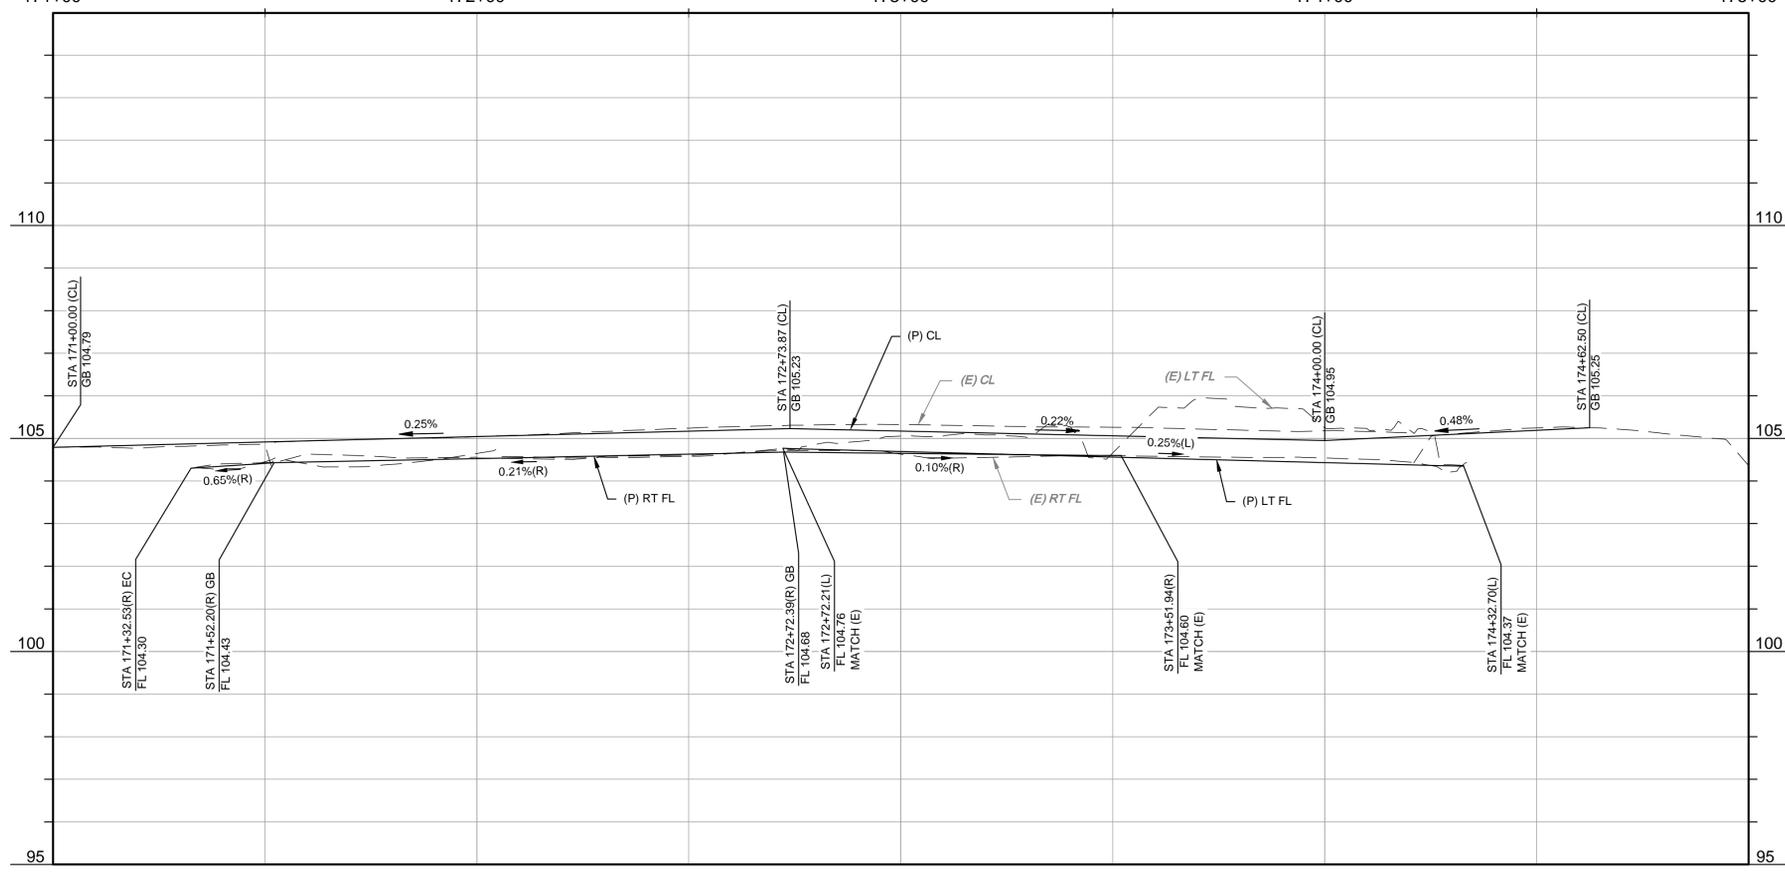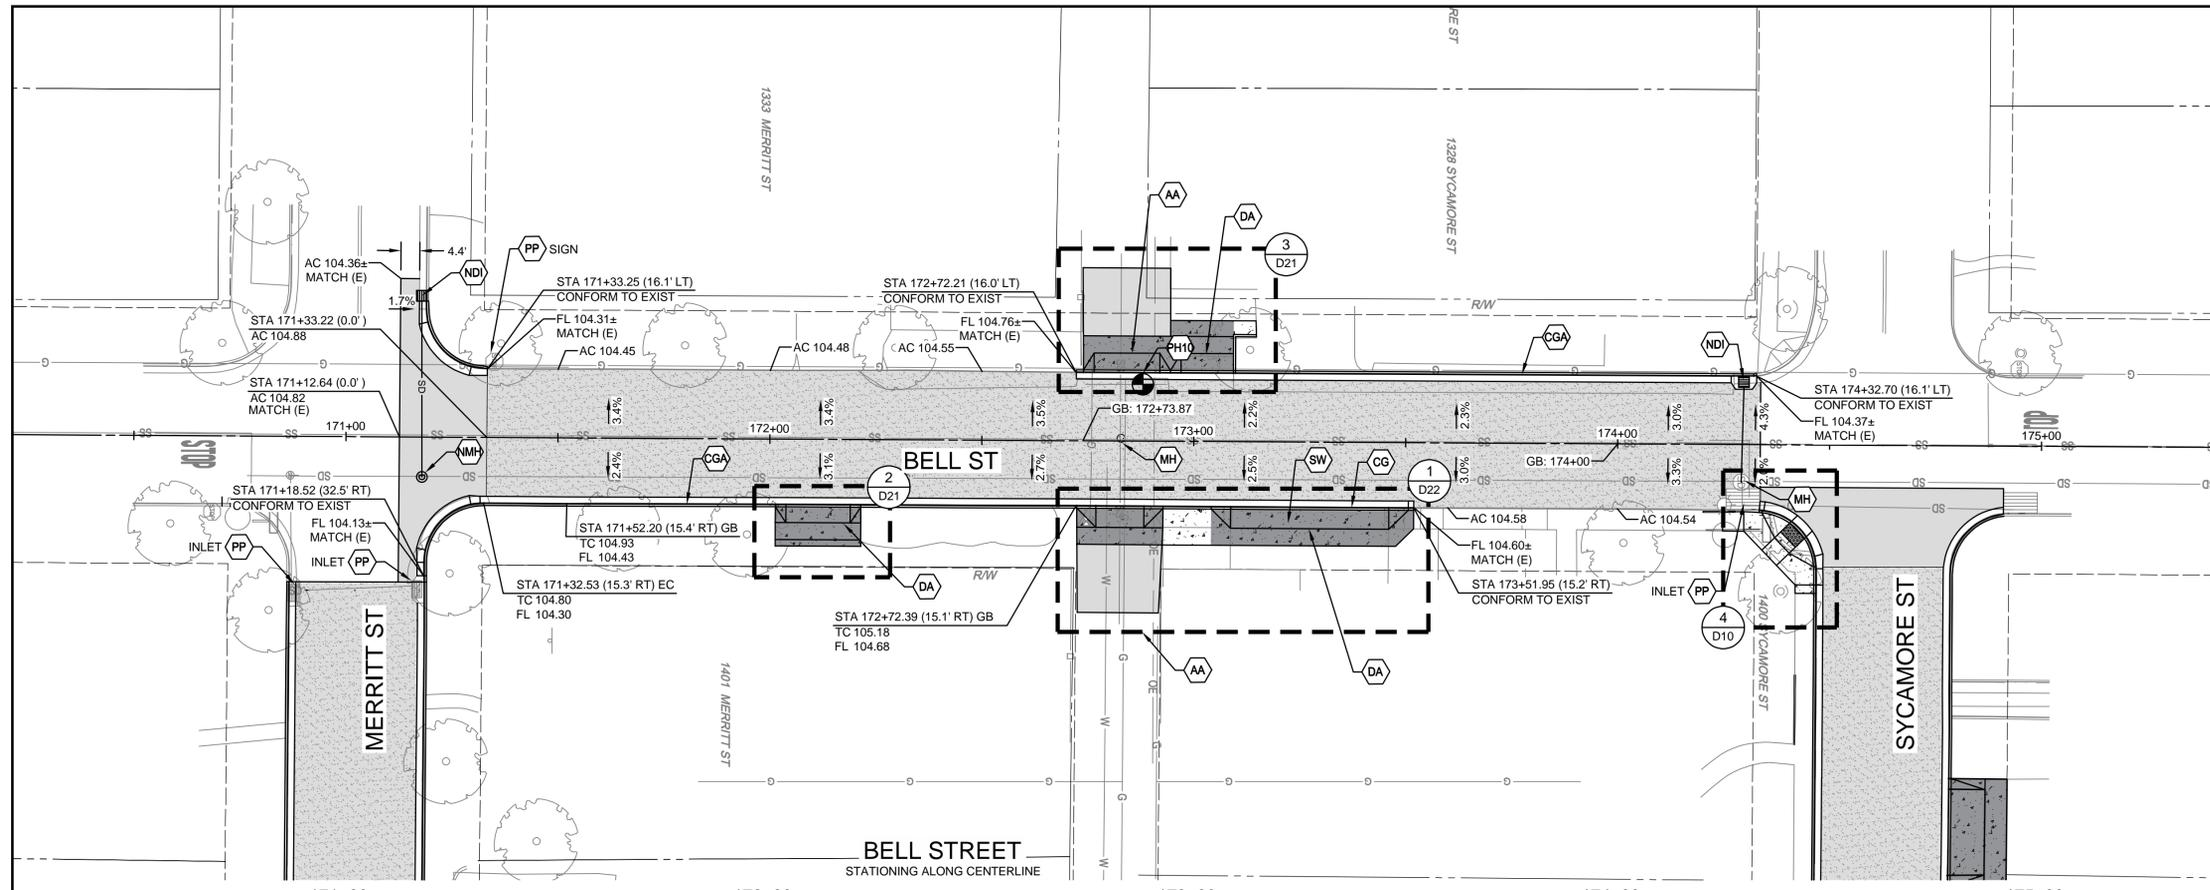- LEGEND**
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  - 6.0" TYPE A HMA PAVEMENT PLUG OVER 6" CNS COMPACTED TO 95%
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  - ALLEY/DRIVE APPROACH CONCRETE THICKNESS PER CITY OF TURLOCK STD DWG C-5, C-7 & C-8
  - 8.0" TYPE A HMA PAVEMENT OVER 6" CNS COMPACTED TO 95%

- CONSTRUCTION NOTES**
- EXISTING DRIVEWAYS, CURB, AND GUTTER TO REMAIN UNLESS OTHERWISE NOTED ON THE PLANS.
  - STATION AND OFFSET ON CURB AND GUTTER REFERS TO A POINT ON THE FLOWLINE.
  - DETAILED RAMP AND DRIVE APPROACH GRADING IS PROVIDED ON SHEETS D7-D22.
  - PROTECT IN PLACE ALL (E) SIDEWALK DRAINS.
  - NOT ALL SEWER LATERALS ARE SHOWN ON THE PLANS.

Turlock Pothole Report				
Pothole Number	Utility	Pipe Material	Depth Top of Pipe	Pipe Diameter
PH-10	Gas	Unknown	1.83'	3"



CITY OF TURLOCK  
MUNICIPAL SERVICES DEPARTMENT  
ROADS PROGRAM DIVISION  
156 S. BROADWAY, SUITE 150  
(209) 668-5520

**BID SET**  
1/22/2026

CITY OF TURLOCK  
ROADS PROGRAM CIP  
CITY PROJECT NO. 23-068, PACKAGE 3  
STREET PLAN  
BELL ST STA 171+00 - 175+00

DESIGN ENGINEER:  
JEFF DORN  
LICENSE NO:  
76,749

DRAFTED BY: AR  
CHECKED BY: JD  
DATE: JAN 2026  
JOB NO: 229224001  
PROJECT NO: 229224001  
PHASE: 3

ORIGINAL SCALE SHOWN IS ONE INCH. ADJUST SCALE FOR REDUCED OR ENLARGED PLANS.  
SHEET **C21**  
24 OF 78

PROVOST & PRITCHARD  
405 W. FIR AVENUE  
TURLOCK, CA 95259  
PHONE (559) 449-2700  
FAX (559) 449-2715  
www.provostandpritchard.com

1/19/2026 9:36 AM G:\Turlock\_City of 229224001-2024-Road Rehab\300 CAD\345 Sheet\Sheet102\_Plan\_Maps\C20 BELL ST STA 171+00 TO 175+00.dwg -Annamarie Fox



**VERTICAL CURB**

**CURB AND GUTTER**

**VALLEY GUTTER**

**NOTES:**

- INSTALL WEAKENED PLANE JOINT AT 10' INTERVALS
- GUTTER FLOW LINES SHALL BE WATER TESTED FOR FLOW
- FLOW LINE OF GUTTERS SHALL SLOPE AT 0.20% MIN, UNLESS OTHERWISE APPROVED BY THE CITY ENGINEER

DRAWN BY: JSH		CITY OF TURLOCK		DRAWING NO. C-1	
CHECK BY: NBB		APPROVED BY: <i>M. Pitscock</i>		COUNCIL APPROVAL DEC, 2015	
SCALE: NONE		CITY ENGINEER - MICHAEL G. PITCOCK - RCE 52694			

**CURB, GUTTER AND SIDEWALK PATTERN**

**NOTES:**

- ALL CONCRETE WORK SHALL BE CONSTRUCTED IN ACCORDANCE WITH CITY STANDARD SPECIFICATIONS
- WEAKENED PLANE JOINTS SHALL HAVE A MIN DEPTH OF 1/2" AND SHALL NOT EXCEED 1/8" IN WIDTH
- IN CASES OF MONOLITHIC CURB AND SIDEWALK, A 1/4" SCORE MARK SHALL BE INSTALLED BETWEEN THE BACK OF CURB AND SIDEWALK
- CURB, GUTTER AND SIDEWALK SHALL HAVE WEAKENED PLANE JOINTS INSTALLED AT ALL LOT LINES, THE CENTER OF DRIVEWAY APPROACHES AND AT INTERVALS NOT TO EXCEED 10 FEET
- EXPANSION JOINTS SHALL BE INSTALLED AT CURB RETURNS, EDGES OF DRIVEWAYS AND AROUND UTILITY POLES TO PREVENT CONTACT WITH CONCRETE AND AT INTERVALS NOT TO EXCEED 50 FEET
- SCORE MARKS SHALL HAVE A MIN. DEPTH OF 1/4"
- AN EDGING TOOL SHALL BE USED TO FINISH ALL JOINTS AND SCORE MARKS
- REFER TO STANDARD DRAWING NO. ST-12 AND ST-13 FOR REQUIREMENTS WITHIN KNUCKLES & CUL-DE-SACS
- RETURNS SHALL HAVE 0.20" DROP

DRAWN BY: JSH		CITY OF TURLOCK		DRAWING NO. C-2	
CHECK BY: NBB		APPROVED BY: <i>M. Pitscock</i>		COUNCIL APPROVAL DEC, 2015	
SCALE: NONE		CITY ENGINEER - MICHAEL G. PITCOCK - RCE 52694			

**RESIDENTIAL AND COMMERCIAL SIDEWALK**

**NOTES:**

- ALL CONCRETE WORK SHALL BE CONSTRUCTED IN ACCORDANCE WITH THE CITY STANDARD SPECIFICATIONS
- SEE ST-1 FOR ADDITIONAL INFORMATION REGARDING SIDEWALK LOCATION
- SEE C-2 FOR LOCATIONS OF JOINTS AND SCORE MARKS
- PROVIDE MIN 48" OF CLEARANCE AROUND OBSTRUCTIONS. SEE C-4.

DRAWN BY: JSH		CITY OF TURLOCK		DRAWING NO. C-3	
CHECK BY: NBB		APPROVED BY: <i>M. Pitscock</i>		COUNCIL APPROVAL DEC, 2015	
SCALE: NONE		CITY ENGINEER - MICHAEL G. PITCOCK - RCE 52694			

**SIDEWALK OBSTRUCTION TRANSITION**

DRAWN BY: JSH		CITY OF TURLOCK		DRAWING NO. C-4	
CHECK BY: NBB		APPROVED BY: <i>M. Pitscock</i>		COUNCIL APPROVAL DEC, 2015	
SCALE: NONE		CITY ENGINEER - MICHAEL G. PITCOCK - RCE 52694			

**RESIDENTIAL DRIVEWAY APPROACH**

**NOTES:**

- SUB-GRADE COMPACTION SHALL BE 95%
- CONCRETE SURFACE SHALL BE TROWELED SMOOTH & HAIR BROOMED
- CONCRETE CURING SHALL BE PER CURRENT CALTRANS SPECIFICATIONS
- GUTTER FLOW LINE SHALL BE WATER TESTED FOR FLOW
- DRIVEWAY BREAKDOWN LIP SHALL BE 1-1/2"
- PROVIDE A WEAKENED PLANE JOINT OF 1-1/2" MINIMUM DEPTH AND 1/8" MAXIMUM WIDTH IN THE MIDDLE OF THE DRIVEWAY APPROACH AND GUTTER ON MONOLITHIC CURB, GUTTER AND SIDEWALK INSTALL EXPANSION JOINTS AT EDGES OF DRIVEWAY
- MAXIMUM DRIVEWAY WIDTHS ARE AS FOLLOWS:  
TWO DOOR GARAGE IS 25 FEET  
THREE CAR GARAGE IS 30 FEET, PROVIDING THE DRIVEWAY WIDTH DOES NOT EXCEED 40% OF TOTAL LOT FRONTAGE
- CURB, GUTTER AND DRIVEWAY SHALL BE POURED MONOLITHICALLY

DRAWN BY: JSH		CITY OF TURLOCK		DRAWING NO. C-5	
CHECK BY: NBB		APPROVED BY: <i>M. Pitscock</i>		COUNCIL APPROVAL DEC, 2015	
SCALE: NONE		CITY ENGINEER - MICHAEL G. PITCOCK - RCE 52694			

**ALLEY APPROACH**

**NOTES:**

- COMMERCIAL ALLEYS SHALL HAVE A SLOPE OF 1% MIN. AND A CROSS SLOPE OF 2% MAX.
- ALL ALLEY APPROACHES SHALL HAVE A MINIMUM THICKNESS OF 7-1/2"
- ALL CONCRETE WORK SHALL BE IN ACCORDANCE WITH STANDARD SPECIFICATIONS.
- GUTTER FLOW LINE & VALLEY GUTTER SHALL BE WATER TESTED FOR FLOW.
- FINISH GRADE AT BACK OF DRIVEWAY SHALL MATCH ALLEY PAVEMENT.
- WEAKENED PLANE JOINT SHALL BE 1-1/2" MIN. DEPTH AND 1/8" MAX. WIDTH.

DRAWN BY: JSH		CITY OF TURLOCK		DRAWING NO. C-7	
CHECK BY: NBB		APPROVED BY: <i>M. Pitscock</i>		COUNCIL APPROVAL DEC, 2015	
SCALE: NONE		CITY ENGINEER - MICHAEL G. PITCOCK - RCE 52694			

**COMMERCIAL/INDUSTRIAL DRIVEWAY APPROACH**

**NOTES:**

- SUB-GRADE COMPACTION SHALL BE 95%
- CONCRETE SURFACE SHALL BE TROWELED SMOOTH & HAIR BROOMED
- CONCRETE CURING SHALL BE PER CURRENT CALTRANS SPECIFICATIONS
- GUTTER FLOW LINE SHALL BE WATER TESTED FOR FLOW
- PROVIDE A WEAKENED PLANE JOINT OF 1-1/2" MINIMUM DEPTH AND 1/8" MAXIMUM WIDTH IN THE MIDDLE OF THE DRIVEWAY APPROACH AND GUTTER
- MULTI FAMILY UNITS SHALL USE THIS APPROACH
- 150' MIN. FROM D/W CENTERLINE TO CURB RETURN
- DRIVEWAYS OVER 40' WIDE MUST BE APPROVED BY THE CITY ENGINEER
- UP TO 1-1/2" GUTTER LIP MAY BE PROJECTED THROUGH DRIVEWAY WITH CITY ENGINEER'S APPROVAL

DRAWN BY: JSH		CITY OF TURLOCK		DRAWING NO. C-8	
CHECK BY: NBB		APPROVED BY: <i>M. Pitscock</i>		COUNCIL APPROVAL DEC, 2015	
SCALE: NONE		CITY ENGINEER - MICHAEL G. PITCOCK - RCE 52694			

**COMMERCIAL/INDUSTRIAL DRIVEWAY APPROACH**

**NOTES:**

- THE APPROACH SHALL HAVE COLD JOINTS AT THE PROPERTY LINE AND AT EACH END. A WEAKENED PLANE JOINT IS REQUIRED AT THE END OF THE APPROACH
- THE APPROACH SHALL BE 7-1/2" THICK
- WIDTHS GREATER THAN 40' MUST BE APPROVED BY THE CITY ENGINEER
- INTERMEDIATE WEAKENED PLANE JOINTS IN ACCORDANCE WITH SECTION 13-1.06, CONSTRUCTION PROCEDURES OF STANDARD SPECIFICATIONS
- UP TO 1-1/2" GUTTER LIP MAY BE PROJECTED THROUGH DRIVEWAY WITH CITY ENGINEER'S APPROVAL

DRAWN BY: JSH		CITY OF TURLOCK		DRAWING NO. C-9	
CHECK BY: NBB		APPROVED BY: <i>M. Pitscock</i>		COUNCIL APPROVAL DEC, 2015	
SCALE: NONE		CITY ENGINEER - MICHAEL G. PITCOCK - RCE 52694			

**BID SET**  
1/22/2026


**CITY OF TURLOCK**  
ROADS PROGRAM CIP  
CITY PROJECT No. 23-068, PACKAGE 3  
DETAILS

**STANDARD DETAILS**

DESIGN ENGINEER: JEFF DORN  
LICENSE NO: 76,749  
DATE: JAN 2026  
JOB NO: 229224001  
PROJECT NO: 229224001  
PHASE: 3

ORIGINAL SCALE SHOWN IS ONE INCH. ADJUST SCALE FOR REDUCED OR ENLARGED PLANS.  
SHEET **D1** OF 78


1/19/2026 9:11 AM C:\Turlock\_Civil\_Details\01\_STANDARD DETAILS.dwg -Ammarie Fox

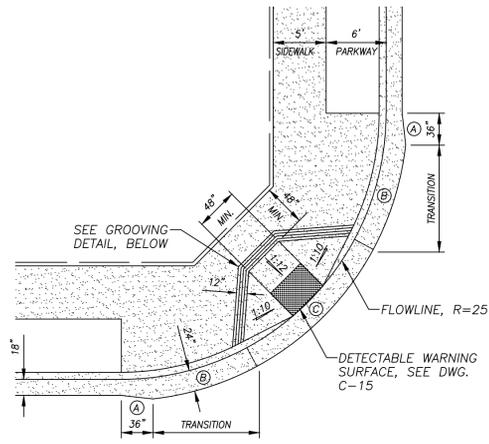

- Ⓐ CONCRETE LIP SHALL EXTEND FROM 18" TO 24" WITHIN THE FIRST 3 FEET OF THE RADIUS POINT. LIP OF GUTTER SHALL BE 2" HIGHER THAN FLOWLINE
- Ⓑ CONCRETE LIP SHALL MAINTAIN 24" FROM FLOWLINE. CONCRETE LIP SHALL TRANSITION FROM 2" TO 1" ABOVE FLOWLINE. TRANSITION SHALL BE COMPLETED BY START OF FLARED SIDES (WINGS)
- Ⓒ CONCRETE LIP SHALL MAINTAIN 24" FROM FLOWLINE AND 1" ABOVE FLOWLINE. MAXIMUM ALLOWABLE SLOPE IS 5%

**CURB RETURN PEDESTRIAN RAMP**


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 CHECK BY: NBB APPROVED BY: [Signature] COUNCIL APPROVAL DEC, 2015  
 SCALE: NONE CITY ENGINEER - MICHAEL G. PITCOCK - RCE 52694

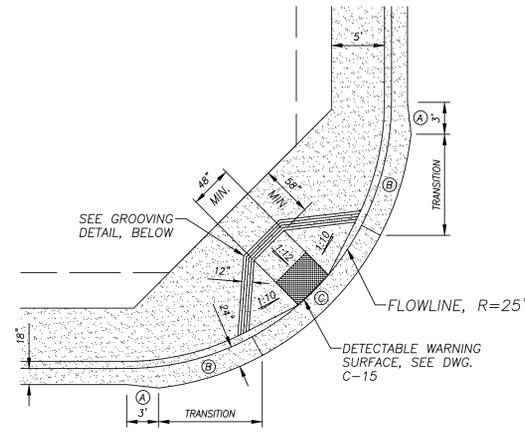

- Ⓐ CONCRETE LIP SHALL EXTEND FROM 18" TO 24" WITHIN THE FIRST 3 FEET OF THE RADIUS POINT. LIP OF GUTTER SHALL BE 2" HIGHER THAN FLOWLINE
- Ⓑ CONCRETE LIP SHALL MAINTAIN 24" FROM FLOWLINE. CONCRETE LIP SHALL TRANSITION FROM 2" TO 1" ABOVE FLOWLINE. TRANSITION SHALL BE COMPLETED BY START OF FLARED SIDES (WINGS)
- Ⓒ CONCRETE LIP SHALL MAINTAIN 24" FROM FLOWLINE AND 1" ABOVE FLOWLINE. MAXIMUM ALLOWABLE SLOPE IS 5%

**CURB RETURN PEDESTRIAN RAMP**


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 CHECK BY: NBB APPROVED BY: [Signature] COUNCIL APPROVAL DEC, 2015  
 SCALE: NONE CITY ENGINEER - MICHAEL G. PITCOCK - RCE 52694

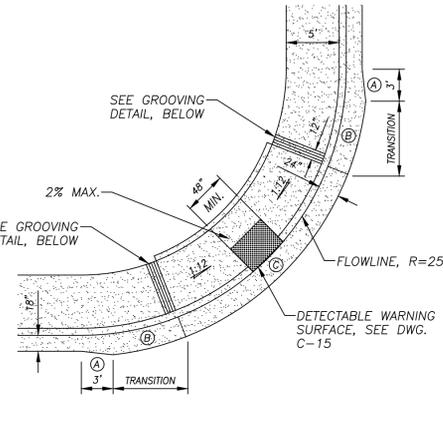

- Ⓐ CONCRETE LIP SHALL EXTEND FROM 18" TO 24" WITHIN THE FIRST 3 FEET OF THE RADIUS POINT. LIP OF GUTTER SHALL BE 2" HIGHER THAN FLOWLINE
- Ⓑ CONCRETE LIP SHALL MAINTAIN 24" FROM FLOWLINE. CONCRETE LIP SHALL TRANSITION FROM 2" TO 1" ABOVE FLOWLINE. TRANSITION SHALL BE COMPLETED BY START OF FLARED SIDES (WINGS)
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**CURB RETURN PEDESTRIAN RAMP**


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 CHECK BY: NBB APPROVED BY: [Signature] COUNCIL APPROVAL DEC, 2015  
 SCALE: NONE CITY ENGINEER - MICHAEL G. PITCOCK - RCE 52694

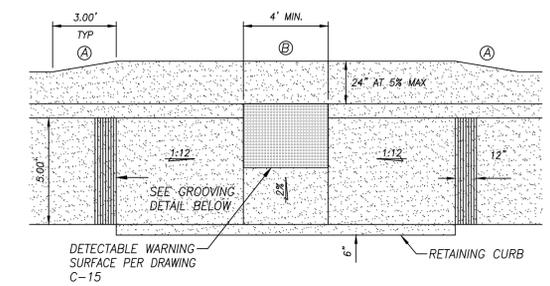

- Ⓐ CONCRETE LIP SHALL TRANSITION FROM 18" TO 24" WITHIN 3 FEET OF THE TOP OF THE RAMP. LIP OF GUTTER SHALL TRANSITION FROM 2" TO 1" ABOVE FLOWLINE.
- Ⓑ CONCRETE LIP SHALL MAINTAIN 24" FROM FLOWLINE AND 1" ABOVE FLOWLINE. MAXIMUM ALLOWABLE SLOPE IS 5%

**MID-BLOCK PEDESTRIAN RAMP ~ CURB ADJACENT**


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 CHECK BY: NBB APPROVED BY: [Signature] COUNCIL APPROVAL DEC, 2015  
 SCALE: NONE CITY ENGINEER - MICHAEL G. PITCOCK - RCE 52694

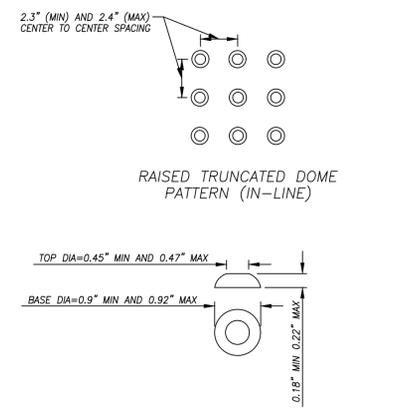

- NOTES:
- CAST-IN-PLACE PREFABRICATED DETECTABLE WARNING SURFACE SHALL BE COMPOSED OF A VITRIFIED POLYMER INCLUDING ALUMINUM OXIDE ("ARMOR-TILE" OR APPROVED EQUAL). COLOR SHALL BE SAFETY YELLOW. FIELD SURFACE AND TOP OF DOMES TO HAVE A SLIP RESISTANCE SURFACE.
  - CURB RAMPS SHALL HAVE A DETECTABLE WARNING SURFACE THAT EXTENDS THE FULL WIDTH AND 3'-0" DEPTH OF THE RAMP. A 4'-0" WIDE DETECTABLE WARNING SURFACE MAY BE USED ON A 4'-2" WIDE CURB RAMP. DETECTABLE WARNING SURFACES SHALL CONFORM TO THE REQUIREMENTS IN THE STANDARD SPECIFICATIONS.

**DETECTABLE WARNING SURFACE**

DRAWN BY: JSH CITY OF TURLOCK DRAWING NO. C-15  
 CHECK BY: NBB APPROVED BY: [Signature] COUNCIL APPROVAL DEC, 2015  
 SCALE: NONE CITY ENGINEER - MICHAEL G. PITCOCK - RCE 52694

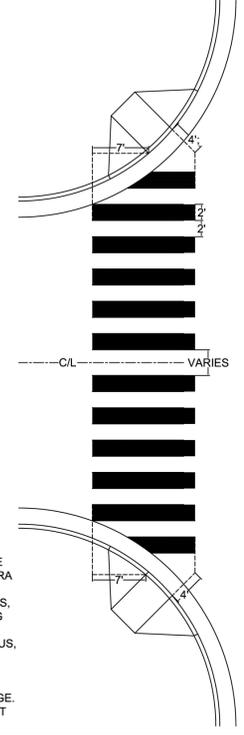


- NOTES
- LAYOUT CROSSWALK STARTING FROM EACH SIDE WORKING TOWARDS THE CENTERLINE. ANY EXTRA SPACE SHALL BE IN THE MIDDLE.
  - USING THE CURB RAMP WITH THE LARGER RADIUS, MARK 7FT FROM EDGE OF DETECTABLE WARNING DEVICE.
  - USING THE CURB RAMP WITH THE SMALLER RADIUS, MARK 4FT FROM FLOWLINE. ALIGN WITH OUTER EDGE OF RAMP.
  - AT INTERSECTIONS WITH VALLEY GUTTERS, THE CROSSWALK SHALL STOP AT THE CONCRETE EDGE.
  - STRIPING SHALL BE THERMOPLASTIC ON ASPHALT AND PAINT ON CONCRETE.


**(MODIFIED CITY STANDARD DETAIL C-17)**

DRAWN BY: JSH CITY OF TURLOCK DRAWING NO. C-15  
 CHECK BY: NBB APPROVED BY: [Signature] COUNCIL APPROVAL DEC, 2015  
 SCALE: NONE CITY ENGINEER - MICHAEL G. PITCOCK - RCE 52694

RESIDENTIAL STREET SECTIONS														
DESIGNATION	R/W	STREET	C/L	X"	W	M	TW	BIKE	PARK-ING	PARK-WAY	SW	LAND-SCAPE	HMA* (IN.)	AB* (IN.)
LOCAL W/ PARKWAY	56'	34'	17'	11'	N/A	N/A	10'	N/A	7'	6'	5'	N/A	3	6
COLLECTOR	72'	50'	25'	11'	N/A	N/A	12'	5'	8'	6'	5'	N/A	4	6
MINOR ARTERIAL (2 LANES)	102'	84'	42'	15'	28'	16'	12'	8'	N/A	6'	5'	4'	5	6
ARTERIAL (4 LANES)	126'	96'	48'	15'	40'	16'	24'	8'	8'	6'	5'	4'	5	6
EXPRESSWAY (4 LANES)	116'	84'	42'	15'	34'	16'	24'	10'	N/A	6'	5'	4'	5	6
EXPRESSWAY (6 LANES)	140'	126'	54'	15'	46'	16'	36'	10'	N/A	6'	5'	4'	5	6

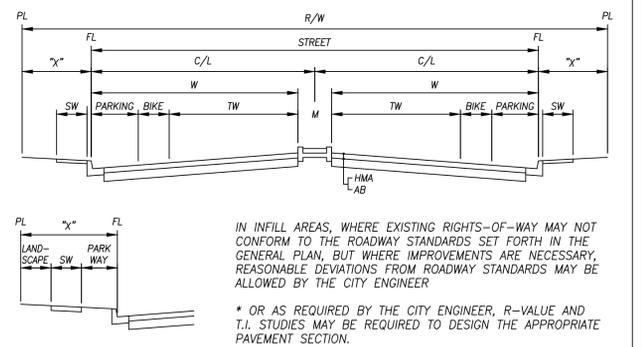


DRAWN BY: JSH CITY OF TURLOCK DRAWING NO. ST-1  
 CHECK BY: NBB APPROVED BY: [Signature] COUNCIL APPROVAL DEC, 2015  
 SCALE: NONE CITY ENGINEER - MICHAEL G. PITCOCK - RCE 52694

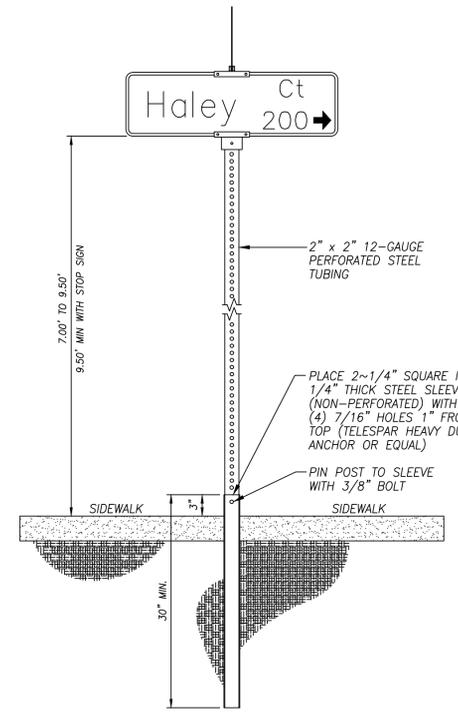

DRAWN BY: JSH CITY OF TURLOCK DRAWING NO. ST-11  
 CHECK BY: NBB APPROVED BY: [Signature] COUNCIL APPROVAL DEC, 2015  
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BID SET  
1/22/2026



CITY OF TURLOCK  
ROADS PROGRAM CIP  
CITY PROJECT No. 23-068, PACKAGE 3  
STANDARD DETAILS

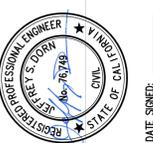PROVOST & PRITCHARD  
425 W. IIR AVENUE  
CITY OF TURLOCK, CA 95210  
PHONE (530) 449-2710  
FAX (530) 449-2715  
www.provostandpritchard.com

DESIGN ENGINEER: JEFF DORN  
 LICENSE NO: 76,749  
 DRAFTED BY: [Signature] CHECKED BY: JD  
 DATE: JAN 2026  
 JOB NO: 229224001  
 PROJECT NO: 229224001  
 PHASE: 3  
 ORIGINAL SCALE SHOWN IS ONE INCH. ADJUST SCALE FOR REDUCED OR ENLARGED PLANS.  
 SHEET D2  
 26 OF 78

### DRIVEWAY AND CORNER VISIBILITY

STREET

DRIVEWAY APPROACH

CURB

PROPERTY LINE

AREA OF CLEAR VISION (TYP)

AREA OF CLEAR VISION (TYP)

STREET

DRIVEWAY AND CORNER VISIBILITY

STREET CORNERS AND DRIVEWAYS CONNECTING WITH PUBLIC STREET SHALL BE MAINTAINED AS AREA OF UNRESTRICTED VISIBILITY ("CLEAR VISION ZONES") AS FOLLOWS:

- FOR STREET CORNERS: AT THE INTERSECTION OF 2 STREETS, THERE SHALL BE A CLEAR VISION AREA BETWEEN 3 FEET AND 8 FEET IN HEIGHT MEASURED FROM THE TOP OF THE STREET CURB. WITHIN THIS CLEAR VISION AREA, NO FENCE, LANDSCAPING OR OTHER OBJECT SHALL BE ERRECTED, PLANTED, OR ALLOWED TO GROW AND CAUSE A VISUAL OBSTRUCTION. THE CLEAR VISION AREA SHALL BE MEASURED 30 FEET FROM THE INTERSECTION OF THE STREET RIGHT-OF-WAY MEASURED ALONG BOTH OF THE RIGHT-OF-WAY LINES OF 2 INTERSECTING MINOR STREETS. UTILITY POLES AND ONE TREE MAY ENCRACH INTO THE CLEAR VISION AREA AS LONG AS THERE ARE NO TREE BRANCHES LOWER THAN 8 FEET AND THE UTILITY POLE OR TREE TRUNK DOES NOT CONSTITUTE A VISUAL HAZARD AS DETERMINED BY THE CITY ENGINEER.
- FOR DRIVEWAYS: THE CLEAR VISION AREA FOR DRIVEWAYS LINE 15 FEET FROM THE INTERSECTION OF THE EDGE OF DRIVEWAY AND THE PROPERTY LINE MEASURED ALONG BOTH THE DRIVEWAY AND THE PROPERTY LINE.
- OTHER AREAS MAY REQUIRE UNRESTRICTED VISIBILITY AS DETERMINED BY THE CITY ENGINEER.

DRAWN BY: JSH	CITY OF TURLOCK	DRAWING NO. ST-13
CHECK BY: NBB	APPROVED BY:	COUNCIL APPROVAL
SCALE: NONE	CITY ENGINEER - MICHAEL G. PITCOCK - RCE 52694	DEC, 2015

### ANGLED PARKING STALL LAYOUT

30° PARKING

45° PARKING

60° PARKING

\* MINIMUM AISLE WIDTH FOR TWO-WAY TRAFFIC

### ANGLED PARKING STALL LAYOUT

DRAWN BY: JSH	CITY OF TURLOCK	DRAWING NO. ST-19
CHECK BY: NBB	APPROVED BY:	COUNCIL APPROVAL
SCALE: NONE	CITY ENGINEER - MICHAEL G. PITCOCK - RCE 52694	DEC, 2015

### PARKING STALL LAYOUT

PERPENDICULAR PARKING

PARALLEL PARKING

DETAIL "A"      DETAIL "B"

\* MINIMUM AISLE WIDTH FOR TWO-WAY TRAFFIC

### PARKING STALL LAYOUT

DRAWN BY: JSH	CITY OF TURLOCK	DRAWING NO. ST-20
CHECK BY: NBB	APPROVED BY:	COUNCIL APPROVAL
SCALE: NONE	CITY ENGINEER - MICHAEL G. PITCOCK - RCE 52694	DEC, 2015

### FIRE HYDRANT PAVEMENT MARKER LOCATION

TWO LANE STREET

MULTI LANE STREET

TWO LANE STREET AT INTERSECTION

FOUR LANE STREET WITH TURN LANE AT INTERSECTION

EXPRESSWAYS

MULTI-LANE STREET WITH TURN LANE

LEGEND

FH ◻ FIRE HYDRANT

■ BLUE PAVEMENT MARKER (TYPE BB)

### FIRE HYDRANT PAVEMENT MARKER LOCATION

DRAWN BY: JSH	CITY OF TURLOCK	DRAWING NO. W-3
CHECK BY: NBB	APPROVED BY:	COUNCIL APPROVAL
SCALE: NONE	CITY ENGINEER - MICHAEL G. PITCOCK - RCE 52694	DEC, 2015

### 3 STEP TRENCH REPAIR ~ STEP 1

2" COLD MIX, HOT MIX OR TEMPORARY STREET REPAIR MATERIAL

NATIVE MATERIAL COMPACTED TO 95%

UNDISTURBED MATERIAL

NOTES:

- COMPACTION TESTS SHALL BE APPROVED BY THE CITY BEFORE PAVING.
- TRENCHES 5 FEET OR MORE IN DEPTH SHALL BE SHORED.
- MAXIMUM LIFT THICKNESS FOR BEDDING AND BACKFILL SHALL BE 12" BEFORE COMPACTION.
- TRENCHES WHICH ARE LESS THAN 30" IN DEPTH OR LESS THAN 18" IN WIDTH SHALL BE BACKFILLED WITH TWO SACK CEMENT SLURRY.
- ALL STEPS OF TRENCHING SHALL BE REPEATED WHEN REPAIRING A SECTION OF PIPE.

### 3 STEP TRENCH REPAIR ~ STEP 1

DRAWN BY: JSH	CITY OF TURLOCK	DRAWING NO. T-1
CHECK BY: NBB	APPROVED BY:	COUNCIL APPROVAL
SCALE: NONE	INTERIM CITY ENGINEER - NATHAN B. BRAY - RCE 76642	FEB, 2019

### 3 STEP TRENCH REPAIR ~ STEP 2

HOT MIX ASPHALT 1" GREATER THAN EXISTING A.C. BUT NOT LESS THAN 5". FINAL LIFT SHALL BE 3"

6" AGGREGATE BASE, CLASS 2a

NATIVE MATERIAL COMPACTED TO 95%

UNDISTURBED MATERIAL

NOTES:

- STEP 1 MAY BE OMITTED IF STEP 2 IS PERFORMED SAME DAY AS TRENCH EXCAVATION
- COMPACTION TESTS SHALL BE APPROVED BY THE CITY BEFORE PAVING.
- TRENCHES 5 FEET OR MORE IN DEPTH SHALL BE SHORED.
- MAXIMUM LIFT THICKNESS FOR BEDDING AND BACKFILL SHALL BE 12" BEFORE COMPACTION.
- TRENCHES WHICH ARE LESS THAN 30" IN DEPTH OR LESS THAN 18" IN WIDTH SHALL BE BACKFILLED WITH TWO SACK CEMENT SLURRY.
- ALL STEPS OF TRENCHING SHALL BE REPEATED WHEN REPAIRING A SECTION OF PIPE.
- HMA SHALL BE PG 64-10, TYPE A

### 3 STEP TRENCH REPAIR ~ STEP 2

DRAWN BY: JSH	CITY OF TURLOCK	DRAWING NO. T-2
CHECK BY: NBB	APPROVED BY:	COUNCIL APPROVAL
SCALE: NONE	INTERIM CITY ENGINEER - NATHAN B. BRAY - RCE 76642	FEB, 2019

### 3 STEP TRENCH REPAIR ~ STEP 3

VARIES, SEE DWG T-4 AND T-5

GRIND AND PLACE 2" HOT MIX ASPHALT

6" AGGREGATE BASE, CLASS 2a

NATIVE MATERIAL COMPACTED TO 95%

UNDISTURBED MATERIAL

NOTES:

- COMPACTION TESTS SHALL BE APPROVED BY THE CITY BEFORE PAVING.
- TRENCHES 5 FEET OR MORE IN DEPTH SHALL BE SHORED.
- MAXIMUM LIFT THICKNESS FOR BEDDING AND BACKFILL SHALL BE 12" BEFORE COMPACTION.
- TRENCHES WHICH ARE LESS THAN 30" IN DEPTH OR LESS THAN 18" IN WIDTH SHALL BE BACKFILLED WITH TWO SACK CEMENT SLURRY.
- ALL STEPS OF TRENCHING SHALL BE REPEATED WHEN REPAIRING A SECTION OF PIPE.

### 3 STEP TRENCH REPAIR ~ STEP 3

DRAWN BY: JSH	CITY OF TURLOCK	DRAWING NO. T-3
CHECK BY: NBB	APPROVED BY:	COUNCIL APPROVAL
SCALE: NONE	INTERIM CITY ENGINEER - NATHAN B. BRAY - RCE 76642	FEB, 2019

### LONGITUDINAL TRENCH PATCH LIMITS

SIDEWALK

LANE LINE

STREET CENTER LINE

UTILITY LINE REPAIR

UTILITY LINE REPAIR

LANE LINE

SIDEWALK

TRENCH PAVING LIMITS

NOTES:

- GRINDING AND FINAL PAVING WIDTH SHALL BE TO THE EXTENT OF AFFECTED LANE LINES, 12" MIN.
- IF TRENCH CROSSES LANE LINES, GRINDING AND FINAL PAVING WIDTH SHALL BE TO THE EXTENT OF ALL AFFECTED LANE LINES FOR ENTIRE LENGTH OF TRENCH

### LONGITUDINAL TRENCH PATCH LIMITS

DRAWN BY: JSH	CITY OF TURLOCK	DRAWING NO. T-4
CHECK BY: NBB	APPROVED BY:	COUNCIL APPROVAL
SCALE: NONE	INTERIM CITY ENGINEER - NATHAN B. BRAY - RCE 76642	FEB, 2019

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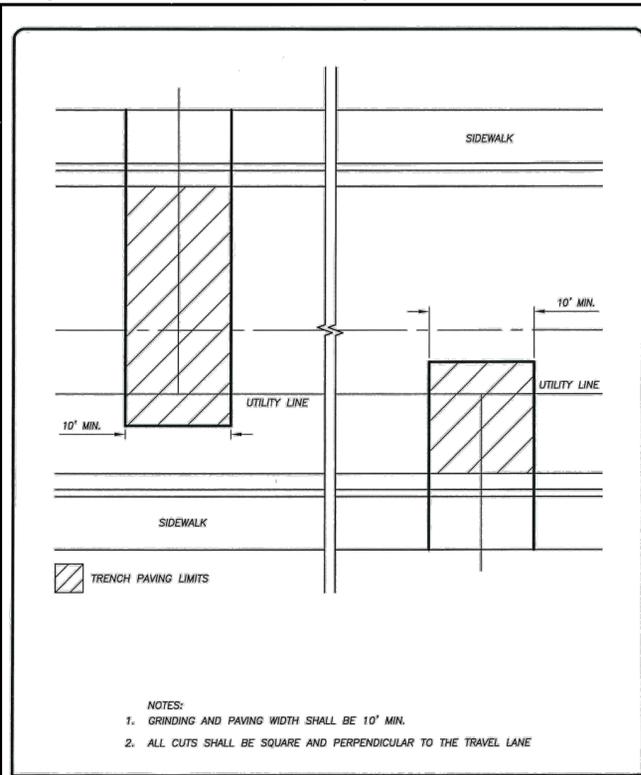
**BID SET**  
 1/22/2026

NO.	REVISION
BY	DATE


CITY OF TURLOCK  
 ROADS PROGRAM CIP  
 CITY PROJECT No. 23-068, PACKAGE 3  
 DETAILS  
 STANDARD DETAILS

DESIGN ENGINEER: JEFF DORN  
 LICENSE NO: 76,749  
 DRAFTED BY: AR      CHECKED BY: JD  
 DATE: JAN 2026  
 JOB NO: 229224001  
 PROJECT NO: 229224001  
 PHASE: 3  
 ORIGINAL SCALE SHOWN IS ONE INCH. ADJUST SCALE FOR REDUCED OR ENLARGED PLANS.  
 SHEET **D3**  
 27 OF 78


1/19/2026 9:11 AM G:\Turlock\_City of 229224001\2024 Road Rehab\300 CAD\341 Sheet Set\04\_Civil\_Details\03 STANDARD DETAILS.dwg -Ammare Fox




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CHECK BY: NBB		APPROVED BY: <i>[Signature]</i>		T-5
SCALE: NONE		INTERIM CITY ENGINEER - NATHAN B. BRAY - RCE 76642		COUNCIL APPROVAL FEB, 2019

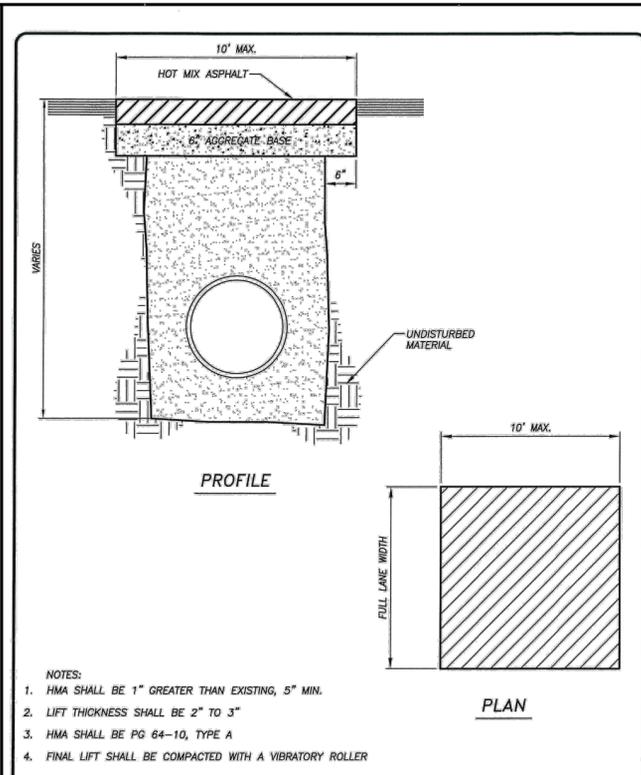


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SCALE: NONE		INTERIM CITY ENGINEER - NATHAN B. BRAY - RCE 76642		COUNCIL APPROVAL FEB, 2019

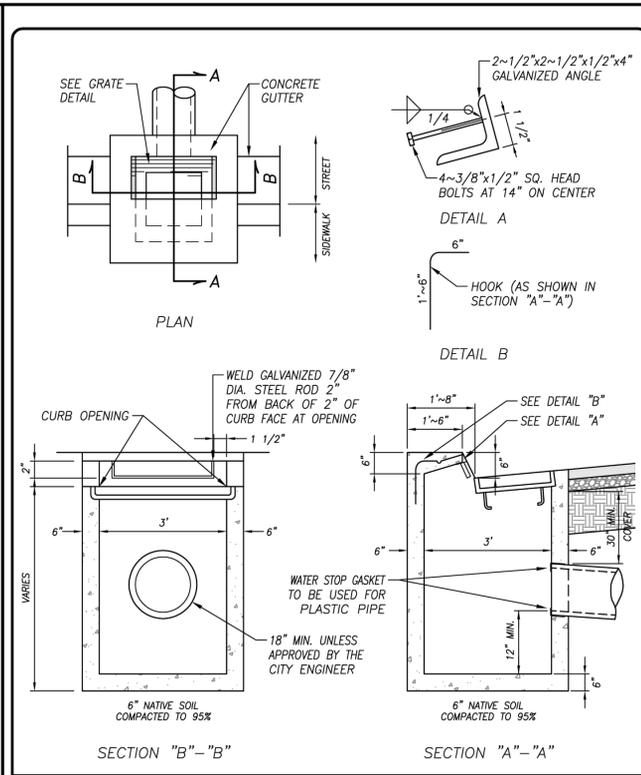


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CHECK BY: NBB		APPROVED BY: <i>[Signature]</i>		SD-3
SCALE: NONE		CITY ENGINEER - MICHAEL G. PITCOCK - RCE 52894		COUNCIL APPROVAL NOV., 2015

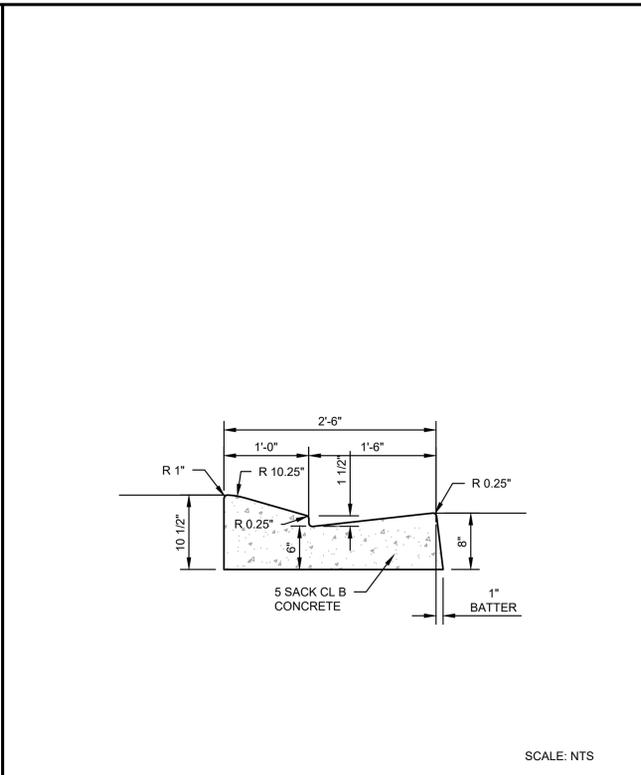


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SCALE: NONE		CITY ENGINEER - MICHAEL G. PITCOCK - RCE 52894		D4

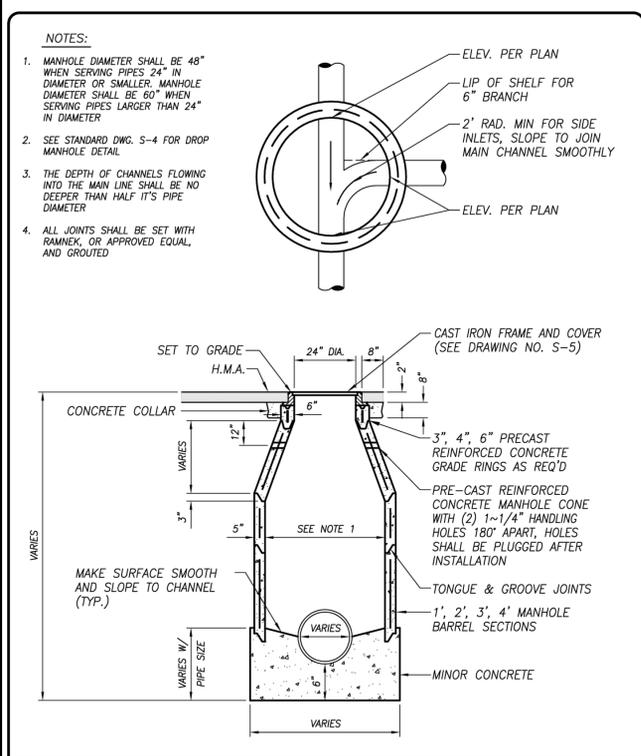


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SCALE: NONE		CITY ENGINEER - MICHAEL G. PITCOCK - RCE 52894		COUNCIL APPROVAL DEC, 2015

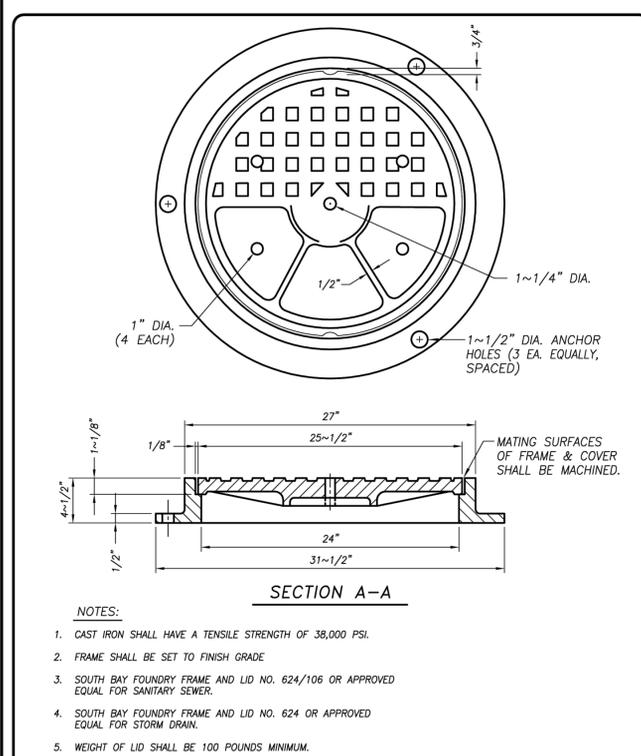

DRAWN BY: JSH		CITY OF TURLOCK		DRAWING NO.
CHECK BY: NBB		APPROVED BY: <i>[Signature]</i>		S-5
SCALE: NONE		CITY ENGINEER - MICHAEL G. PITCOCK - RCE 52894		COUNCIL APPROVAL DEC, 2015

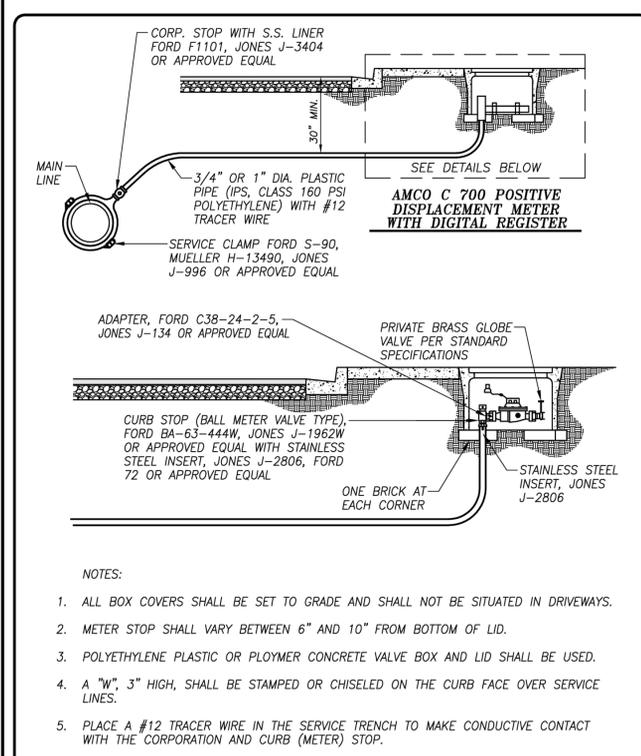

DRAWN BY: JSH		CITY OF TURLOCK		DRAWING NO.
CHECK BY: NBB		APPROVED BY: <i>[Signature]</i>		W-9
SCALE: NONE		CITY ENGINEER - MICHAEL G. PITCOCK - RCE 52894		COUNCIL APPROVAL DEC, 2015

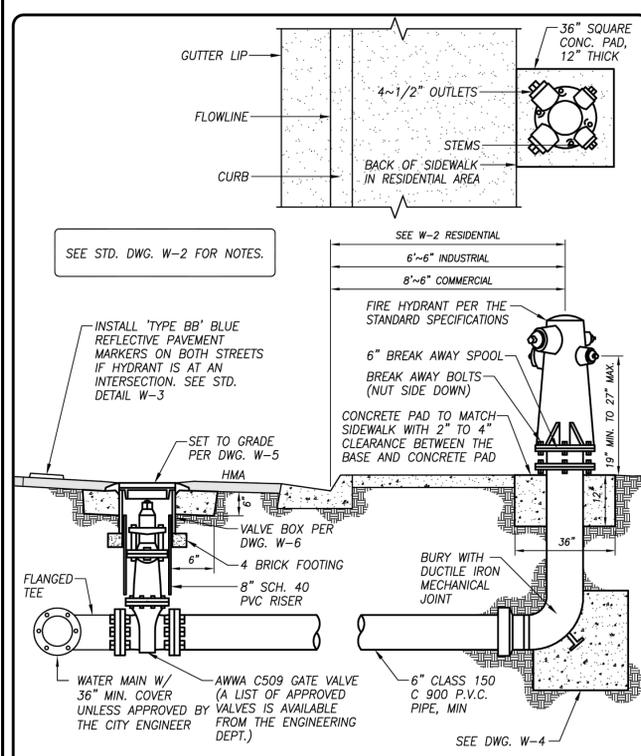

DRAWN BY: JSH		CITY OF TURLOCK		DRAWING NO.
CHECK BY: NBB		APPROVED BY: <i>[Signature]</i>		W-1
SCALE: NONE		CITY ENGINEER - MICHAEL G. PITCOCK - RCE 52894		COUNCIL APPROVAL DEC, 2015

**BID SET**  
1/22/2026

**CITY OF TURLOCK**  
ROADS PROGRAM CIP  
CITY PROJECT No. 25-068, PACKAGE 3  
DETAILS

**STANDARD DETAILS**

PROVOST & PRITCHARD  
425 W. FIFTH AVENUE  
SAN FRANCISCO, CA 94102  
PHONE (415) 449-2700  
FAX (415) 449-2715  
www.provostandpritchard.com


DESIGN ENGINEER: JEFF DORN  
LICENSE NO: 76,749  
CHECKED BY: JD  
DATE: JAN 2026  
JOB NO: 229224001  
PROJECT NO: 229224001  
PHASE: 3

ORIGINAL SCALE SHOWN IS ONE INCH. ADJUST SCALE FOR REDUCED OR ENLARGED PLANS.  
SHEET **D4** OF 78

DATE SIGNED: \_\_\_\_\_ BY: \_\_\_\_\_ REVISION: \_\_\_\_\_

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1/22/2026

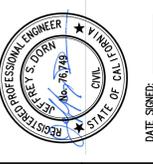


CITY OF TURLOCK  
ROADS PROGRAM CIP  
CITY PROJECT No. 23-068, PACKAGE 3  
DETAILS  
CIVIL DETAILS

**PROVOST & PRITCHARD**  
425 W. FIR AVENUE  
TURLOCK, CA 95259  
PHONE (559) 448-2700  
FAX (559) 448-2715  
www.provostandpritchard.com

DESIGN ENGINEER:  
JEFF DORN  
LICENSE NO:  
76,749  
DRAFTED BY: AR  
CHECKED BY: JD  
DATE: JAN 2026  
JOB NO: 229224001  
PROJECT NO: 229224001  
PHASE: 3  
ORIGINAL SCALE SHOWN IS ONE INCH. ADJUST SCALE FOR REDUCED OR ENLARGED PLANS.  
SHEET **D5**  
29 OF 78




CITY OF TURLOCK  
MUNICIPAL SERVICES DEPARTMENT  
ROADS PROGRAM DIVISION  
156 S. BROADWAY, SUITE 150  
(209) 668-5520

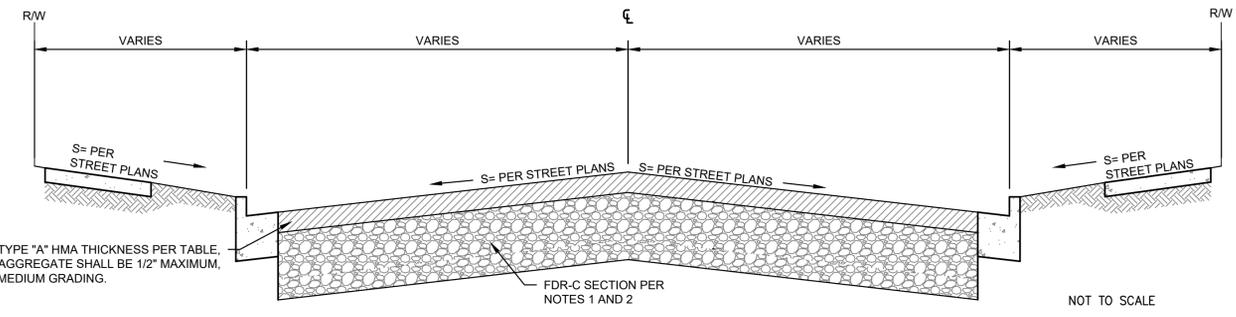

SOIL CEMENT PAVEMENT SECTION MINIMUMS			
TRAFFIC INDEX	PROPOSED LOCATIONS	FDR-C SECTION	
		HMA (INCHES)	FDR-C THICKNESS (INCHES)
8.0	MARSHALL ST	4.5	12
6.0	SYCAMORE ST	3.5	12
6.0	MERRITT ST	3.5	12
6.0	VILLA CT	3.5	12
6.0	ELENA CT	3.5	12
6.0	ANDREWS CT	3.5	12
6.0	FAIRVALE CT	3.5	12
6.0	BELL ST	3.5	12

- NOTES**
- AFTER GRINDING THE EXISTING AC PAVEMENT, PULVERIZE THE REMAINING MATERIAL AND GRADE TO RE-ESTABLISH THE GRADING PLANE. AFTER GRADING, UNIFORMLY MIX THE PULVERIZED MATERIAL WITH CEMENT AND COMPACT TO 95% RELATIVE COMPACTION TO ACHIEVE A LAYER OF FDR-C TREATED MATERIAL WITH THICKNESS AS SHOWN ON TABLE.
  - IF UNSTABLE SOIL CONDITIONS OCCUR, REPLACE UNSTABLE MATERIAL WITH 2' OF CLASS II AGGREGATE OR 18" OF FDR-C TREATED MATERIAL COMPACTED TO 95% RELATIVE COMPACTION.
  - PAVEMENT SECTIONS FOR INTERSECTIONS SHALL FOLLOW THE HIGHER TRAFFIC INDEX OF THE TWO STREETS INTERSECTING.
  - CONTRACTOR SHALL ADJUST SOIL CEMENT THICKNESS OVER SHALLOW UTILITIES TO MAINTAIN 12" OF CLEARANCE FROM GAS MAINS AND SERVICES AND 6" OF CLEARANCE FROM ALL OTHER UTILITY LINES.

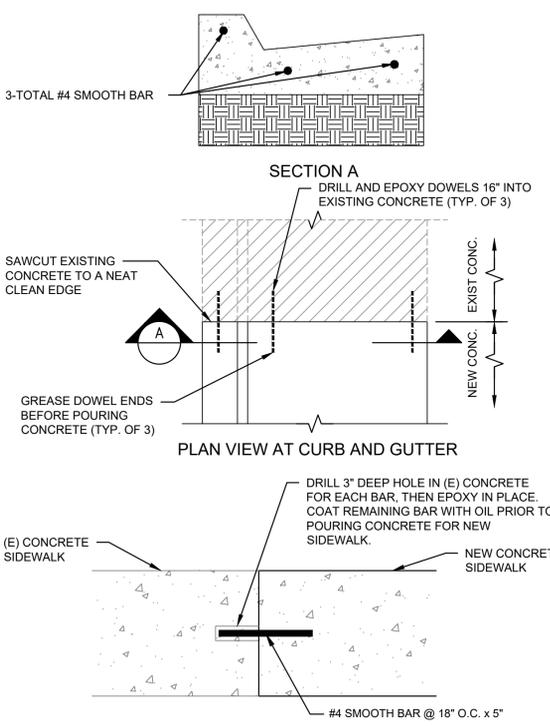


**DOWEL DETAILS**

2  
D5


**FDR-C RECONSTRUCTION**

**NOTES**


- PLACE CONSTRUCTION FUNDING SIGNS AS DIRECTED BY ENGINEER.

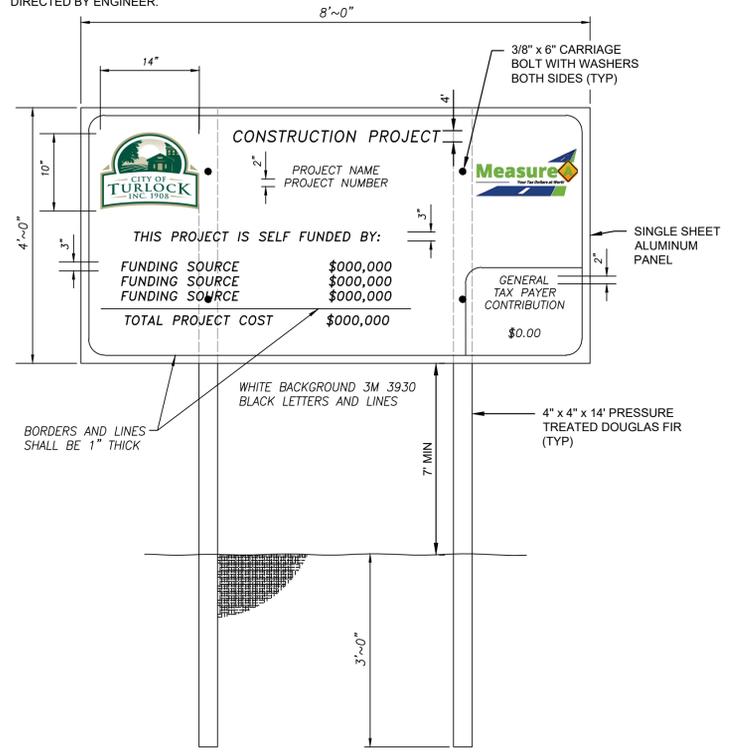

**CONSTRUCTION FUNDING SIGN**

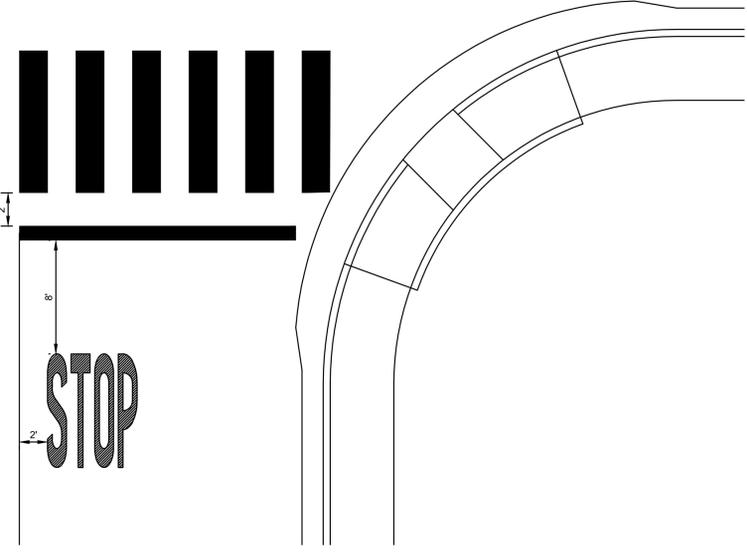

**DETAIL A**  
STOP BAR AND LEGEND DETAIL WITH CROSSWALK  
SCALE OF 1"=6'

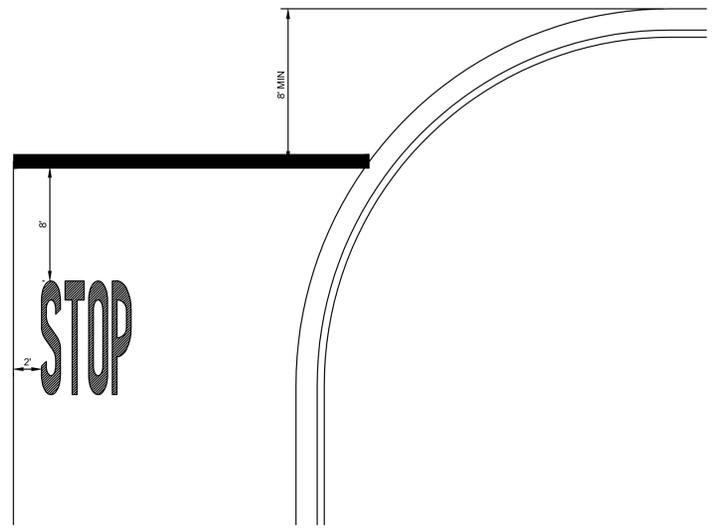

**DETAIL B**  
STOP BAR AND LEGEND DETAIL WITHOUT CURB RAMPS AND CROSSWALK  
SCALE OF 1"=6'


1  
D5

**LEGEND**

-  MINOR CONCRETE (CURB RAMP)
-  MINOR CONCRETE (ALLEY)
-  MINOR CONCRETE (C&G)
-  MINOR CONCRETE (SIDEWALK)
-  HMA CONFORM (ALLEY)
-  HMA (SAWCUT)


**NOTES**

1. FOR INFORMATION NOT SHOWN, SEE CITY OF TURLOCK STANDARD DRAWINGS ON SHEETS D1 AND D2
2. RETAINING CURBS REQUIRED TO CONSTRUCT CURB RAMPS ARE INCLUDED IN MINOR CONCRETE (CURB RAMP)

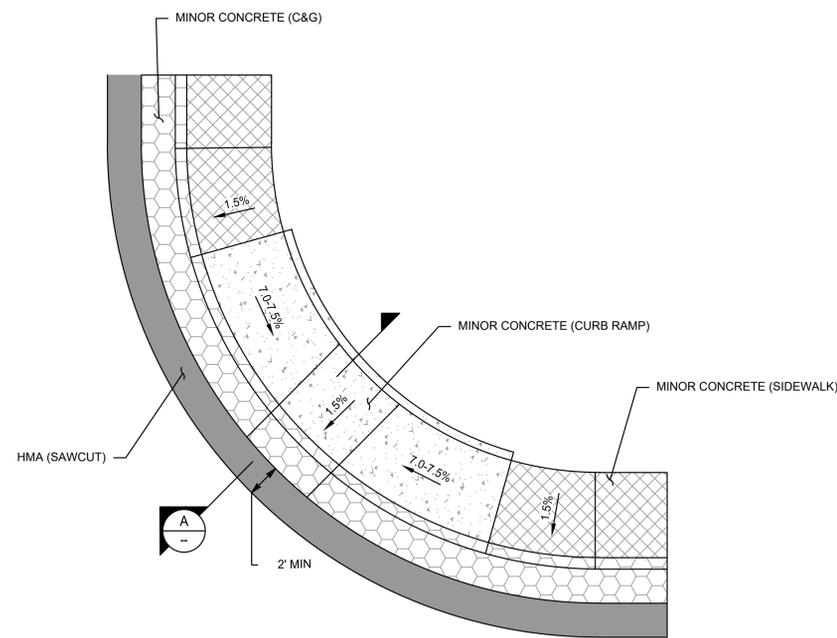


**CURB RAMP: TYPE C TYPICAL DETAIL**

SCALE: NTS

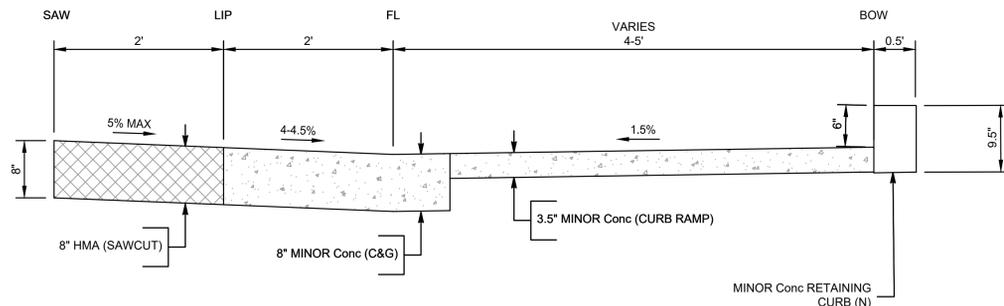


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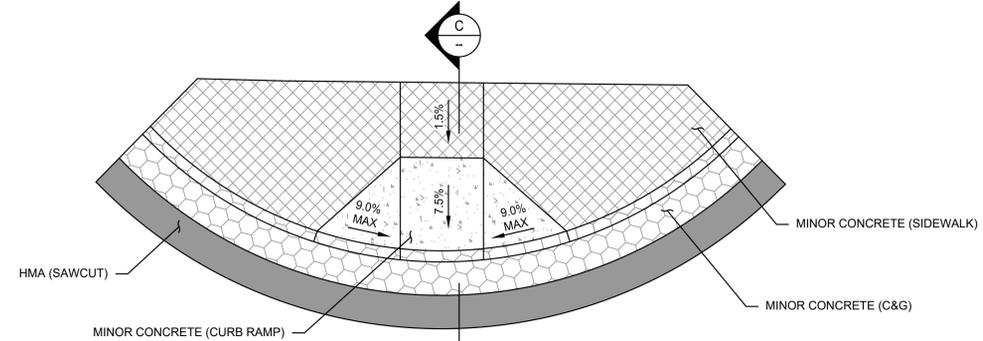
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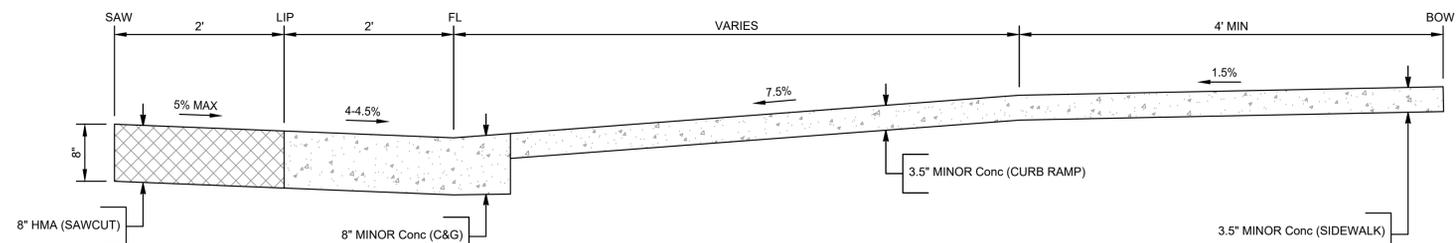
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**CURB RAMP: TYPE A TYPICAL DETAIL**

SCALE: NTS

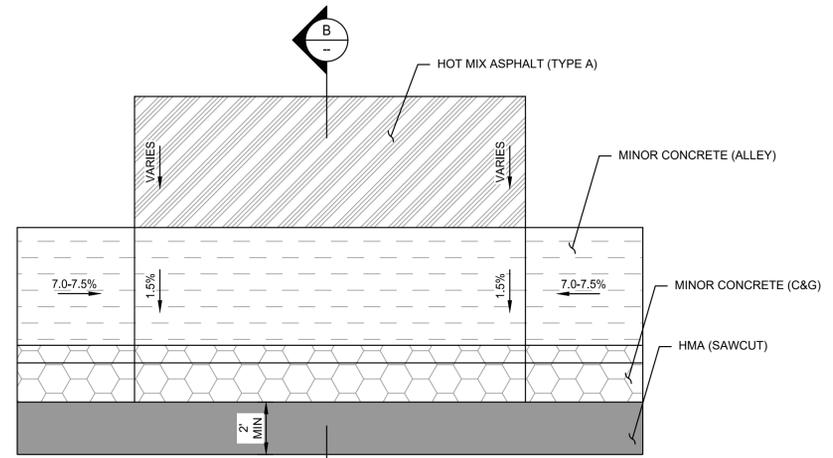

**SECTION C**


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1  
D6
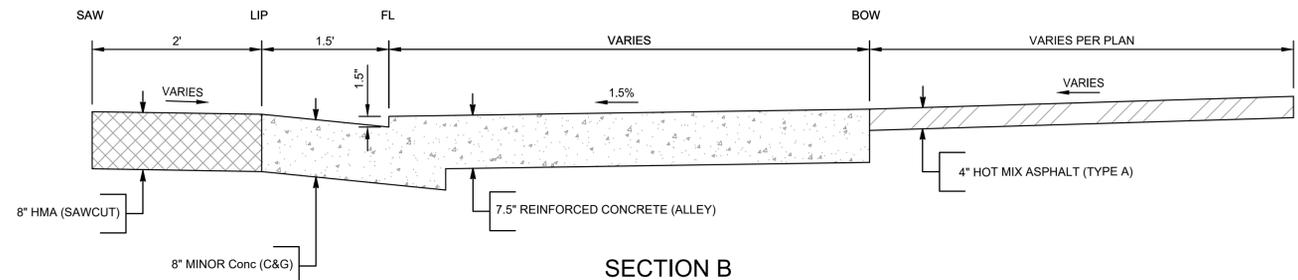
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**BID SET**  
 10/30/2025

REVISION  
 BY DATE



CITY OF TURLOCK  
 CONSTRUCTION PLANS FOR ROADS PROGRAM  
 CAPITAL IMPROVEMENT PROJECT  
 CITY PROJECT No. 23-068, PACKAGE 3  
 DETAILS  
 CIVIL DETAILS

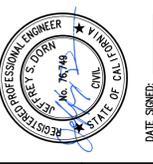**PROVOST & PRITCHARD**  
 425 W. FIR AVENUE  
 TURLOCK, CA 95259  
 PHONE (559) 449-2700  
 FAX (559) 449-2715  
 www.provostandpritchard.com

DESIGN ENGINEER:  
 JEFF DORN  
 LICENSE NO:  
 76,749

DRAFTED BY: AR  
 CHECKED BY: JD

DATE: JAN 2026  
 JOB NO: 229224001


PROJECT NO: 229224001

PHASE: 3


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 INCH. ADJUST SCALE FOR  
 REDUCED OR ENLARGED PLANS.

SHEET  
**D6**


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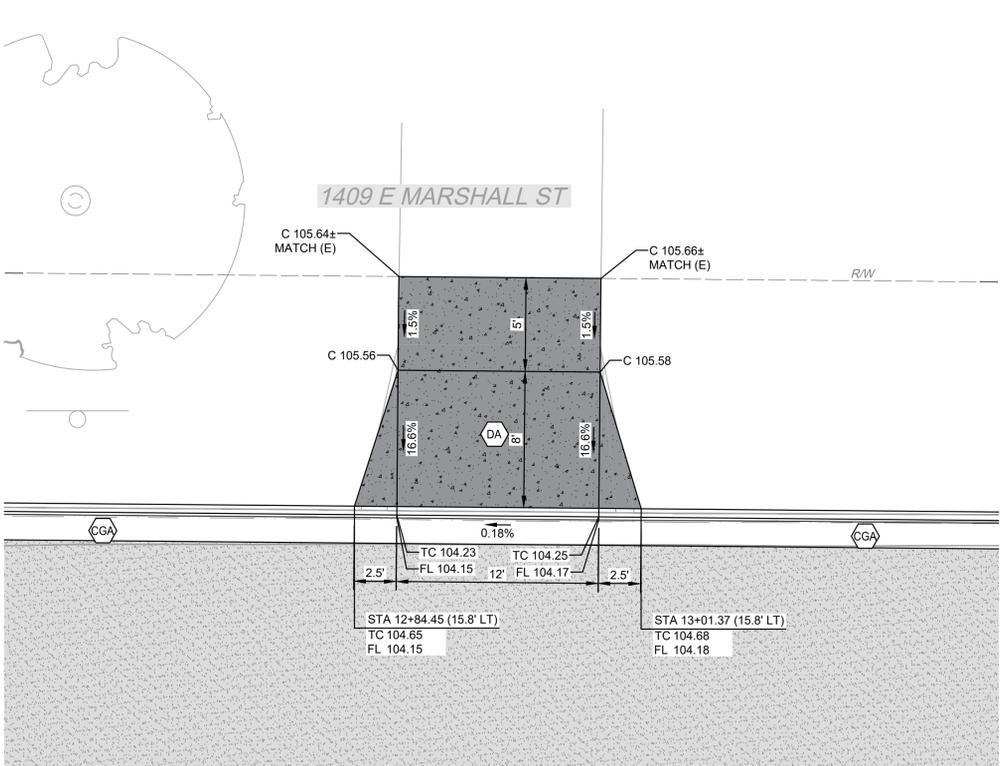
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NE CURB RAMP

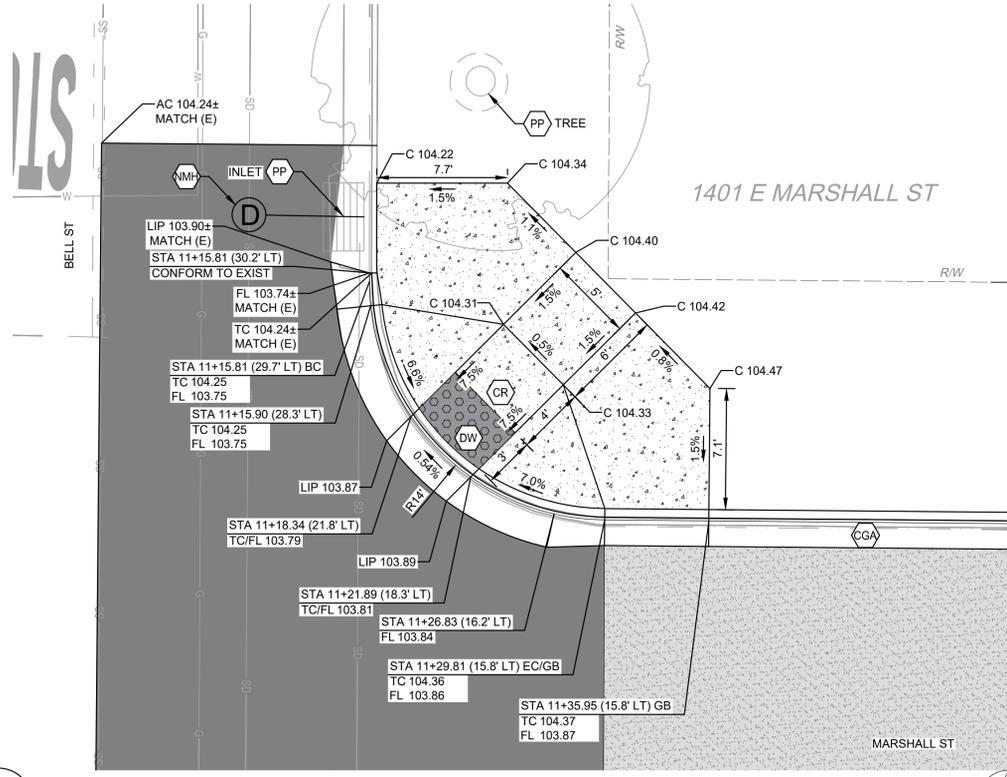


**MARSHALL ST & BELL ST**  
SE CURB RAMP

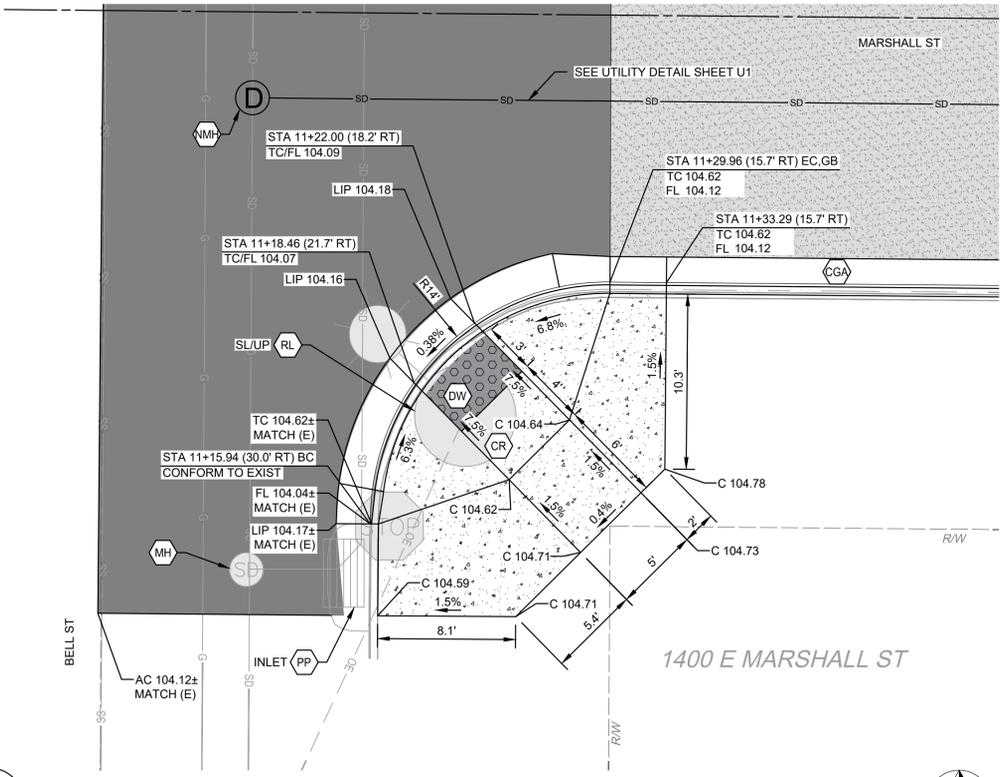

**MARSHALL ST**  
DRIVE APPROACH

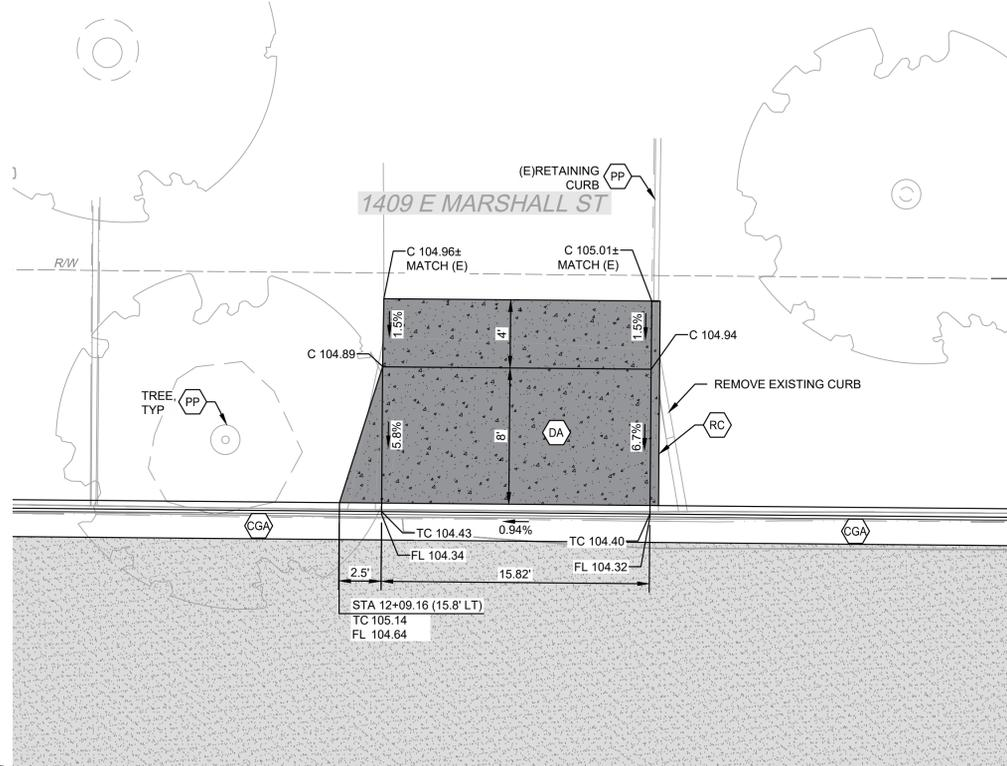

**MARSHALL ST**  
DRIVE APPROACH

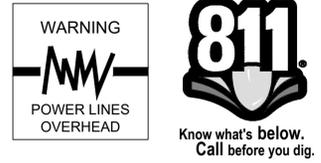

CONSTRUCTION CALLOUTS	
SYM	DESCRIPTION
AA	ALLEY APPROACH PER CITY OF TURLOCK STD DWG C-7
AG	ADJUST TO FINISHED GRADE
CGA	SAWCUT AND REMOVE (E) CURB AND GUTTER AND CONSTRUCT NEW CURB AND GUTTER PER CITY OF TURLOCK STD DWG C-1. DOWEL INTO EXISTING CURB AND GUTTER PER DETAIL 1, SHEET D5
CG	CONSTRUCT NEW CURB AND GUTTER PER CITY OF TURLOCK STD DWG C-1. DOWEL INTO EXISTING CURB AND GUTTER PER DETAIL 1, SHEET D5
CR	SAWCUT AND REMOVE (E) CURB RETURN, RAMPS, AND SIDEWALK AND CONSTRUCT NEW CURB RETURN, RAMP, AND SIDEWALK PER PROJECT SPECIFICATIONS AND SITE DETAILS
DA	RESIDENTIAL DRIVE APPROACH PER CITY OF TURLOCK STD DWG C-5
DA1	REMOVE AND REPLACE EXISTING DRIVE APPROACH TO MATCH AT EXISTING CONCRETE HINGE POINT PER CITY OF TURLOCK STD DWG C-5
DI	REMOVE AND REPLACE CATCH BASIN PER CITY OF TURLOCK STD SD-3 AND T-1
DOC	SAWCUT AND REMOVE (E) CURB AND GUTTER AND CONSTRUCT NEW DRIVE OVER CURB PER CITY OF TURLOCK PER DETAIL 3 ON SHEET D4. DOWEL INTO EXISTING CURB AND GUTTER PER DETAIL 1, SHEET D5
DW	DETECTABLE WARNING SURFACE PER CALTRANS STD DWG SHEET A88A
FH	CONSTRUCT FIRE HYDRANT PER CITY OF TURLOCK STD DWG W-1 AND T-1
MH	ADJUST MANHOLE TO FINISHED GRADE AFTER PAVING OPERATIONS PER DETAIL S-3
NDI	CONSTRUCT CATCH BASIN PER CITY OF TURLOCK STD SD-3 AND T-1
NMH	CONSTRUCT NEW MANHOLE PER CITY OF TURLOCK STD DWG S-3 AND T-1
PP	PROTECT IN PLACE
RC	RETAINING CURB
RD1	REMOVE DRAINAGE INLET
RL	REMOVE AND RELOCATE
SW	CONSTRUCT SIDEWALK PER CITY OF TURLOCK STD DWG C-3. PROVIDE 2' SIDEWALK TRANSITION WITHIN LIMITS SHOWN TO MATCH (E) ELEVATIONS. SLOPES WITHIN TRANSITION AREA SHALL NOT EXCEED 4.5% LONGITUDINALLY. DOWEL INTO EXISTING SIDEWALK PER DETAIL 1, SHEET D5. PROTECT (E) ROOF DRAINS IN PLACE OR REPLACE IN KIND
VG	CONSTRUCT VALLEY GUTTER PER CITY OF TURLOCK STD DWG C-1


**LEGEND**

- FDR-C RECONSTRUCTION PER DETAIL 2 SHEET D5
- 6.0" TYPE A HMA PAVEMENT PLUG OVER 6" CNS COMPACTED TO 95%
- 3.5" MINIMUM THICK CONCRETE OVER 6" CNS COMPACTED TO 90%
- ALLEY/DRIVE APPROACH CONCRETE THICKNESS PER CITY OF TURLOCK STD DWG C-5, C-7 & C-8
- 8.0" TYPE A HMA PAVEMENT OVER 6" CNS COMPACTED TO 95%

- CONSTRUCTION NOTES**
- EXISTING DRIVEWAYS, CURB, AND GUTTER TO REMAIN UNLESS OTHERWISE NOTED ON THE PLANS.
  - STATION AND OFFSET ON CURB AND GUTTER REFERS TO A POINT ON THE FLOWLINE.
  - DETAILED RAMP AND DRIVE APPROACH GRADING IS PROVIDED ON SHEETS D7-D22.
  - PROTECT IN PLACE ALL (E) SIDEWALK DRAINS.
  - NOT ALL SEWER LATERALS ARE SHOWN ON THE PLANS.

**BID SET**  
1/22/2026

NO.	REVISION	BY	DATE

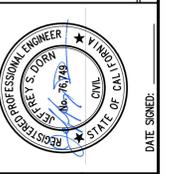


CITY OF TURLOCK  
ROADS PROGRAM CIP  
CITY PROJECT No. 23-068, PACKAGE 3  
DETAILS  
SITE DETAILS


**PROVOST & PRITCHARD**  
425 W. FIR AVENUE  
TURLOCK, CA 95259  
PHONE (559) 449-2700  
FAX (559) 449-2715  
www.provostandpritchard.com

DESIGN ENGINEER: JEFF DORN  
LICENSE NO: 76749

DRAFTED BY: AR	CHECKED BY: JD
DATE: JAN 2026	
JOB NO: 229224001	
PROJECT NO: 229224001	
PHASE: 3	
ORIGINAL SCALE SHOWN IS ONE INCH. ADJUST SCALE FOR REDUCED OR ENLARGED PLANS.	
SHEET <b>D7</b>	
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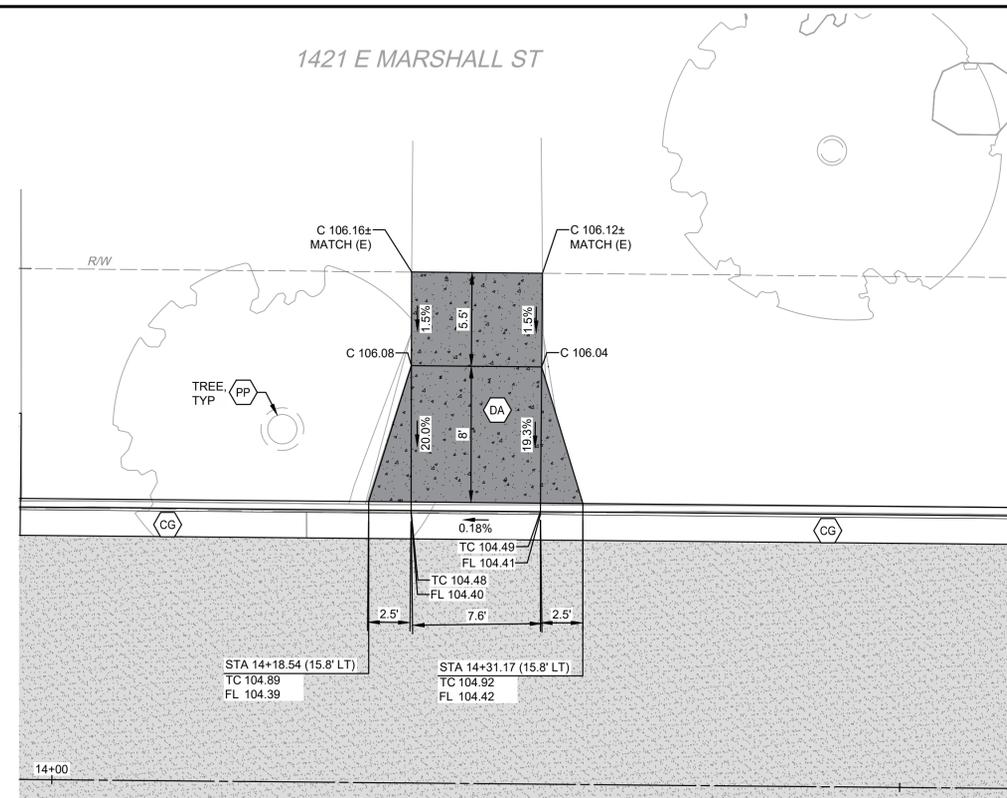

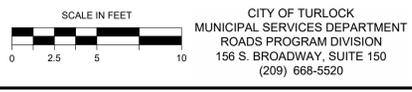
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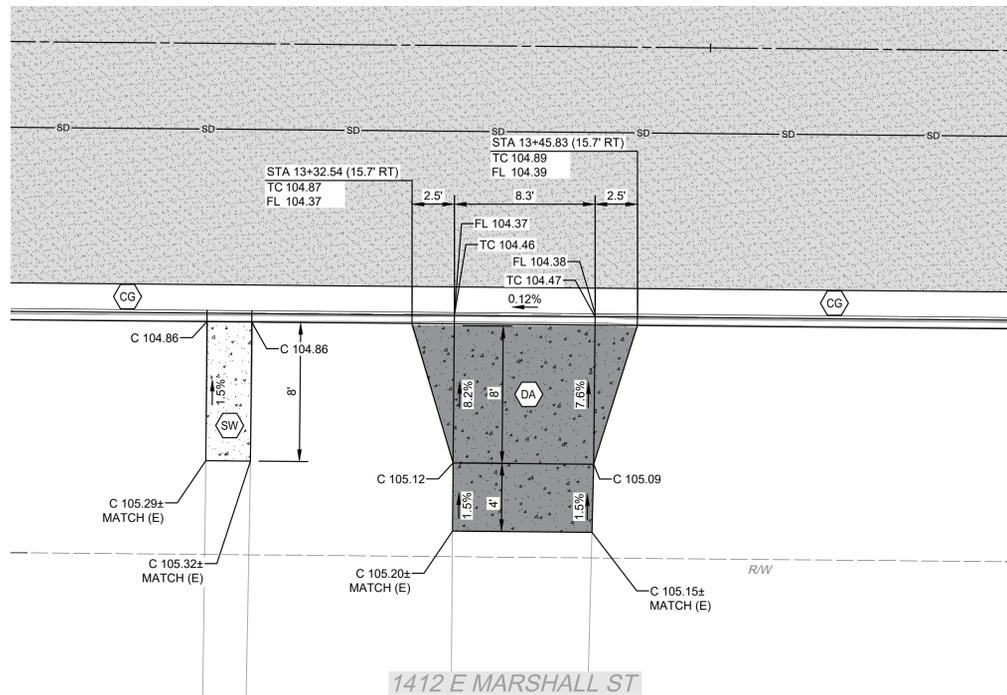
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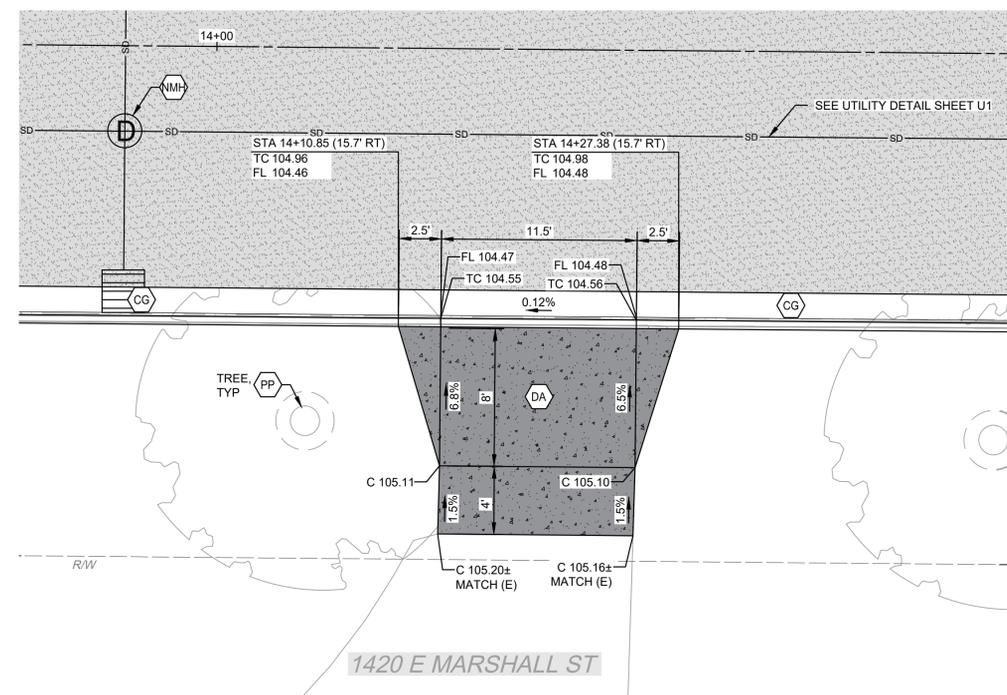
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MARSHALL ST  
DRIVE APPROACH

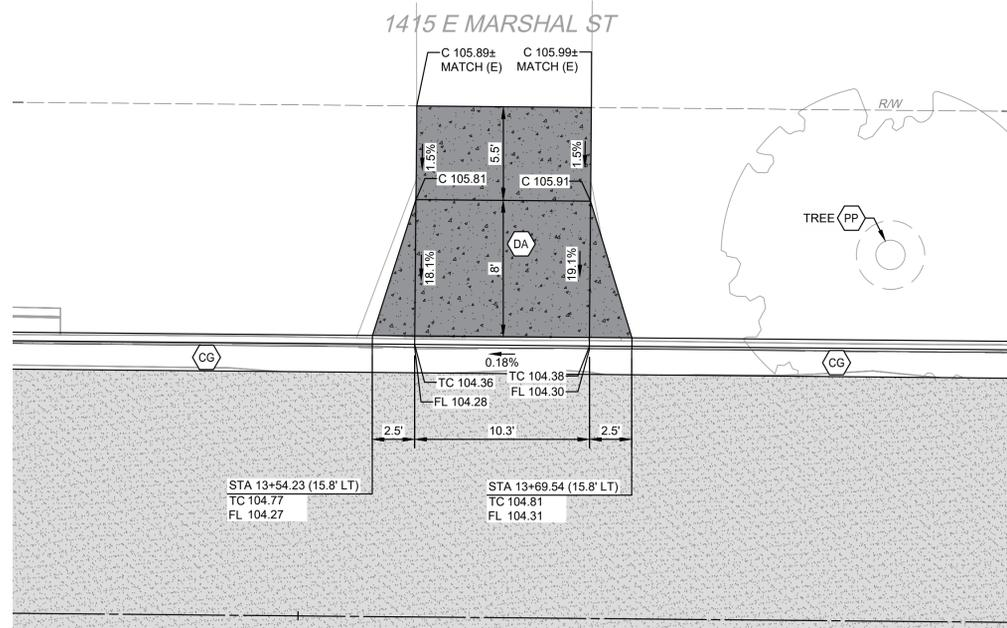

3  
D8


MARSHALL ST  
DRIVE APPROACH



4  
D8

MARSHALL ST  
DRIVE APPROACH

1421 E MARSHALL ST

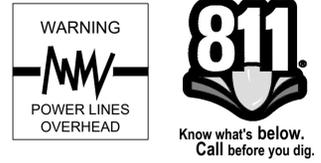

CONSTRUCTION CALLOUTS	
SYM	DESCRIPTION
AA	ALLEY APPROACH PER CITY OF TURLOCK STD DWG C-7
AG	ADJUST TO FINISHED GRADE
CGA	SAWCUT AND REMOVE (E) CURB AND GUTTER AND CONSTRUCT NEW CURB AND GUTTER PER CITY OF TURLOCK STD DWG C-1. DOWEL INTO EXISTING CURB AND GUTTER PER DETAIL 1, SHEET D5
CG	CONSTRUCT NEW CURB AND GUTTER PER CITY OF TURLOCK STD DWG C-1. DOWEL INTO EXISTING CURB AND GUTTER PER DETAIL 1, SHEET D5
CR	SAWCUT AND REMOVE (E) CURB RETURN, RAMPS, AND SIDEWALK AND CONSTRUCT NEW CURB RETURN, RAMP, AND SIDEWALK PER PROJECT SPECIFICATIONS AND SITE DETAILS
DA	RESIDENTIAL DRIVE APPROACH PER CITY OF TURLOCK STD DWG C-5
DA1	REMOVE AND REPLACE EXISTING DRIVE APPROACH TO MATCH AT EXISTING CONCRETE HINGE POINT PER CITY OF TURLOCK STD DWG C-5
DI	REMOVE AND REPLACE CATCH BASIN PER CITY OF TURLOCK STD SD-3 AND T-1
DOC	SAWCUT AND REMOVE (E) CURB AND GUTTER AND CONSTRUCT NEW DRIVE OVER CURB PER CITY OF TURLOCK PER DETAIL 3 ON SHEET D4. DOWEL INTO EXISTING CURB AND GUTTER PER DETAIL 1, SHEET D5
DW	DETECTABLE WARNING SURFACE PER CALTRANS STD DWG SHEET A88A
FH	CONSTRUCT FIRE HYDRANT PER CITY OF TURLOCK STD DWG W-1 AND T-1
MH	ADJUST MANHOLE TO FINISHED GRADE AFTER PAVING OPERATIONS PER DETAIL S-3
NDI	CONSTRUCT CATCH BASIN PER CITY OF TURLOCK STD SD-3 AND T-1
NMH	CONSTRUCT NEW MANHOLE PER CITY OF TURLOCK STD DWG S-3 AND T-1
PP	PROTECT IN PLACE
RC	RETAINING CURB
RD1	REMOVE DRAINAGE INLET
RL	REMOVE AND RELOCATE
SW	CONSTRUCT SIDEWALK PER CITY OF TURLOCK STD DWG C-3. PROVIDE 2' SIDEWALK TRANSITION WITHIN LIMITS SHOWN TO MATCH (E) ELEVATIONS. SLOPES WITHIN TRANSITION AREA SHALL NOT EXCEED 4.5% LONGITUDINALLY. DOWEL INTO EXISTING SIDEWALK PER DETAIL 1, SHEET D5. PROTECT (E) ROOF DRAINS IN PLACE OR REPLACE IN KIND
VG	CONSTRUCT VALLEY GUTTER PER CITY OF TURLOCK STD DWG C-1

LEGEND	
[Pattern]	FDR-C RECONSTRUCTION PER DETAIL 2 SHEET D5
[Pattern]	6.0" TYPE A HMA PAVEMENT PLUG OVER
[Pattern]	6" CNS COMPACTED TO 95%
[Pattern]	3.5" MINIMUM THICK CONCRETE OVER
[Pattern]	6" CNS COMPACTED TO 90%
[Pattern]	ALLEY/DRIVE APPROACH CONCRETE THICKNESS PER CITY OF TURLOCK STD DWG C-5, C-7 & C-8
[Pattern]	8.0" TYPE A HMA PAVEMENT OVER
[Pattern]	6" CNS COMPACTED TO 95%

- CONSTRUCTION NOTES**
- EXISTING DRIVEWAYS, CURB, AND GUTTER TO REMAIN UNLESS OTHERWISE NOTED ON THE PLANS.
  - STATION AND OFFSET ON CURB AND GUTTER REFERS TO A POINT ON THE FLOWLINE.
  - DETAILED RAMP AND DRIVE APPROACH GRADING IS PROVIDED ON SHEETS D7-D22.
  - PROTECT IN PLACE ALL (E) SIDEWALK DRAINS.
  - NOT ALL SEWER LATERALS ARE SHOWN ON THE PLANS.

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**BID SET**  
 1/22/2026

DATE SIGNED	BY	DATE
REVISION	BY	DATE

CITY OF TURLOCK  
 ROADS PROGRAM CIP  
 CITY PROJECT No. 23-068, PACKAGE 3  
 DETAILS  
 SITE DETAILS

**PROVOST & PRITCHARD**  
 425 W. F.R. AVENUE  
 CLOVIS, CA 95326  
 PHONE (559) 449-2700  
 FAX (559) 449-2715  
 www.provostandpritchard.com

DESIGN ENGINEER:  
 JEFF DORN  
 LICENSE NO:  
 76,749

DRAFTED BY: AR  
 CHECKED BY: JD  
 DATE: JAN 2026  
 JOB NO: 229224001  
 PROJECT NO: 229224001  
 PHASE: 3


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 SHEET **D8**  
 32 OF 78



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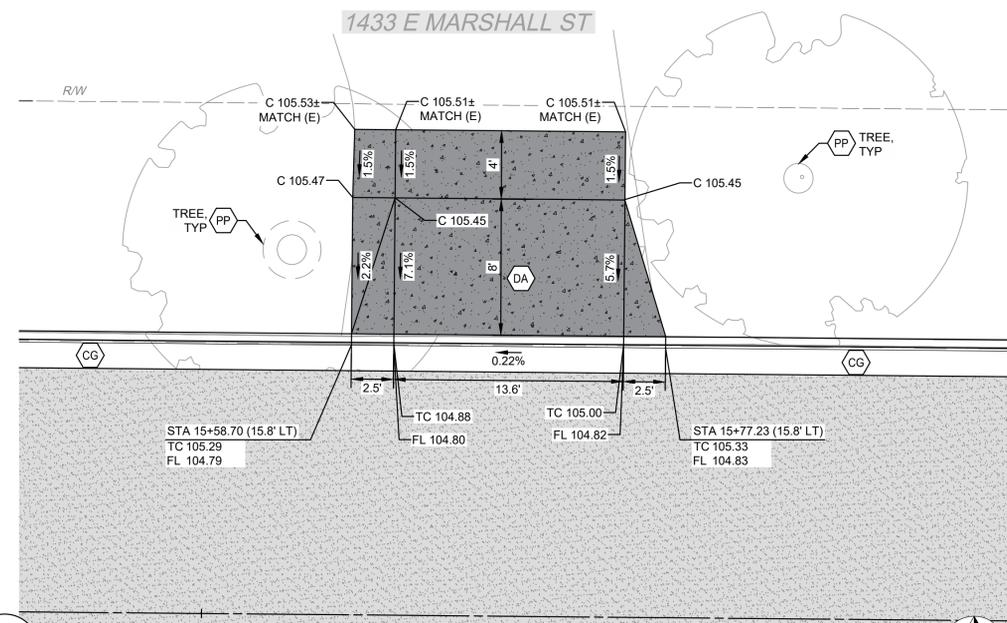
CITY OF TURLOCK  
 MUNICIPAL SERVICES DEPARTMENT  
 ROADS PROGRAM DIVISION  
 156 S. BROADWAY, SUITE 150  
 (209) 668-5520



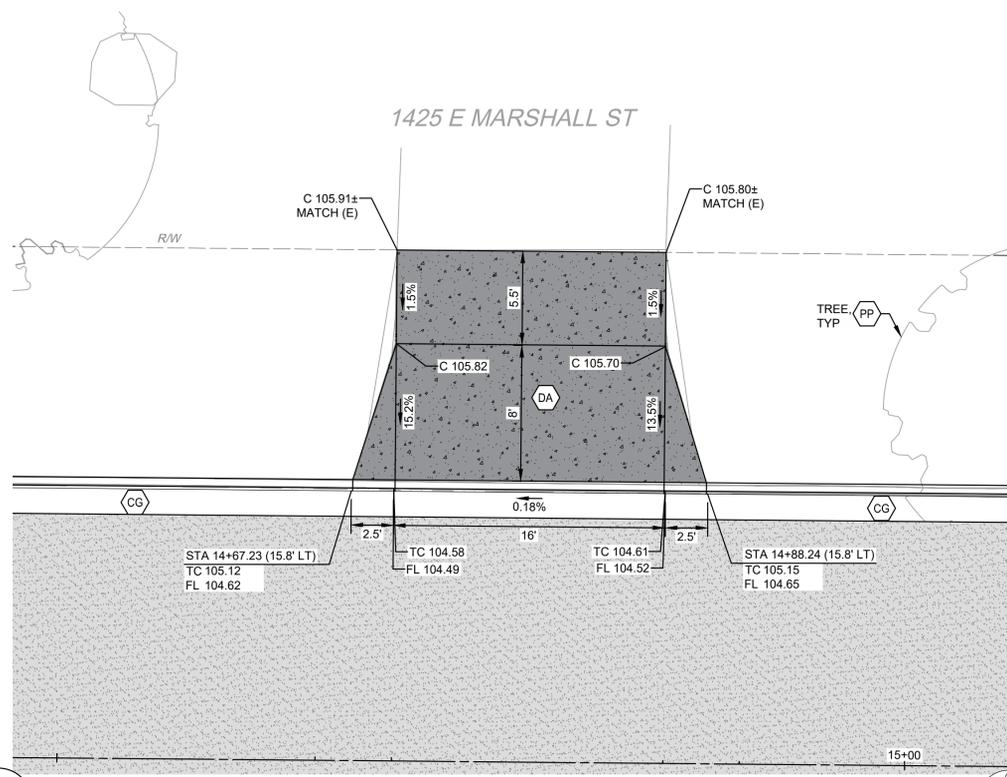


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DRIVE APPROACH

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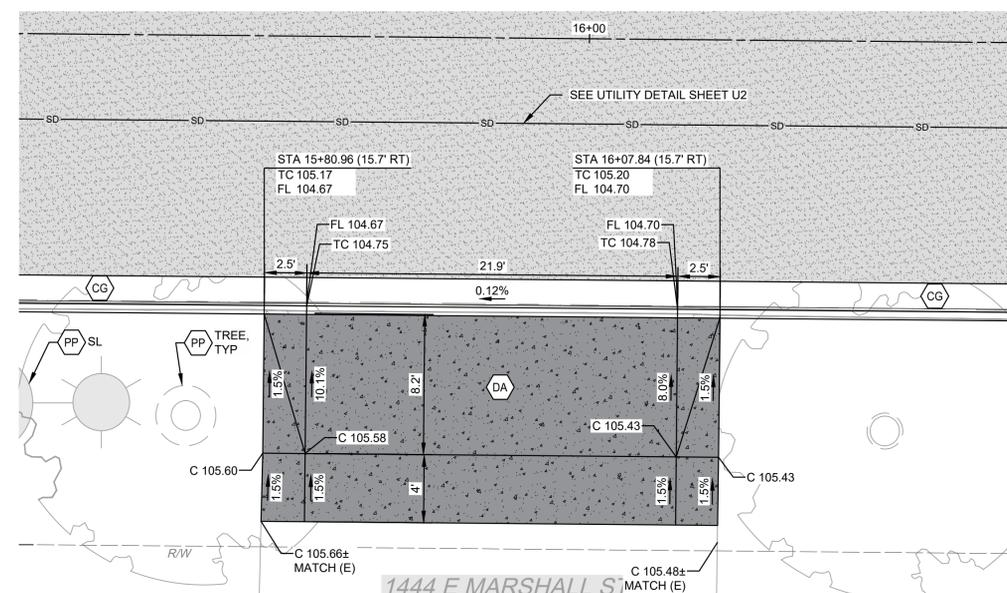
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DRIVE APPROACH

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D9




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DRIVE APPROACH'S

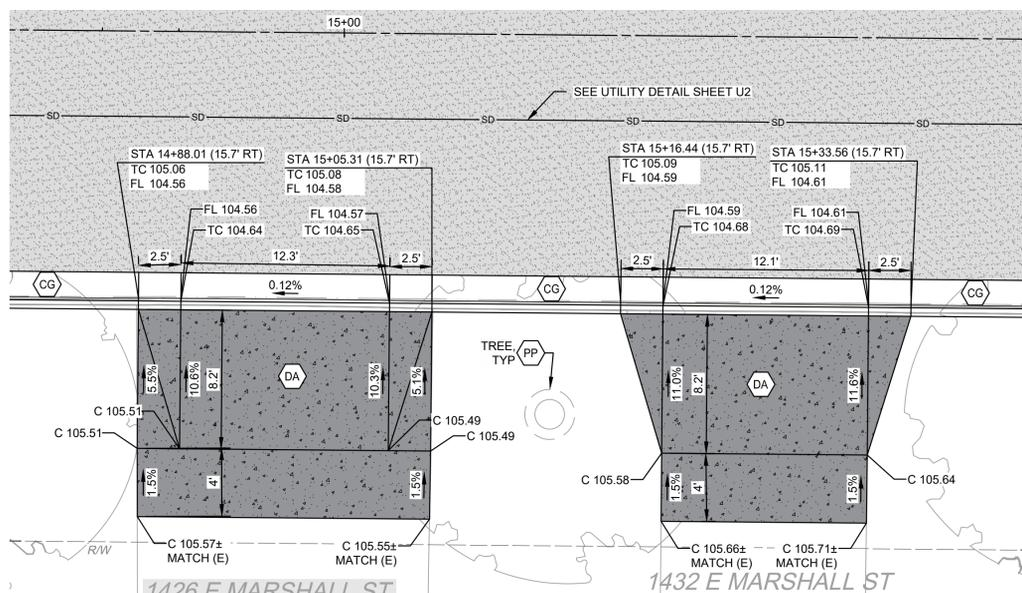3  
D9



**MARSHALL ST**  
DRIVE APPROACH

4  
D9

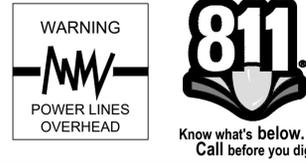


CONSTRUCTION CALLOUTS	
SYM	DESCRIPTION
AA	ALLEY APPROACH PER CITY OF TURLOCK STD DWG C-7
AG	ADJUST TO FINISHED GRADE
CGA	SAWCUT AND REMOVE (E) CURB AND GUTTER AND CONSTRUCT NEW CURB AND GUTTER PER CITY OF TURLOCK STD DWG C-1. DOWEL INTO EXISTING CURB AND GUTTER PER DETAIL 1, SHEET D5
CG	CONSTRUCT NEW CURB AND GUTTER PER CITY OF TURLOCK STD DWG C-1. DOWEL INTO EXISTING CURB AND GUTTER PER DETAIL 1, SHEET D5
CR	SAWCUT AND REMOVE (E) CURB RETURN, RAMPS, AND SIDEWALK AND CONSTRUCT NEW CURB RETURN, RAMP, AND SIDEWALK PER PROJECT SPECIFICATIONS AND SITE DETAILS
DA	RESIDENTIAL DRIVE APPROACH PER CITY OF TURLOCK STD DWG C-5
DA1	REMOVE AND REPLACE EXISTING DRIVE APPROACH TO MATCH AT EXISTING CONCRETE HINGE POINT PER CITY OF TURLOCK STD DWG C-5
DI	REMOVE AND REPLACE CATCH BASIN PER CITY OF TURLOCK STD SD-3 AND T-1
DOC	SAWCUT AND REMOVE (E) CURB AND GUTTER AND CONSTRUCT NEW DRIVE OVER CURB PER CITY OF TURLOCK PER DETAIL 3 ON SHEET D4. DOWEL INTO EXISTING CURB AND GUTTER PER DETAIL 1, SHEET D5
DW	DETECTABLE WARNING SURFACE PER CALTRANS STD DWG SHEET A88A
FH	CONSTRUCT FIRE HYDRANT PER CITY OF TURLOCK STD DWG W-1 AND T-1
MH	ADJUST MANHOLE TO FINISHED GRADE AFTER PAVING OPERATIONS PER DETAIL S-3
ND	CONSTRUCT CATCH BASIN PER CITY OF TURLOCK STD SD-3 AND T-1
NMH	CONSTRUCT NEW MANHOLE PER CITY OF TURLOCK STD DWG S-3 AND T-1
PP	PROTECT IN PLACE
RC	RETAINING CURB
RD	REMOVE DRAINAGE INLET
RL	REMOVE AND RELOCATE
SW	CONSTRUCT SIDEWALK PER CITY OF TURLOCK STD DWG C-3. PROVIDE 2' SIDEWALK TRANSITION WITHIN LIMITS SHOWN TO MATCH (E) ELEVATIONS. SLOPES WITHIN TRANSITION AREA SHALL NOT EXCEED 4.5% LONGITUDINALLY. DOWEL INTO EXISTING SIDEWALK PER DETAIL 1, SHEET D5. PROTECT (E) ROOF DRAINS IN PLACE OR REPLACE IN KIND
VG	CONSTRUCT VALLEY GUTTER PER CITY OF TURLOCK STD DWG C-1

**LEGEND**

- FDR-C RECONSTRUCTION PER DETAIL 2 SHEET D5
- 6.0" TYPE A HMA PAVEMENT PLUG OVER
- 6" CNS COMPACTED TO 95%
- 3.5" MINIMUM THICK CONCRETE OVER
- 6" CNS COMPACTED TO 90%
- ALLEY/DRIVE APPROACH CONCRETE THICKNESS PER CITY OF TURLOCK STD DWG C-5, C-7 & C-8
- 8.0" TYPE A HMA PAVEMENT OVER
- 6" CNS COMPACTED TO 95%

- CONSTRUCTION NOTES**
- EXISTING DRIVEWAYS, CURB, AND GUTTER TO REMAIN UNLESS OTHERWISE NOTED ON THE PLANS.
  - STATION AND OFFSET ON CURB AND GUTTER REFERS TO A POINT ON THE FLOWLINE.
  - DETAILED RAMP AND DRIVE APPROACH GRADING IS PROVIDED ON SHEETS D7-D22.
  - PROTECT IN PLACE ALL (E) SIDEWALK DRAINS.
  - NOT ALL SEWER LATERALS ARE SHOWN ON THE PLANS.

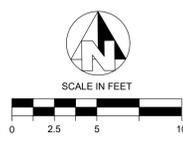

CITY OF TURLOCK  
MUNICIPAL SERVICES DEPARTMENT  
ROADS PROGRAM DIVISION  
156 S. BROADWAY, SUITE 150  
(209) 668-5520

**BID SET**  
1/22/2026

**CITY OF TURLOCK**  
ROADS PROGRAM CIP  
CITY PROJECT No. 23-068, PACKAGE 3  
DETAILS

**SITE DETAILS**

DESIGN ENGINEER:  
JEFF DORN  
LICENSE NO:  
76,749

DRAFTED BY: AR  
CHECKED BY: JD

DATE: JAN 2026  
JOB NO: 229224001  
PROJECT NO: 229224001  
PHASE: 3

ORIGINAL SCALE SHOWN IS ONE INCH. ADJUST SCALE FOR REDUCED OR ENLARGED PLANS.


SHEET **D9**  
33 OF 78

PROVOST & PRITCHARD  
425 W. FIR AVENUE  
TURLOCK, CA 95259  
PHONE (559) 449-2700  
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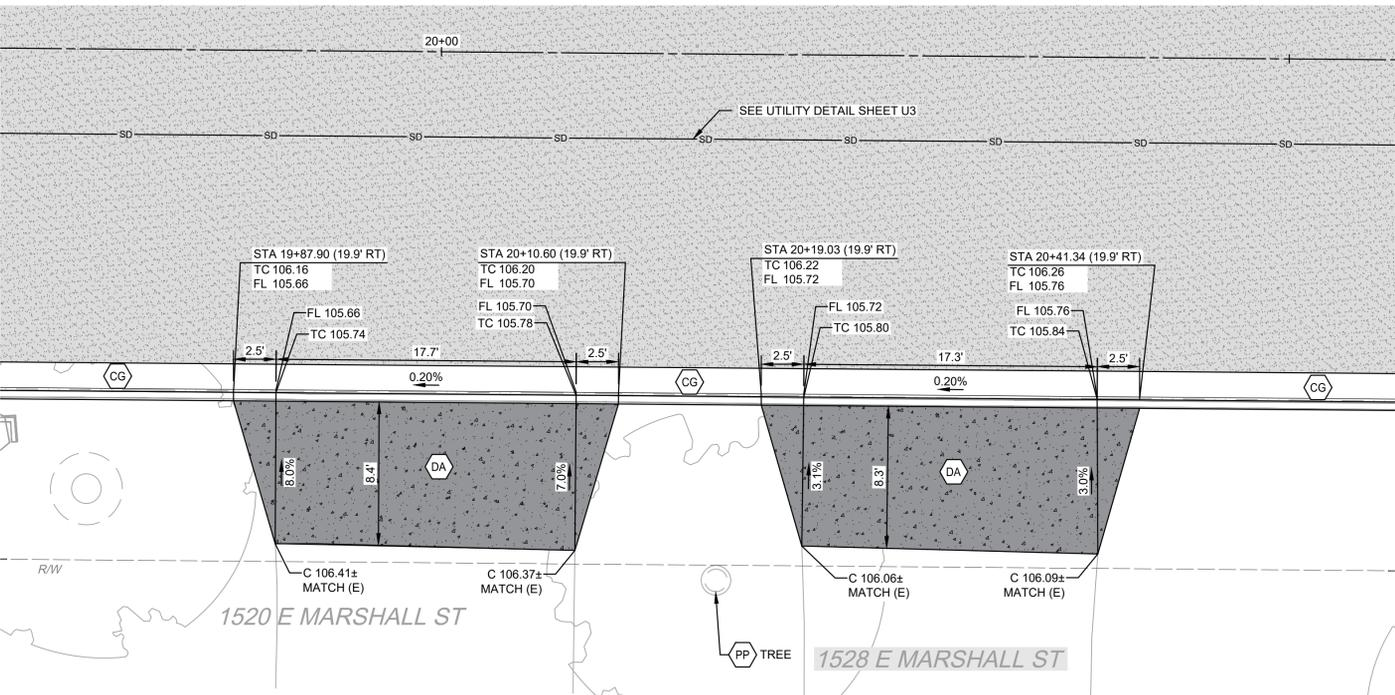
DATE SIGNED: \_\_\_\_\_  
BY: \_\_\_\_\_  
REVISION: \_\_\_\_\_

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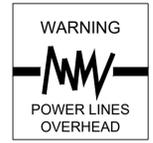
**MARSHALL ST**  
DRIVE APPROACH



**MARSHALL ST**  
DRIVE APPROACH

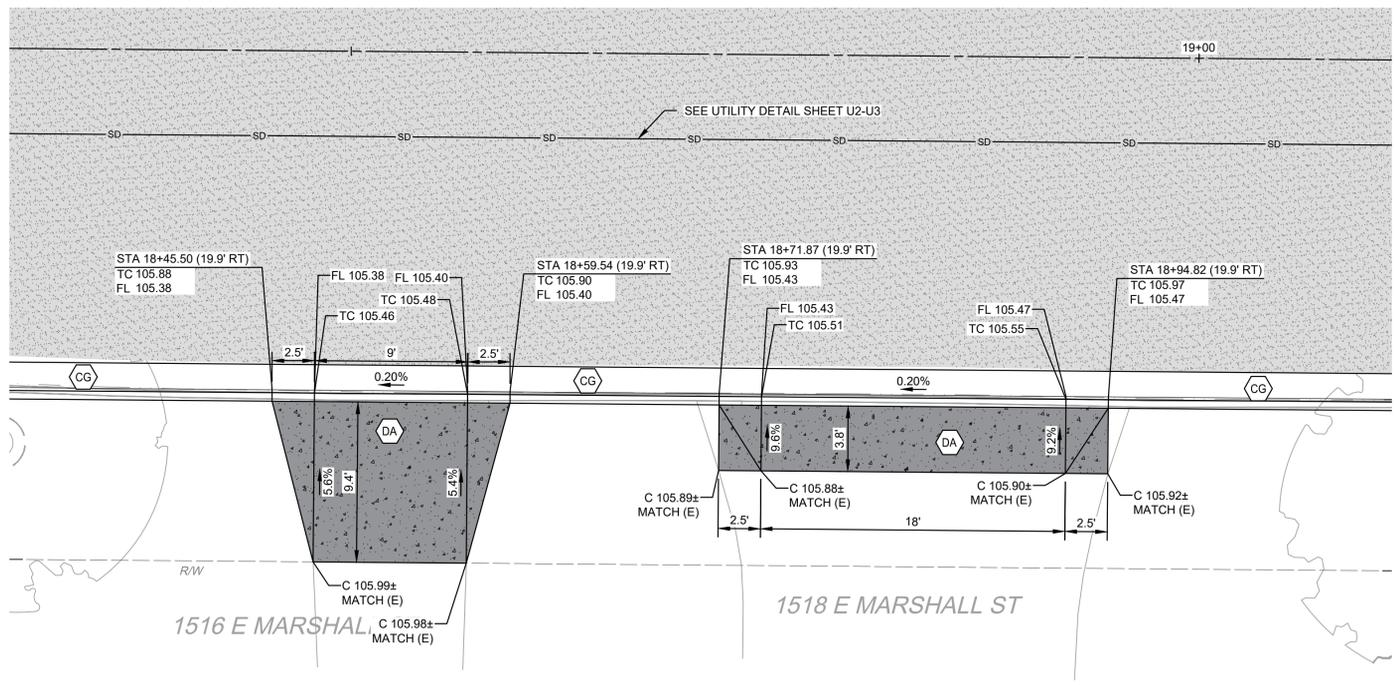1  
D11

2  
D11




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CONSTRUCTION CALLOUTS	
SYM	DESCRIPTION
AA	ALLEY APPROACH PER CITY OF TURLOCK STD DWG C-7
AG	ADJUST TO FINISHED GRADE
CGA	SAWCUT AND REMOVE (E) CURB AND GUTTER AND CONSTRUCT NEW CURB AND GUTTER PER CITY OF TURLOCK STD DWG C-1. DOWEL INTO EXISTING CURB AND GUTTER PER DETAIL 1, SHEET D5
CG	CONSTRUCT NEW CURB AND GUTTER PER CITY OF TURLOCK STD DWG C-1. DOWEL INTO EXISTING CURB AND GUTTER PER DETAIL 1, SHEET D5
CR	SAWCUT AND REMOVE (E) CURB RETURN, RAMPS, AND SIDEWALK AND CONSTRUCT NEW CURB RETURN, RAMP, AND SIDEWALK PER PROJECT SPECIFICATIONS AND SITE DETAILS
DA	RESIDENTIAL DRIVE APPROACH PER CITY OF TURLOCK STD DWG C-5
DA1	REMOVE AND REPLACE EXISTING DRIVE APPROACH TO MATCH AT EXISTING CONCRETE HINGE POINT PER CITY OF TURLOCK STD DWG C-5
DI	REMOVE AND REPLACE CATCH BASIN PER CITY OF TURLOCK STD SD-3 AND T-1
DOC	SAWCUT AND REMOVE (E) CURB AND GUTTER AND CONSTRUCT NEW DRIVE OVER CURB PER CITY OF TURLOCK PER DETAIL 3 ON SHEET D4. DOWEL INTO EXISTING CURB AND GUTTER PER DETAIL 1, SHEET D5
DW	DETECTABLE WARNING SURFACE PER CALTRANS STD DWG SHEET A88A
FH	CONSTRUCT FIRE HYDRANT PER CITY OF TURLOCK STD DWG W-1 AND T-1
MH	ADJUST MANHOLE TO FINISHED GRADE AFTER PAVING OPERATIONS PER DETAIL S-3
NDI	CONSTRUCT CATCH BASIN PER CITY OF TURLOCK STD SD-3 AND T-1
NMH	CONSTRUCT NEW MANHOLE PER CITY OF TURLOCK STD DWG S-3 AND T-1
PP	PROTECT IN PLACE
RC	RETAINING CURB
RD	REMOVE DRAINAGE INLET
RL	REMOVE AND RELOCATE
SW	CONSTRUCT SIDEWALK PER CITY OF TURLOCK STD DWG C-3. PROVIDE 2' SIDEWALK TRANSITION WITHIN LIMITS SHOWN TO MATCH (E) ELEVATIONS. SLOPES WITHIN TRANSITION AREA SHALL NOT EXCEED 4.5% LONGITUDINALLY. DOWEL INTO EXISTING SIDEWALK PER DETAIL 1, SHEET D5. PROTECT (E) ROOF DRAINS IN PLACE OR REPLACE IN KIND
VG	CONSTRUCT VALLEY GUTTER PER CITY OF TURLOCK STD DWG C-1

LEGEND	
	FDR-C RECONSTRUCTION PER DETAIL 2 SHEET D5
	6.0" TYPE A HMA PAVEMENT PLUG OVER
	6" CNS COMPACTED TO 95%
	3.5" MINIMUM THICK CONCRETE OVER
	6" CNS COMPACTED TO 90%
	ALLEY/DRIVE APPROACH CONCRETE THICKNESS PER CITY OF TURLOCK STD DWG C-5, C-7 & C-8
	8.0" TYPE A HMA PAVEMENT OVER
	6" CNS COMPACTED TO 95%

- CONSTRUCTION NOTES**
- EXISTING DRIVEWAYS, CURB, AND GUTTER TO REMAIN UNLESS OTHERWISE NOTED ON THE PLANS.
  - STATION AND OFFSET ON CURB AND GUTTER REFERS TO A POINT ON THE FLOWLINE.
  - DETAILED RAMP AND DRIVE APPROACH GRADING IS PROVIDED ON SHEETS D7-D22.
  - PROTECT IN PLACE ALL (E) SIDEWALK DRAINS.
  - NOT ALL SEWER LATERALS ARE SHOWN ON THE PLANS.

BID SET  
1/22/2026

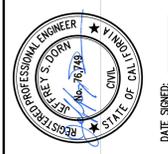

CITY OF TURLOCK  
ROADS PROGRAM CIP  
CITY PROJECT No. 23-068, PACKAGE 3  
DETAILS  
SITE DETAILS

**PROVOST & PRITCHARD**  
425 W. FIR AVENUE  
TURLOCK, CA 95259  
PHONE (559) 449-2700  
FAX (559) 449-2719  
www.provostandpritchard.com

DESIGN ENGINEER:  
JEFF DORN  
LICENSE NO:  
76,749


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CHECKED BY: JD

DATE: JAN 2026  
JOB NO: 229224001

PROJECT NO: 229224001  
PHASE: 3

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ORIGINAL SCALE SHOWN IS ONE INCH. ADJUST SCALE FOR REDUCED OR ENLARGED PLANS.


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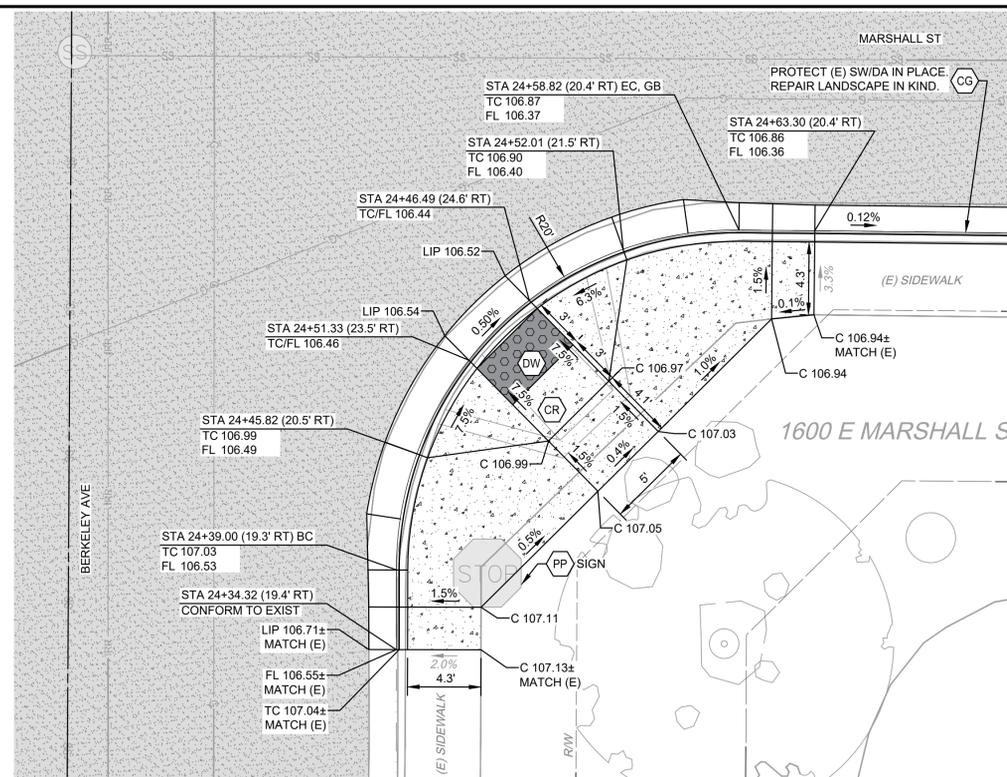
CITY OF TURLOCK  
MUNICIPAL SERVICES DEPARTMENT  
ROADS PROGRAM DIVISION  
156 S. BROADWAY, SUITE 150  
(209) 668-5520
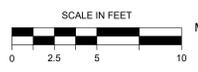
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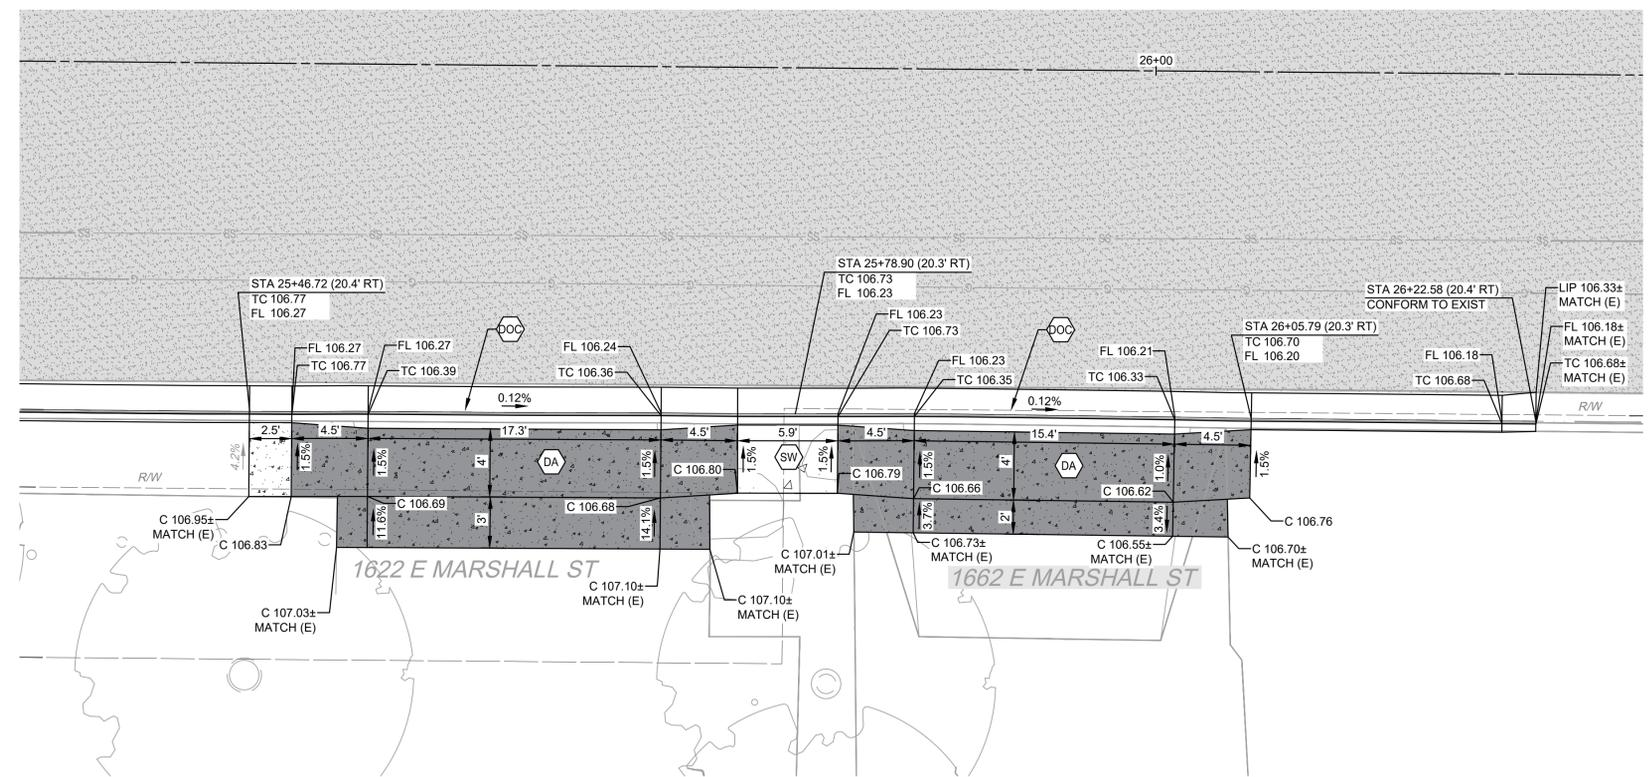





MARSHALL ST & BERKELEY AVE  
SW CURB RAMP

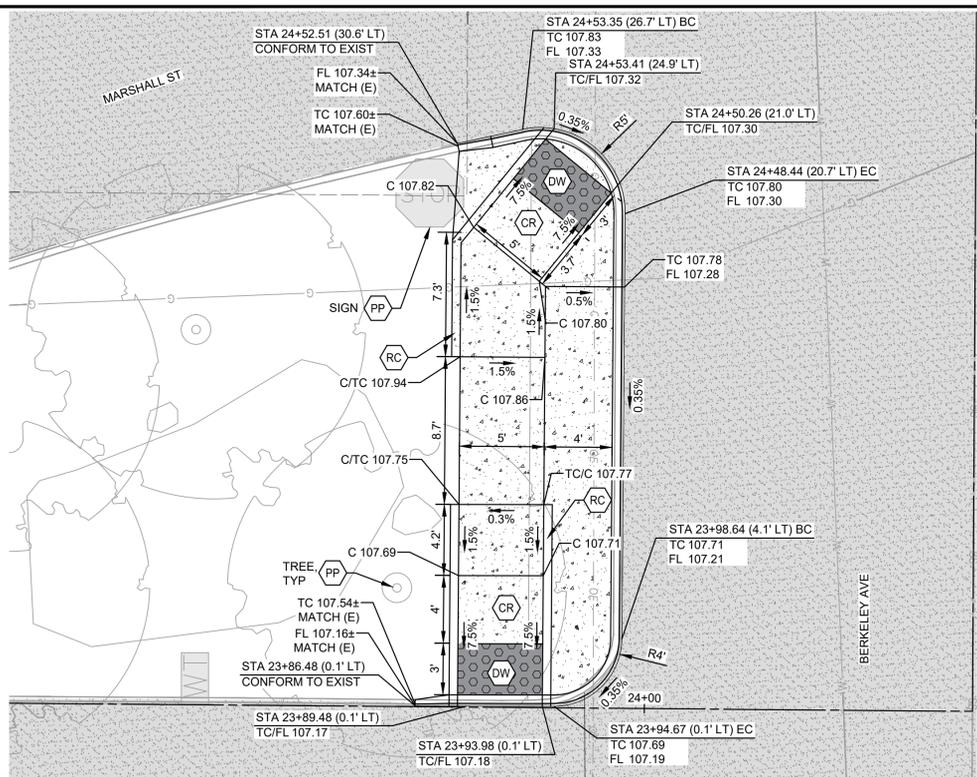

MARSHALL ST & BERKELEY AVE  
SE CURB RAMP



MARSHALL ST  
DRIVEWAY APPROACH

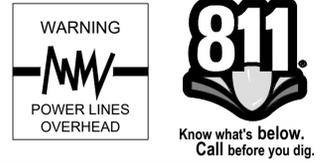

SYM	DESCRIPTION
AA	ALLEY APPROACH PER CITY OF TURLOCK STD DWG C-7
AG	ADJUST TO FINISHED GRADE
CGA	SAWCUT AND REMOVE (E) CURB AND GUTTER AND CONSTRUCT NEW CURB AND GUTTER PER CITY OF TURLOCK STD DWG C-1. DOWEL INTO EXISTING CURB AND GUTTER PER DETAIL 1, SHEET D5
CG	CONSTRUCT NEW CURB AND GUTTER PER CITY OF TURLOCK STD DWG C-1. DOWEL INTO EXISTING CURB AND GUTTER PER DETAIL 1, SHEET D5
CR	SAWCUT AND REMOVE (E) CURB RETURN, RAMPS, AND SIDEWALK AND CONSTRUCT NEW CURB RETURN, RAMP, AND SIDEWALK PER PROJECT SPECIFICATIONS AND SITE DETAILS
DA	RESIDENTIAL DRIVE APPROACH PER CITY OF TURLOCK STD DWG C-5
DA1	REMOVE AND REPLACE EXISTING DRIVE APPROACH TO MATCH AT EXISTING CONCRETE HINGE POINT PER CITY OF TURLOCK STD DWG C-5
DI	REMOVE AND REPLACE CATCH BASIN PER CITY OF TURLOCK STD SD-3 AND T-1
DOC	SAWCUT AND REMOVE (E) CURB AND GUTTER AND CONSTRUCT NEW DRIVE OVER CURB PER CITY OF TURLOCK PER DETAIL 3 ON SHEET D4. DOWEL INTO EXISTING CURB AND GUTTER PER DETAIL 1, SHEET D5
DW	DETECTABLE WARNING SURFACE PER CALTRANS STD DWG SHEET A88A
FH	CONSTRUCT FIRE HYDRANT PER CITY OF TURLOCK STD DWG W-1 AND T-1
MH	ADJUST MANHOLE TO FINISHED GRADE AFTER PAVING OPERATIONS PER DETAIL S-3
NDI	CONSTRUCT CATCH BASIN PER CITY OF TURLOCK STD SD-3 AND T-1
NMH	CONSTRUCT NEW MANHOLE PER CITY OF TURLOCK STD DWG S-3 AND T-1
PP	PROTECT IN PLACE
RC	RETAINING CURB
RD	REMOVE DRAINAGE INLET
RL	REMOVE AND RELOCATE
SW	CONSTRUCT SIDEWALK PER CITY OF TURLOCK STD DWG C-3. PROVIDE 2' SIDEWALK TRANSITION WITHIN LIMITS SHOWN TO MATCH (E) ELEVATIONS. SLOPES WITHIN TRANSITION AREA SHALL NOT EXCEED 4.5% LONGITUDINALLY. DOWEL INTO EXISTING SIDEWALK PER DETAIL 1, SHEET D5. PROTECT (E) ROOF DRAINS IN PLACE OR REPLACE IN KIND
VG	CONSTRUCT VALLEY GUTTER PER CITY OF TURLOCK STD DWG C-1


**LEGEND**

- FDR-C RECONSTRUCTION PER DETAIL 2 SHEET D5
- 6.0" TYPE A HMA PAVEMENT PLUG OVER
- 6" CNS COMPACTED TO 95%
- 3.5" MINIMUM THICK CONCRETE OVER
- 6" CNS COMPACTED TO 90%
- ALLEY/DRIVE APPROACH CONCRETE THICKNESS PER CITY OF TURLOCK STD DWG C-5, C-7 & C-8
- 8.0" TYPE A HMA PAVEMENT OVER
- 6" CNS COMPACTED TO 95%

- CONSTRUCTION NOTES**
- EXISTING DRIVEWAYS, CURB, AND GUTTER TO REMAIN UNLESS OTHERWISE NOTED ON THE PLANS.
  - STATION AND OFFSET ON CURB AND GUTTER REFERS TO A POINT ON THE FLOWLINE.
  - DETAILED RAMP AND DRIVE APPROACH GRADING IS PROVIDED ON SHEETS D7-D22.
  - PROTECT IN PLACE ALL (E) SIDEWALK DRAINS.
  - NOT ALL SEWER LATERALS ARE SHOWN ON THE PLANS.

**BID SET**  
1/22/2026

NO.	REVISION	BY	DATE

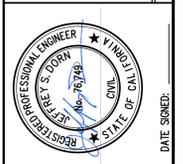

CITY OF TURLOCK  
ROADS PROGRAM CIP  
CITY PROJECT No. 23-068, PACKAGE 3  
DETAILS  
SITE DETAILS

**PROVOST & PRITCHARD**  
425 W. FIFTH AVENUE  
TURLOCK, CA 95259  
PHONE (530) 449-2700  
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www.provostandpritchard.com

DESIGN ENGINEER:  
JEFF DORN  
LICENSE NO:  
76,749

DRAFTED BY: AR  
CHECKED BY: JD

DATE: JAN 2026  
JOB NO: 229224001


PROJECT NO: 229224001  
PHASE: 3

ORIGINAL SCALE SHOWN IS ONE INCH. ADJUST SCALE FOR REDUCED OR ENLARGED PLANS.


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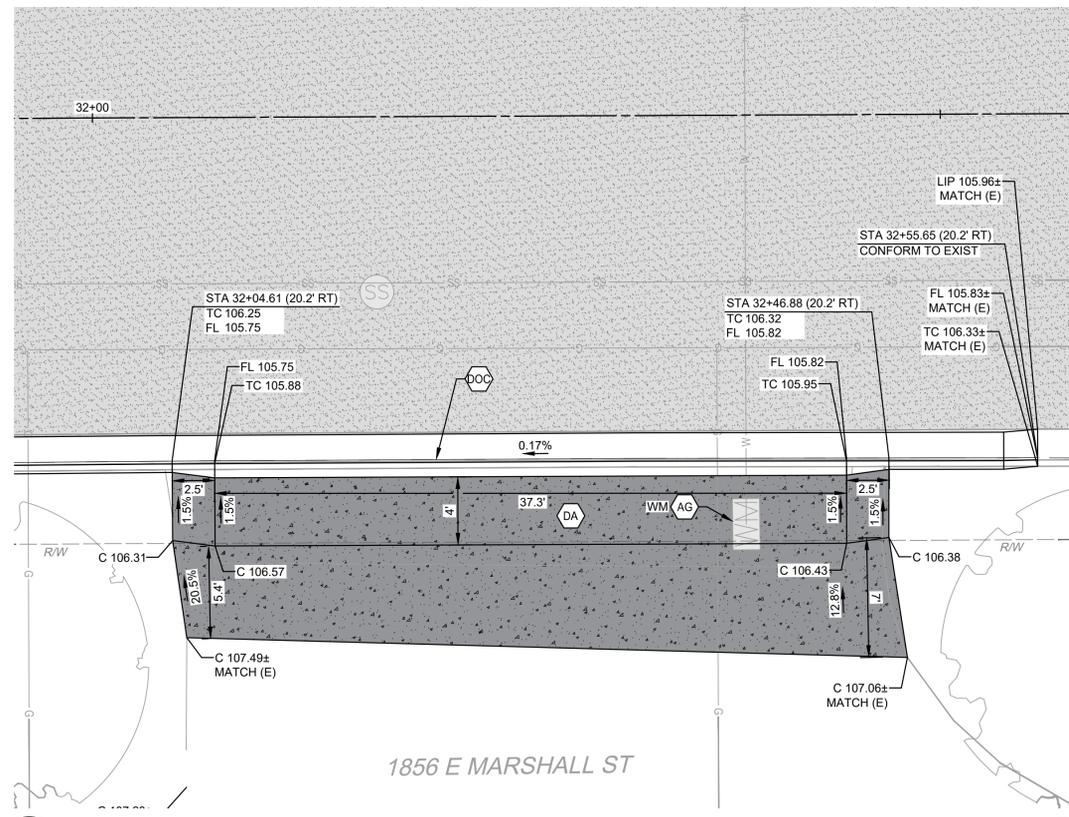
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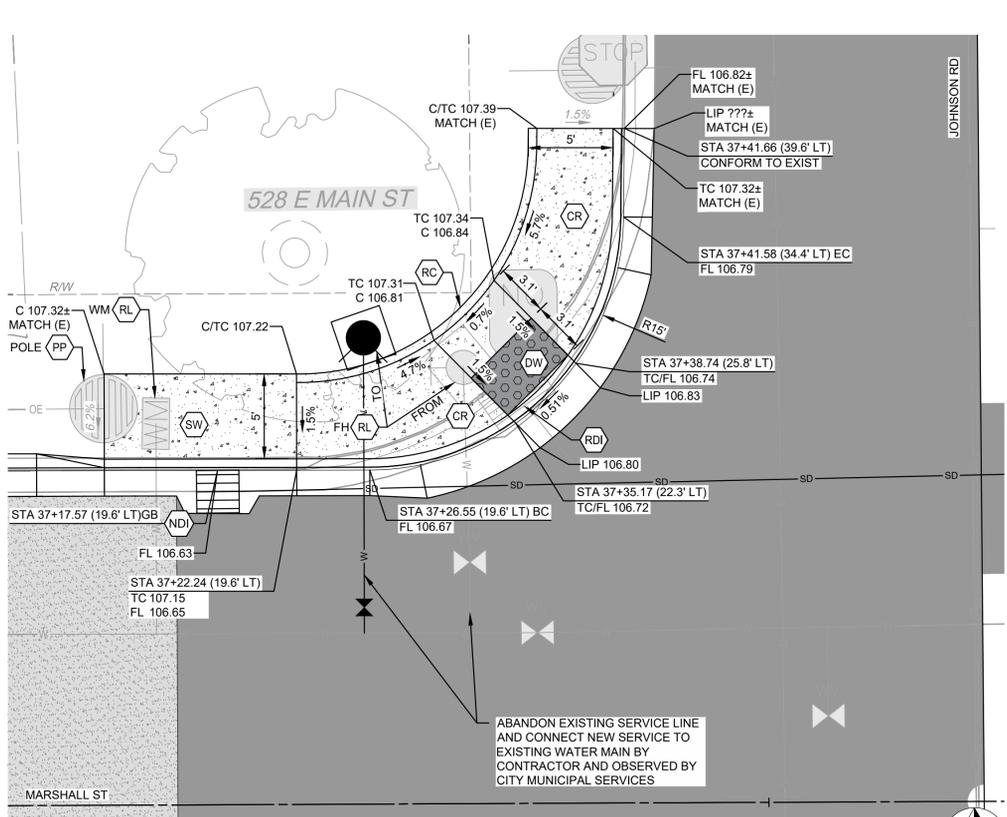
**MARSHALL ST & WALLACE ST**  
NW CURB RAMP




**MARSHALL ST & WALLACE ST**  
NE CURB RAMP

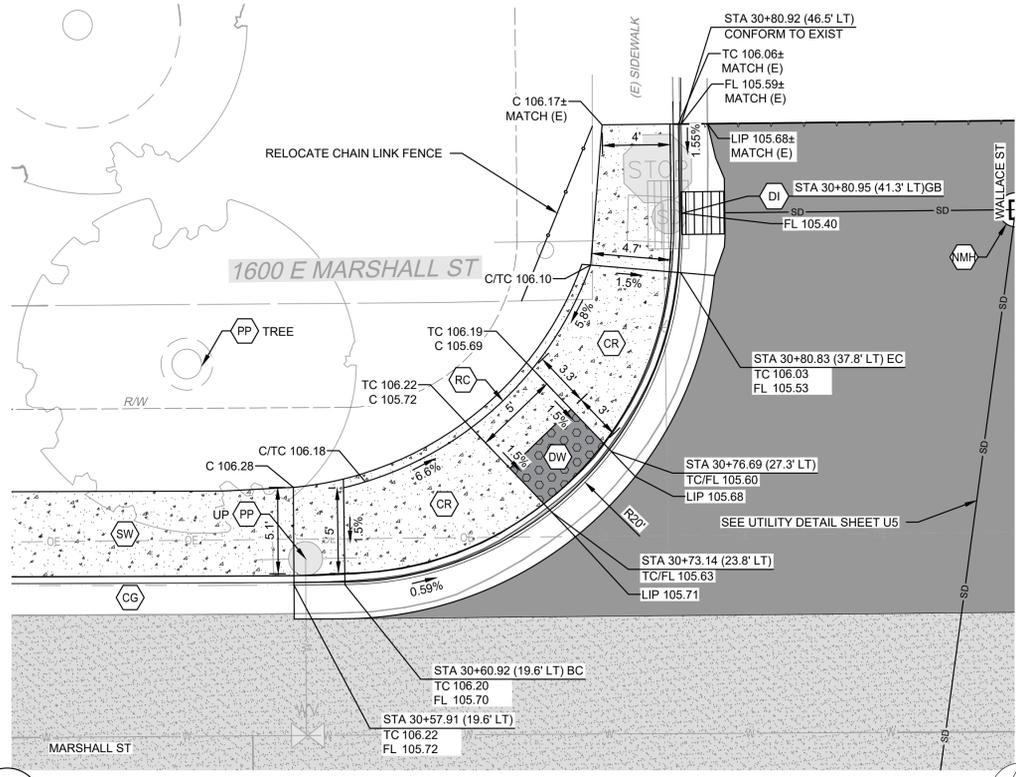

**MARSHALL ST**  
DRIVEWAY

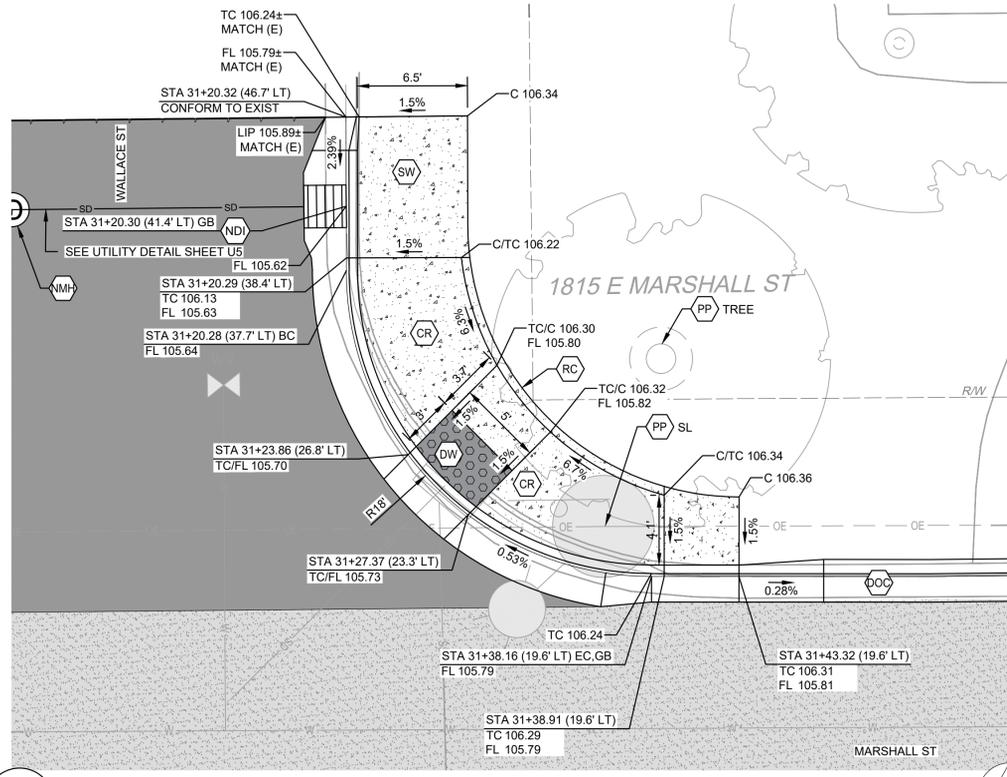

**MARSHALL ST & JOHNSON RD**  
NW CURB RAMP

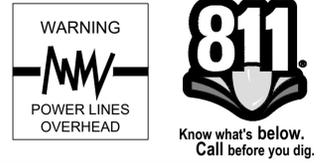

CONSTRUCTION CALLOUTS	
SYM	DESCRIPTION
AA	ALLEY APPROACH PER CITY OF TURLOCK STD DWG C-7
AG	ADJUST TO FINISHED GRADE
CGA	SAWCUT AND REMOVE (E) CURB AND GUTTER AND CONSTRUCT NEW CURB AND GUTTER PER CITY OF TURLOCK STD DWG C-1. DOWEL INTO EXISTING CURB AND GUTTER PER DETAIL 1, SHEET D5
CG	CONSTRUCT NEW CURB AND GUTTER PER CITY OF TURLOCK STD DWG C-1. DOWEL INTO EXISTING CURB AND GUTTER PER DETAIL 1, SHEET D5
CR	SAWCUT AND REMOVE (E) CURB RETURN, RAMPS, AND SIDEWALK AND CONSTRUCT NEW CURB RETURN, RAMP, AND SIDEWALK PER PROJECT SPECIFICATIONS AND SITE DETAILS
DA	RESIDENTIAL DRIVE APPROACH PER CITY OF TURLOCK STD DWG C-5
DA1	REMOVE AND REPLACE EXISTING DRIVE APPROACH TO MATCH AT EXISTING CONCRETE HINGE POINT PER CITY OF TURLOCK STD DWG C-5
DI	REMOVE AND REPLACE CATCH BASIN PER CITY OF TURLOCK STD SD-3 AND T-1
DOC	SAWCUT AND REMOVE (E) CURB AND GUTTER AND CONSTRUCT NEW DRIVE OVER CURB PER CITY OF TURLOCK PER DETAIL 3 ON SHEET D4. DOWEL INTO EXISTING CURB AND GUTTER PER DETAIL 1, SHEET D5
DW	DETECTABLE WARNING SURFACE PER CALTRANS STD DWG SHEET A88A
FH	CONSTRUCT FIRE HYDRANT PER CITY OF TURLOCK STD DWG W-1 AND T-1
MH	ADJUST MANHOLE TO FINISHED GRADE AFTER PAVING OPERATIONS PER DETAIL S-3
NDI	CONSTRUCT CATCH BASIN PER CITY OF TURLOCK STD SD-3 AND T-1
NMH	CONSTRUCT NEW MANHOLE PER CITY OF TURLOCK STD DWG S-3 AND T-1
PP	PROTECT IN PLACE
RC	RETAINING CURB
RD	REMOVE DRAINAGE INLET
RL	REMOVE AND RELOCATE
SW	CONSTRUCT SIDEWALK PER CITY OF TURLOCK STD DWG C-3. PROVIDE 2' SIDEWALK TRANSITION WITHIN LIMITS SHOWN TO MATCH (E) ELEVATIONS. SLOPES WITHIN TRANSITION AREA SHALL NOT EXCEED 4.5% LONGITUDINALLY. DOWEL INTO EXISTING SIDEWALK PER DETAIL 1, SHEET D5. PROTECT (E) ROOF DRAINS IN PLACE OR REPLACE IN KIND
VG	CONSTRUCT VALLEY GUTTER PER CITY OF TURLOCK STD DWG C-1

LEGEND	
[Pattern]	FDR-C RECONSTRUCTION PER DETAIL 2 SHEET D5
[Pattern]	6.0" TYPE A HMA PAVEMENT PLUG OVER 6" CNS COMPACTED TO 95%
[Pattern]	3.5" MINIMUM THICK CONCRETE OVER 6" CNS COMPACTED TO 90%
[Pattern]	ALLEY/DRIVE APPROACH CONCRETE THICKNESS PER CITY OF TURLOCK STD DWG C-5, C-7 & C-8
[Pattern]	8.0" TYPE A HMA PAVEMENT OVER 6" CNS COMPACTED TO 95%

- CONSTRUCTION NOTES**
- EXISTING DRIVEWAYS, CURB, AND GUTTER TO REMAIN UNLESS OTHERWISE NOTED ON THE PLANS.
  - STATION AND OFFSET ON CURB AND GUTTER REFERS TO A POINT ON THE FLOWLINE.
  - DETAILED RAMP AND DRIVE APPROACH GRADING IS PROVIDED ON SHEETS D7-D22.
  - PROTECT IN PLACE ALL (E) SIDEWALK DRAINS.
  - NOT ALL SEWER LATERALS ARE SHOWN ON THE PLANS.

SCALE IN FEET  
0 2.5 5 10

CITY OF TURLOCK  
MUNICIPAL SERVICES DEPARTMENT  
ROADS PROGRAM DIVISION  
156 S. BROADWAY, SUITE 150  
(209) 668-5520

**BID SET**  
1/22/2026

CITY OF TURLOCK  
ROADS PROGRAM CIP  
CITY PROJECT No. 23-068, PACKAGE 3  
DETAILS  
SITE DETAILS

DESIGN ENGINEER:  
JEFF DORN  
LICENSE NO:  
76,749






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CHECKED BY: JD

DATE: JAN 2026  
JOB NO: 229224001  
PROJECT NO: 229224001  
PHASE: 3

ORIGINAL SCALE SHOWN IS ONE INCH. ADJUST SCALE FOR REDUCED OR ENLARGED PLANS.

SHEET **D14**  
38 OF 78

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CONSTRUCTION CALLOUTS	
SYM	DESCRIPTION
AA	ALLEY APPROACH PER CITY OF TURLOCK STD DWG C-7
AG	ADJUST TO FINISHED GRADE
CGA	SAWCUT AND REMOVE (E) CURB AND GUTTER AND CONSTRUCT NEW CURB AND GUTTER PER CITY OF TURLOCK STD DWG C-1. DOWEL INTO EXISTING CURB AND GUTTER PER DETAIL 1, SHEET D5
CG	CONSTRUCT NEW CURB AND GUTTER PER CITY OF TURLOCK STD DWG C-1. DOWEL INTO EXISTING CURB AND GUTTER PER DETAIL 1, SHEET D5
CR	SAWCUT AND REMOVE (E) CURB RETURN, RAMPS, AND SIDEWALK AND CONSTRUCT NEW CURB RETURN, RAMP, AND SIDEWALK PER PROJECT SPECIFICATIONS AND SITE DETAILS
DA	RESIDENTIAL DRIVE APPROACH PER CITY OF TURLOCK STD DWG C-5
DA1	REMOVE AND REPLACE EXISTING DRIVE APPROACH TO MATCH AT EXISTING CONCRETE HINGE POINT PER CITY OF TURLOCK STD DWG C-5
DI	REMOVE AND REPLACE CATCH BASIN PER CITY OF TURLOCK STD SD-3 AND T-1
DOC	SAWCUT AND REMOVE (E) CURB AND GUTTER AND CONSTRUCT NEW DRIVE OVER CURB PER CITY OF TURLOCK PER DETAIL 3 ON SHEET D4. DOWEL INTO EXISTING CURB AND GUTTER PER DETAIL 1, SHEET D5
DW	DETECTABLE WARNING SURFACE PER CALTRANS STD DWG SHEET A88A
FH	CONSTRUCT FIRE HYDRANT PER CITY OF TURLOCK STD DWG W-1 AND T-1
MH	ADJUST MANHOLE TO FINISHED GRADE AFTER PAVING OPERATIONS PER DETAIL S-3
NDI	CONSTRUCT CATCH BASIN PER CITY OF TURLOCK STD SD-3 AND T-1
NMH	CONSTRUCT NEW MANHOLE PER CITY OF TURLOCK STD DWG S-3 AND T-1
PP	PROTECT IN PLACE
RC	RETAINING CURB
RD	REMOVE DRAINAGE INLET
RL	REMOVE AND RELOCATE
SW	CONSTRUCT SIDEWALK PER CITY OF TURLOCK STD DWG C-3. PROVIDE 2' SIDEWALK TRANSITION WITHIN LIMITS SHOWN TO MATCH (E) ELEVATIONS. SLOPES WITHIN TRANSITION AREA SHALL NOT EXCEED 4.5% LONGITUDINALLY. DOWEL INTO EXISTING SIDEWALK PER DETAIL 1, SHEET D5. PROTECT (E) ROOF DRAINS IN PLACE OR REPLACE IN KIND
VG	CONSTRUCT VALLEY GUTTER PER CITY OF TURLOCK STD DWG C-1

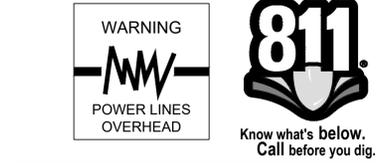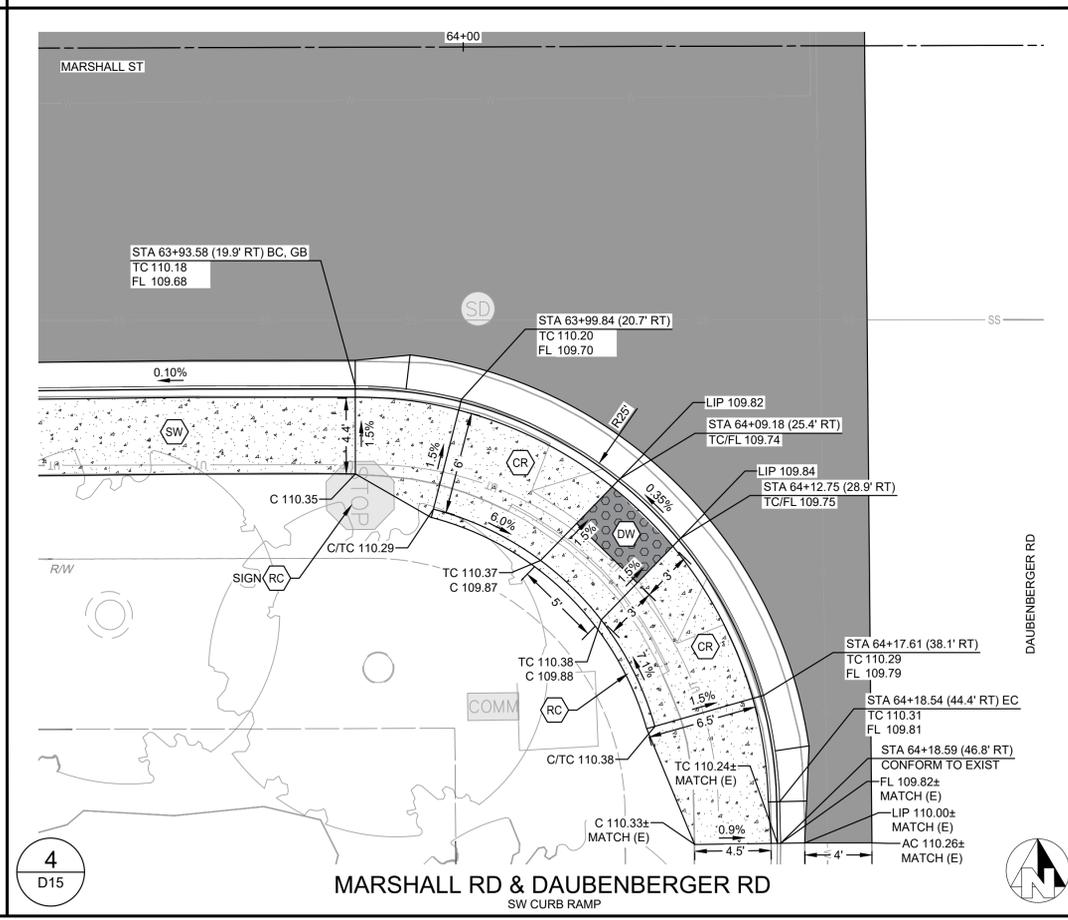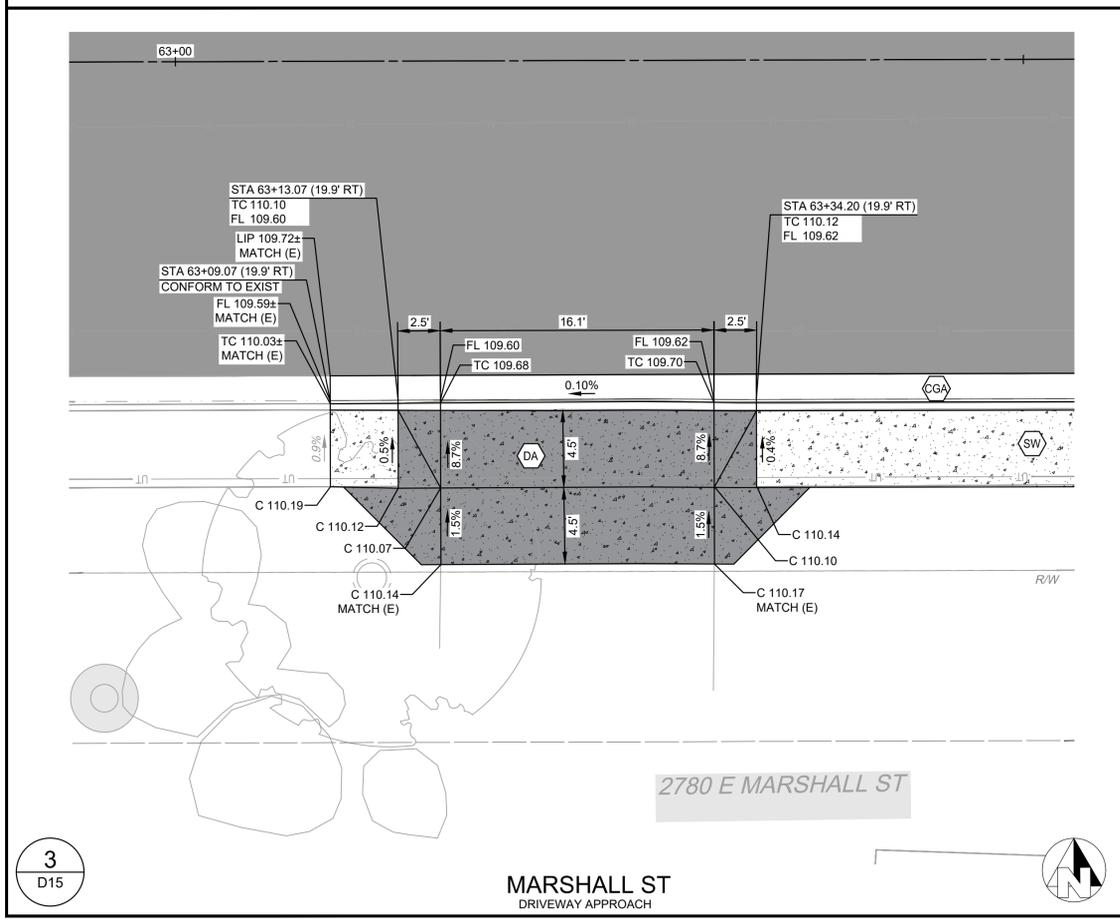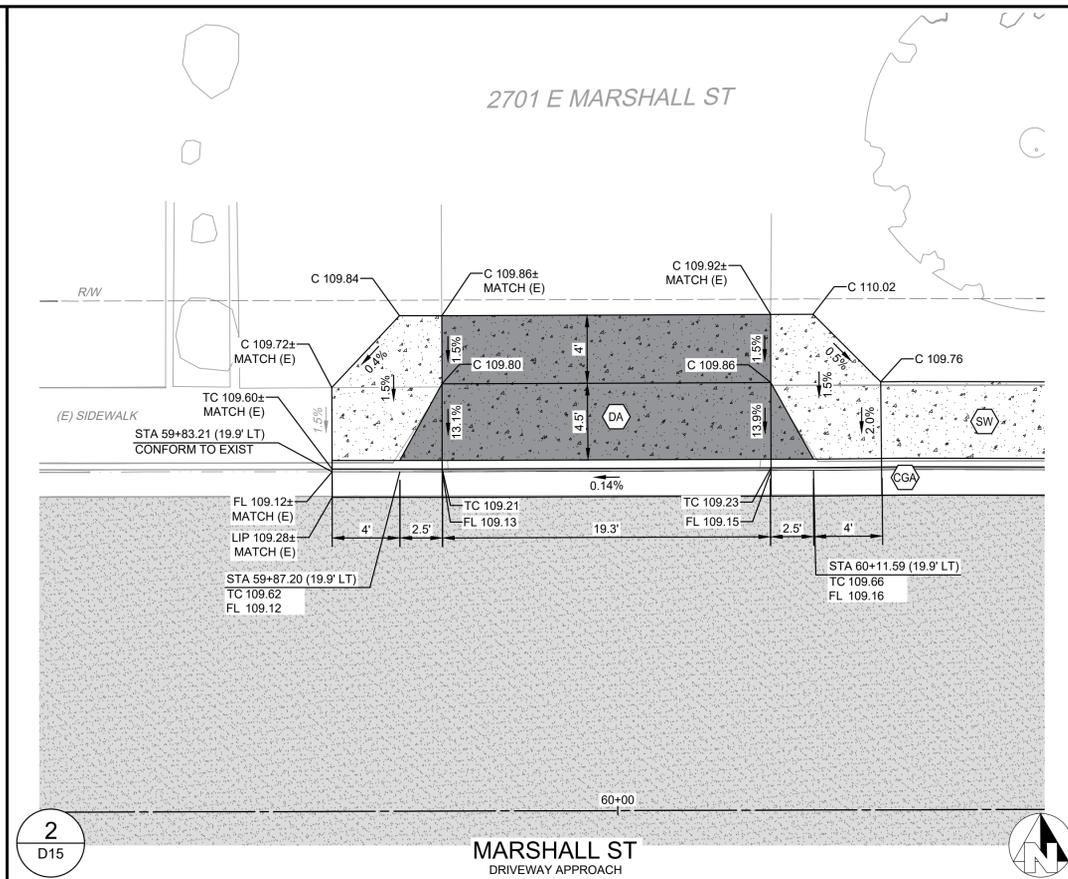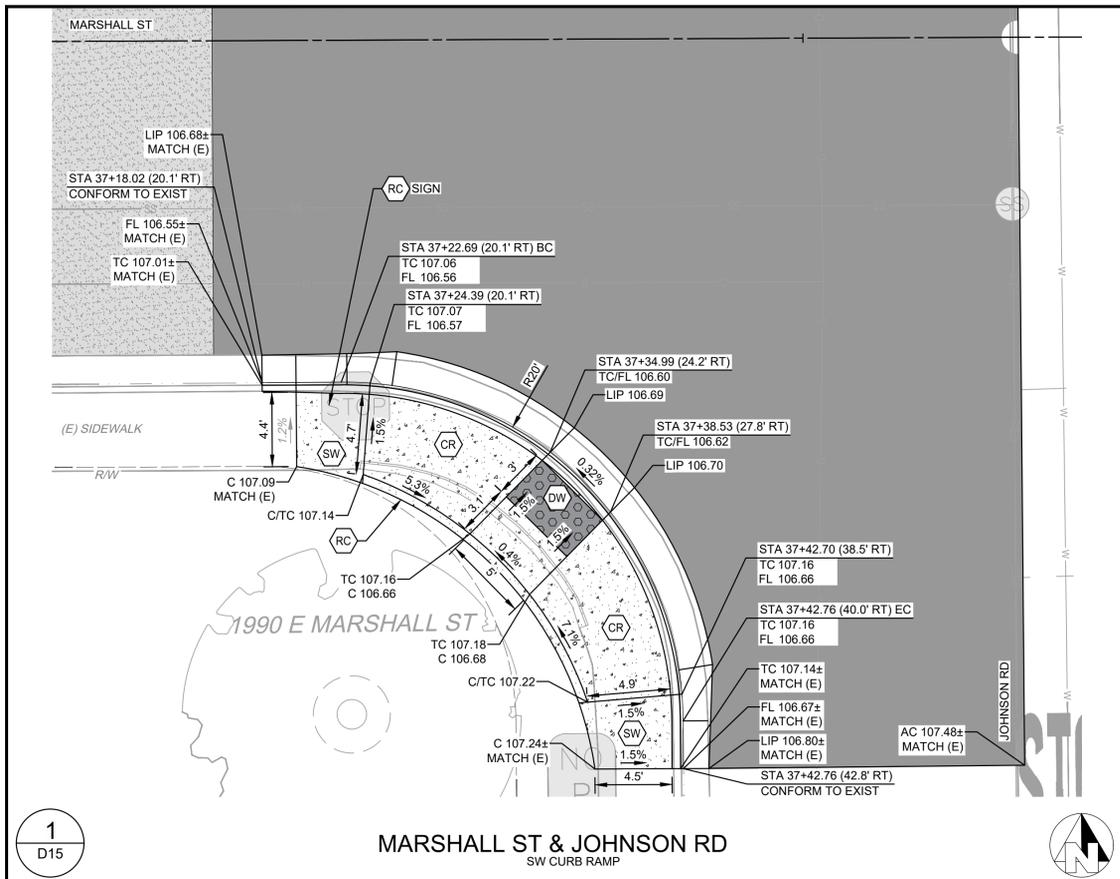LEGEND	
[Pattern]	FDR-C RECONSTRUCTION PER DETAIL 2 SHEET D5
[Pattern]	6.0" TYPE A HMA PAVEMENT PLUG OVER
[Pattern]	6" CNS COMPACTED TO 95%
[Pattern]	3.5" MINIMUM THICK CONCRETE OVER
[Pattern]	6" CNS COMPACTED TO 90%
[Pattern]	ALLEY/DRIVE APPROACH CONCRETE THICKNESS PER CITY OF TURLOCK STD DWG C-5, C-7 & C-8
[Pattern]	8.0" TYPE A HMA PAVEMENT OVER
[Pattern]	6" CNS COMPACTED TO 95%

- CONSTRUCTION NOTES**
- EXISTING DRIVEWAYS, CURB, AND GUTTER TO REMAIN UNLESS OTHERWISE NOTED ON THE PLANS.
  - STATION AND OFFSET ON CURB AND GUTTER REFERS TO A POINT ON THE FLOWLINE.
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SCALE IN FEET  
0 2.5 5 10

CITY OF TURLOCK  
MUNICIPAL SERVICES DEPARTMENT  
ROADS PROGRAM DIVISION  
156 S. BROADWAY, SUITE 150  
(209) 668-5520

DESIGN ENGINEER:  
JEFF DORN  
LICENSE NO:  
76,749

DRAFTED BY: AR  
CHECKED BY: JD

DATE: JAN 2026  
JOB NO: 229224001  
PROJECT NO: 229224001  
PHASE: 3

ORIGINAL SCALE SHOWN IS ONE INCH. ADJUST SCALE FOR REDUCED OR ENLARGED PLANS.

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39 OF 78

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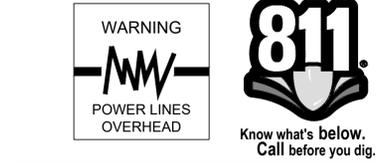
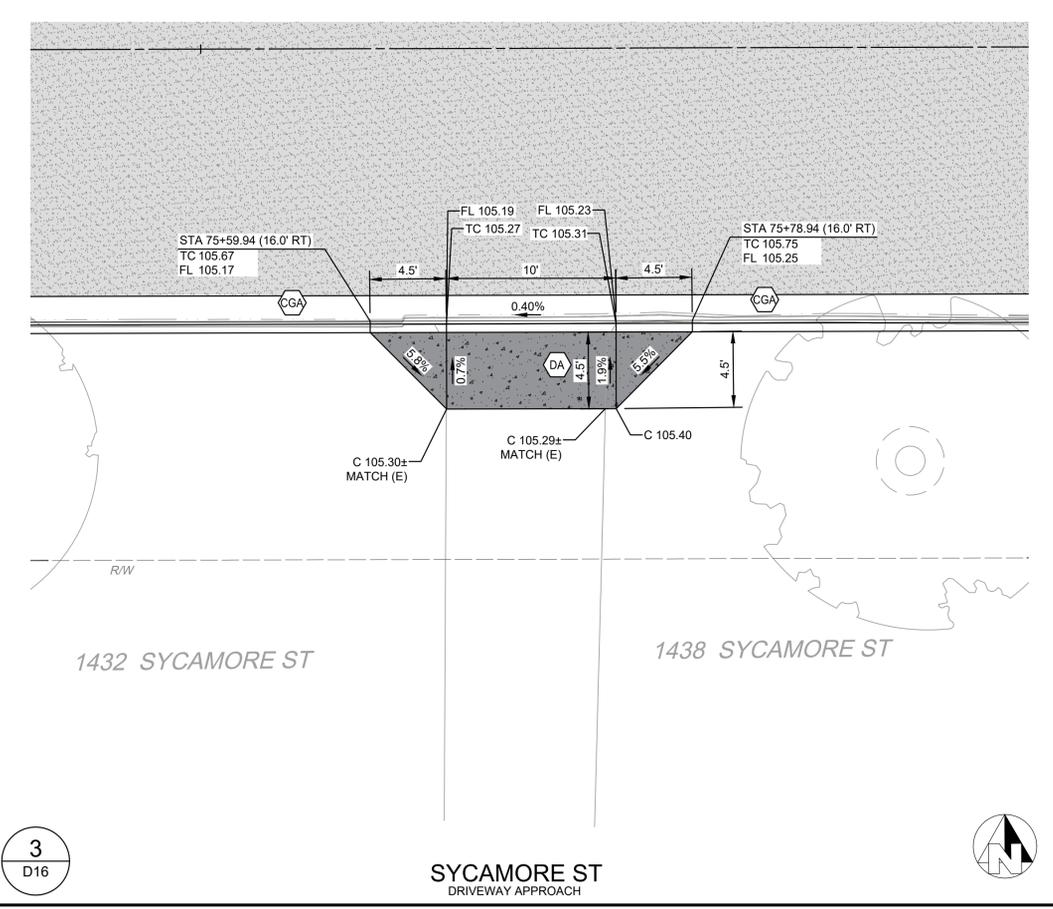
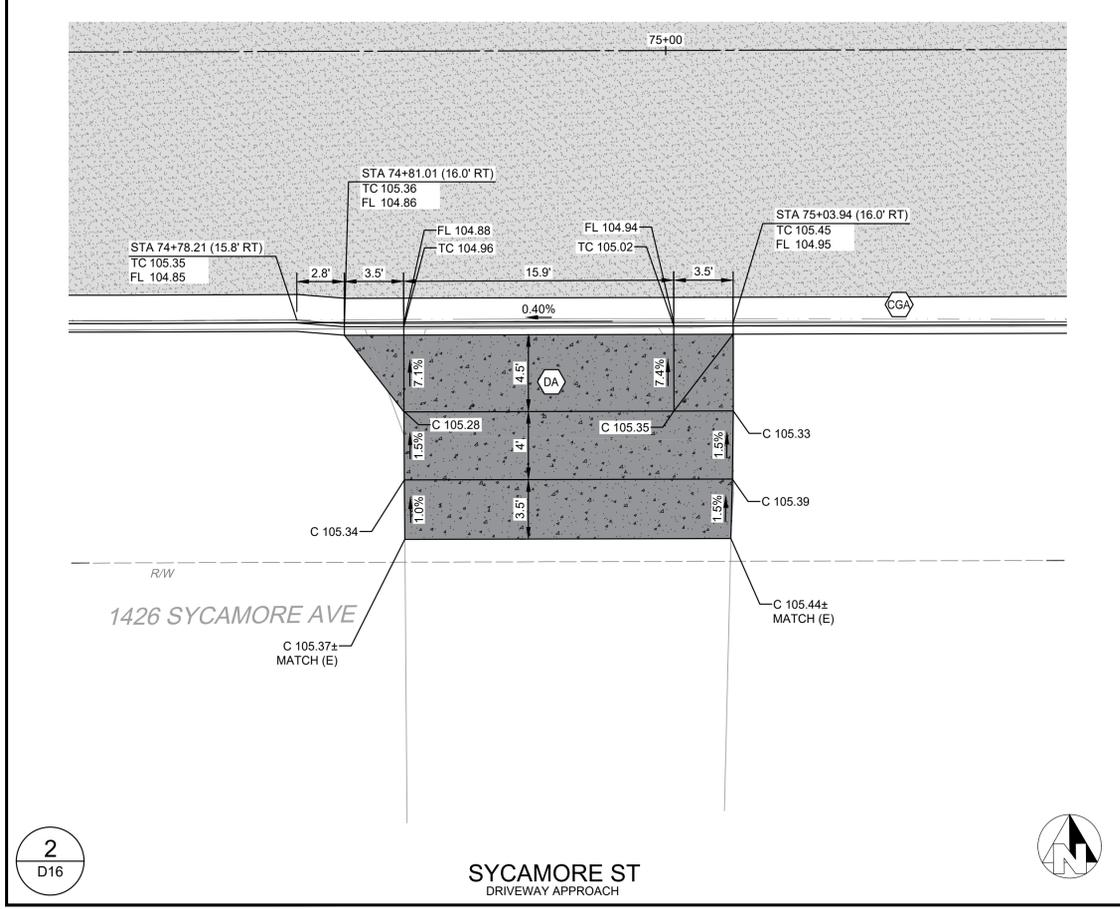
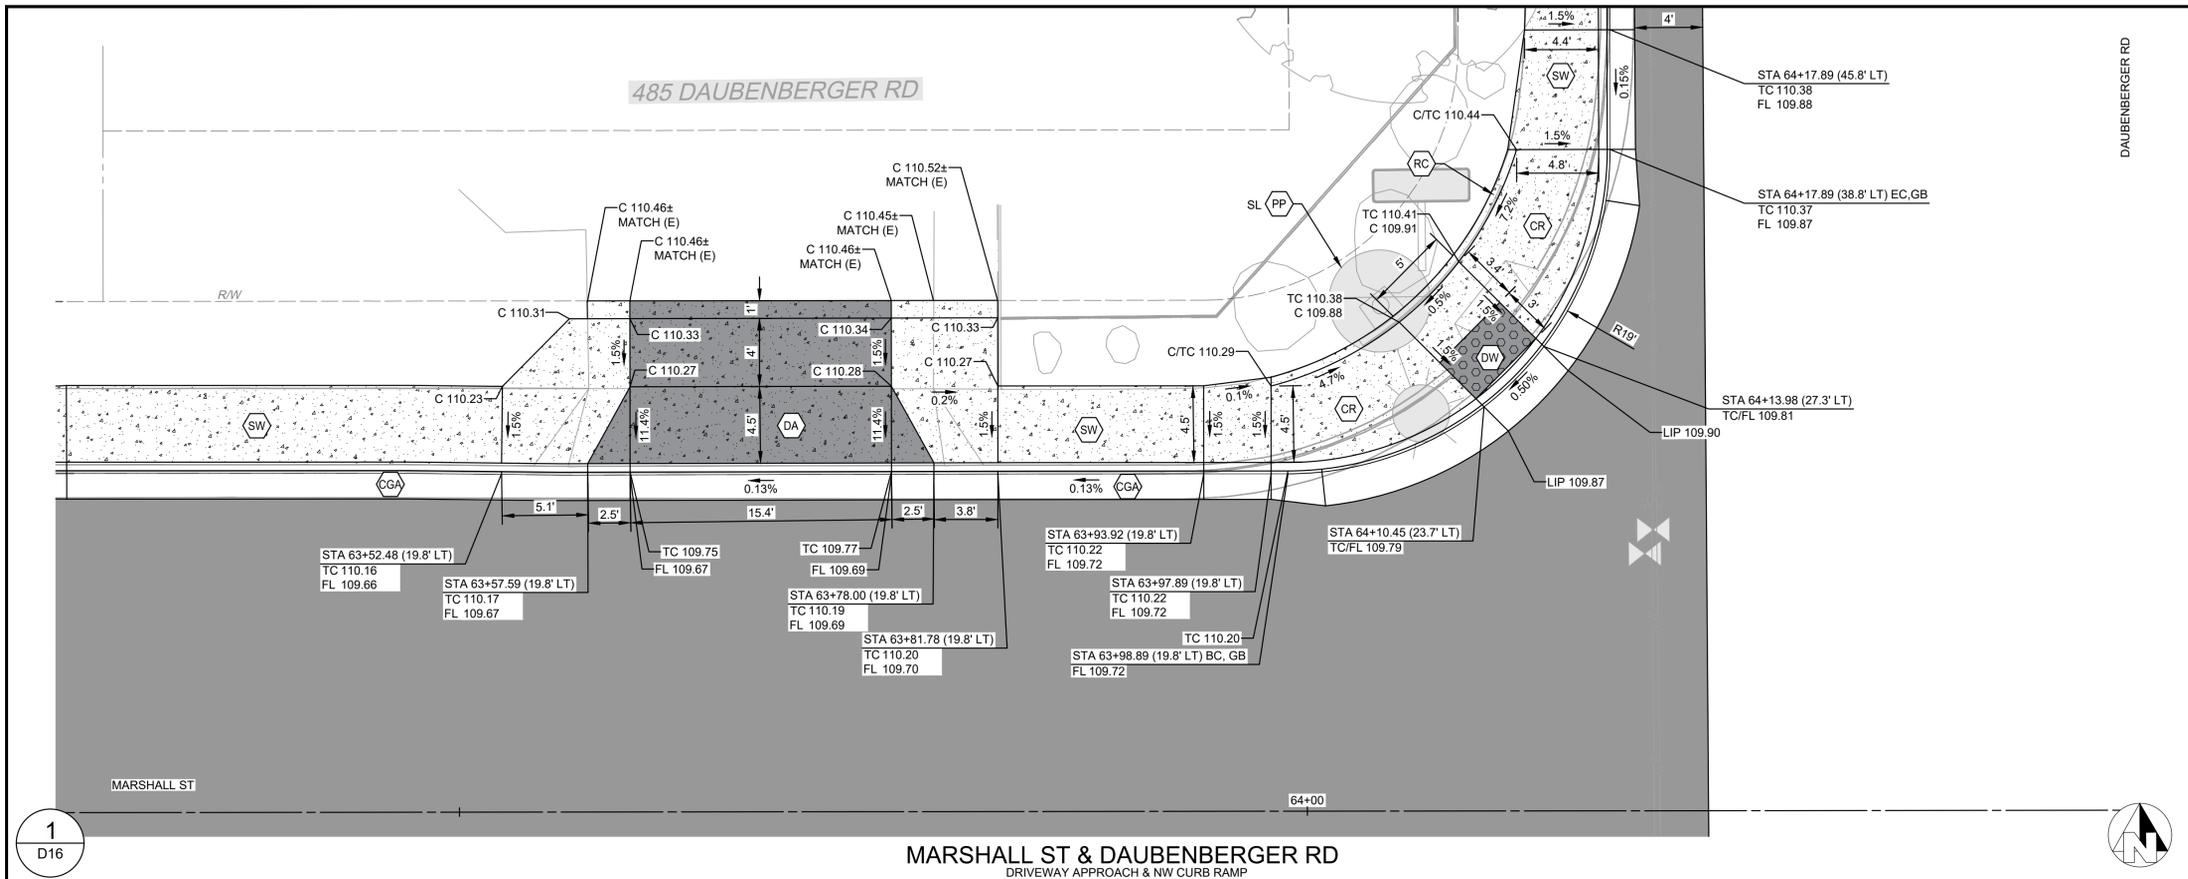
**BID SET**  
1/22/2026

CITY OF TURLOCK  
ROADS PROGRAM CIP  
CITY PROJECT No. 23-068, PACKAGE 3  
DETAILS

**SITE DETAILS**

DATE SIGNED: [Signature]  
NO. [ ]  
REVISION [ ]  
BY [ ]  
DATE [ ]

PROVOST & PRITCHARD  
425 W. FIR AVENUE  
TURLOCK, CA 95259  
PHONE (209) 449-2700  
FAX (209) 449-2715  
www.provostandpritchard.com



CONSTRUCTION CALLOUTS	
SYM	DESCRIPTION
AA	ALLEY APPROACH PER CITY OF TURLOCK STD DWG C-7
AG	ADJUST TO FINISHED GRADE
CGA	SAWCUT AND REMOVE (E) CURB AND GUTTER AND CONSTRUCT NEW CURB AND GUTTER PER CITY OF TURLOCK STD DWG C-1. DOWEL INTO EXISTING CURB AND GUTTER PER DETAIL 1, SHEET D5
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MH	ADJUST MANHOLE TO FINISHED GRADE AFTER PAVING OPERATIONS PER DETAIL S-3
NDI	CONSTRUCT CATCH BASIN PER CITY OF TURLOCK STD SD-3 AND T-1
NMH	CONSTRUCT NEW MANHOLE PER CITY OF TURLOCK STD DWG S-3 AND T-1
PP	PROTECT IN PLACE
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RD	REMOVE DRAINAGE INLET
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VG	CONSTRUCT VALLEY GUTTER PER CITY OF TURLOCK STD DWG C-1

LEGEND	
	FDR-C RECONSTRUCTION PER DETAIL 2 SHEET D5
	6.0" TYPE A HMA PAVEMENT PLUG OVER
	6" CNS COMPACTED TO 95%
	3.5" MINIMUM THICK CONCRETE OVER
	6" CNS COMPACTED TO 90%
	ALLEY/DRIVE APPROACH CONCRETE THICKNESS PER CITY OF TURLOCK STD DWG C-5, C-7 & C-8
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- CONSTRUCTION NOTES**
- EXISTING DRIVEWAYS, CURB, AND GUTTER TO REMAIN UNLESS OTHERWISE NOTED ON THE PLANS.
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CITY OF TURLOCK
   
 MUNICIPAL SERVICES DEPARTMENT
   
 ROADS PROGRAM DIVISION
   
 156 S. BROADWAY, SUITE 150
   
 (209) 668-5520

SCALE IN FEET

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**BID SET**  
 1/22/2026

NO.	REVISION	BY	DATE

DATE SIGNED: \_\_\_\_\_

CITY OF TURLOCK  
 ROADS PROGRAM CIP  
 CITY PROJECT No. 23-068, PACKAGE 3  
 DETAILS

**PROVOST & PRITCHARD**  
 425 W. FIR AVENUE  
 CHICO, CA 95926  
 PHONE (530) 449-2700  
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 www.provostandpritchard.com

DESIGN ENGINEER:  
 JEFF DORN  
 LICENSE NO:  
 76,749


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 DATE: JAN 2026  
 JOB NO: 229224001  
 PROJECT NO: 229224001  
 PHASE: 3

ORIGINAL SCALE SHOWN IS ONE INCH. ADJUST SCALE FOR REDUCED OR ENLARGED PLANS.


SHEET **D16**  
 40 OF 78





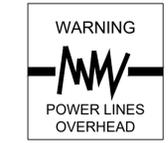

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2  
D18

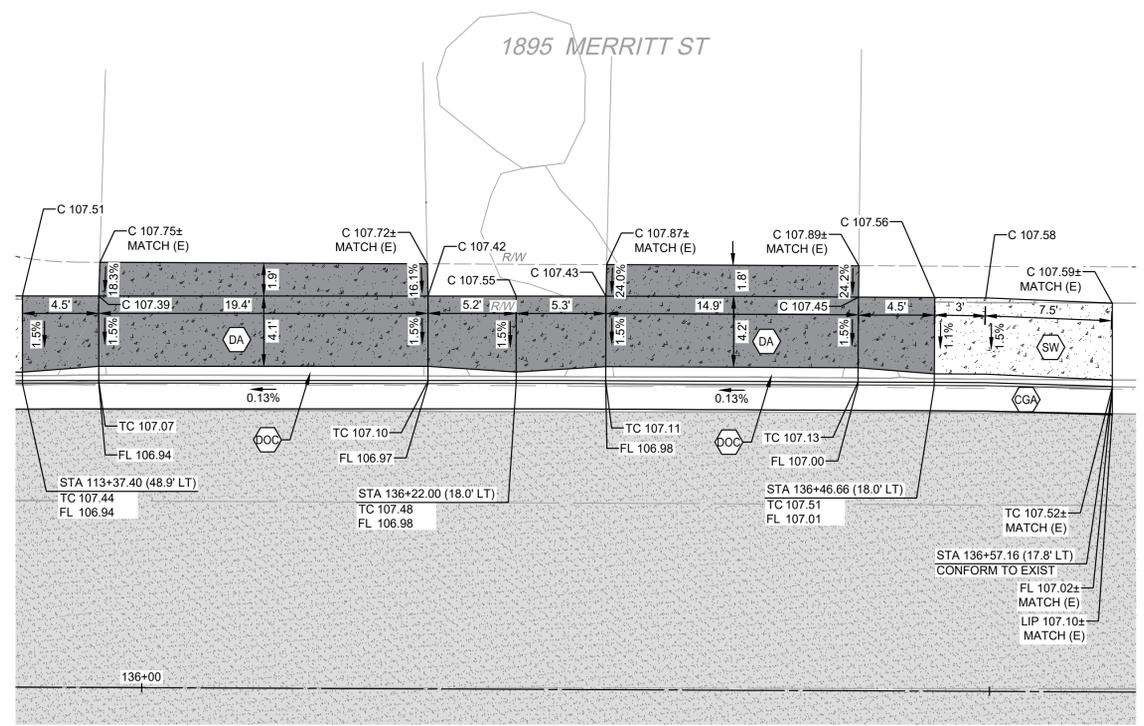VILLA CT  
DRIVEWAY APPROACH




CONSTRUCTION CALLOUTS	
SYM	DESCRIPTION
AA	ALLEY APPROACH PER CITY OF TURLOCK STD DWG C-7
AG	ADJUST TO FINISHED GRADE
CGA	SAWCUT AND REMOVE (E) CURB AND GUTTER AND CONSTRUCT NEW CURB AND GUTTER PER CITY OF TURLOCK STD DWG C-1. DOWEL INTO EXISTING CURB AND GUTTER PER DETAIL 1, SHEET D5
CG	CONSTRUCT NEW CURB AND GUTTER PER CITY OF TURLOCK STD DWG C-1. DOWEL INTO EXISTING CURB AND GUTTER PER DETAIL 1, SHEET D5
CR	SAWCUT AND REMOVE (E) CURB RETURN, RAMPS, AND SIDEWALK AND CONSTRUCT NEW CURB RETURN, RAMP, AND SIDEWALK PER PROJECT SPECIFICATIONS AND SITE DETAILS
DA	RESIDENTIAL DRIVE APPROACH PER CITY OF TURLOCK STD DWG C-5
DA1	REMOVE AND REPLACE EXISTING DRIVE APPROACH TO MATCH AT EXISTING CONCRETE HINGE POINT PER CITY OF TURLOCK STD DWG C-5
DI	REMOVE AND REPLACE CATCH BASIN PER CITY OF TURLOCK STD SD-3 AND T-1
DOC	SAWCUT AND REMOVE (E) CURB AND GUTTER AND CONSTRUCT NEW DRIVE OVER CURB PER CITY OF TURLOCK PER DETAIL 3 ON SHEET D4. DOWEL INTO EXISTING CURB AND GUTTER PER DETAIL 1, SHEET D5
DW	DETECTABLE WARNING SURFACE PER CALTRANS STD DWG SHEET A88A
FH	CONSTRUCT FIRE HYDRANT PER CITY OF TURLOCK STD DWG W-1 AND T-1
MH	ADJUST MANHOLE TO FINISHED GRADE AFTER PAVING OPERATIONS PER DETAIL S-3
ND	CONSTRUCT CATCH BASIN PER CITY OF TURLOCK STD SD-3 AND T-1
NMH	CONSTRUCT NEW MANHOLE PER CITY OF TURLOCK STD DWG S-3 AND T-1
PP	PROTECT IN PLACE
RC	RETAINING CURB
RD	REMOVE DRAINAGE INLET
RL	REMOVE AND RELOCATE
SW	CONSTRUCT SIDEWALK PER CITY OF TURLOCK STD DWG C-3. PROVIDE 2' SIDEWALK TRANSITION WITHIN LIMITS SHOWN TO MATCH (E) ELEVATIONS. SLOPES WITHIN TRANSITION AREA SHALL NOT EXCEED 4.5% LONGITUDINALLY. DOWEL INTO EXISTING SIDEWALK PER DETAIL 1, SHEET D5. PROTECT (E) ROOF DRAINS IN PLACE OR REPLACE IN KIND
VG	CONSTRUCT VALLEY GUTTER PER CITY OF TURLOCK STD DWG C-1

LEGEND

	FDR-C RECONSTRUCTION PER DETAIL 2 SHEET D5
	6" TYPE A HMA PAVEMENT PLUG OVER
	6" CNS COMPACTED TO 95%
	3.5" MINIMUM THICK CONCRETE OVER
	6" CNS COMPACTED TO 90%
	ALLEY/DRIVE APPROACH CONCRETE THICKNESS PER CITY OF TURLOCK STD DWG C-5, C-7 & C-8
	8" TYPE A HMA PAVEMENT OVER
	6" CNS COMPACTED TO 95%

- CONSTRUCTION NOTES
- EXISTING DRIVEWAYS, CURB, AND GUTTER TO REMAIN UNLESS OTHERWISE NOTED ON THE PLANS.
  - STATION AND OFFSET ON CURB AND GUTTER REFERS TO A POINT ON THE FLOWLINE.
  - DETAILED RAMP AND DRIVE APPROACH GRADING IS PROVIDED ON SHEETS D7-D22.
  - PROTECT IN PLACE ALL (E) SIDEWALK DRAINS.
  - NOT ALL SEWER LATERALS ARE SHOWN ON THE PLANS.

BID SET  
1/22/2026

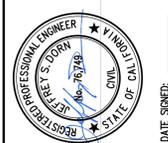

CITY OF TURLOCK  
ROADS PROGRAM CIP  
CITY PROJECT No. 23-068, PACKAGE 3  
DETAILS  
SITE DETAILS

PROVOST & PRITCHARD  
425 W. FIFTH AVENUE  
TURLOCK, CA 95259  
PHONE (530) 449-2700  
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www.provostandpritchard.com

DESIGN ENGINEER:  
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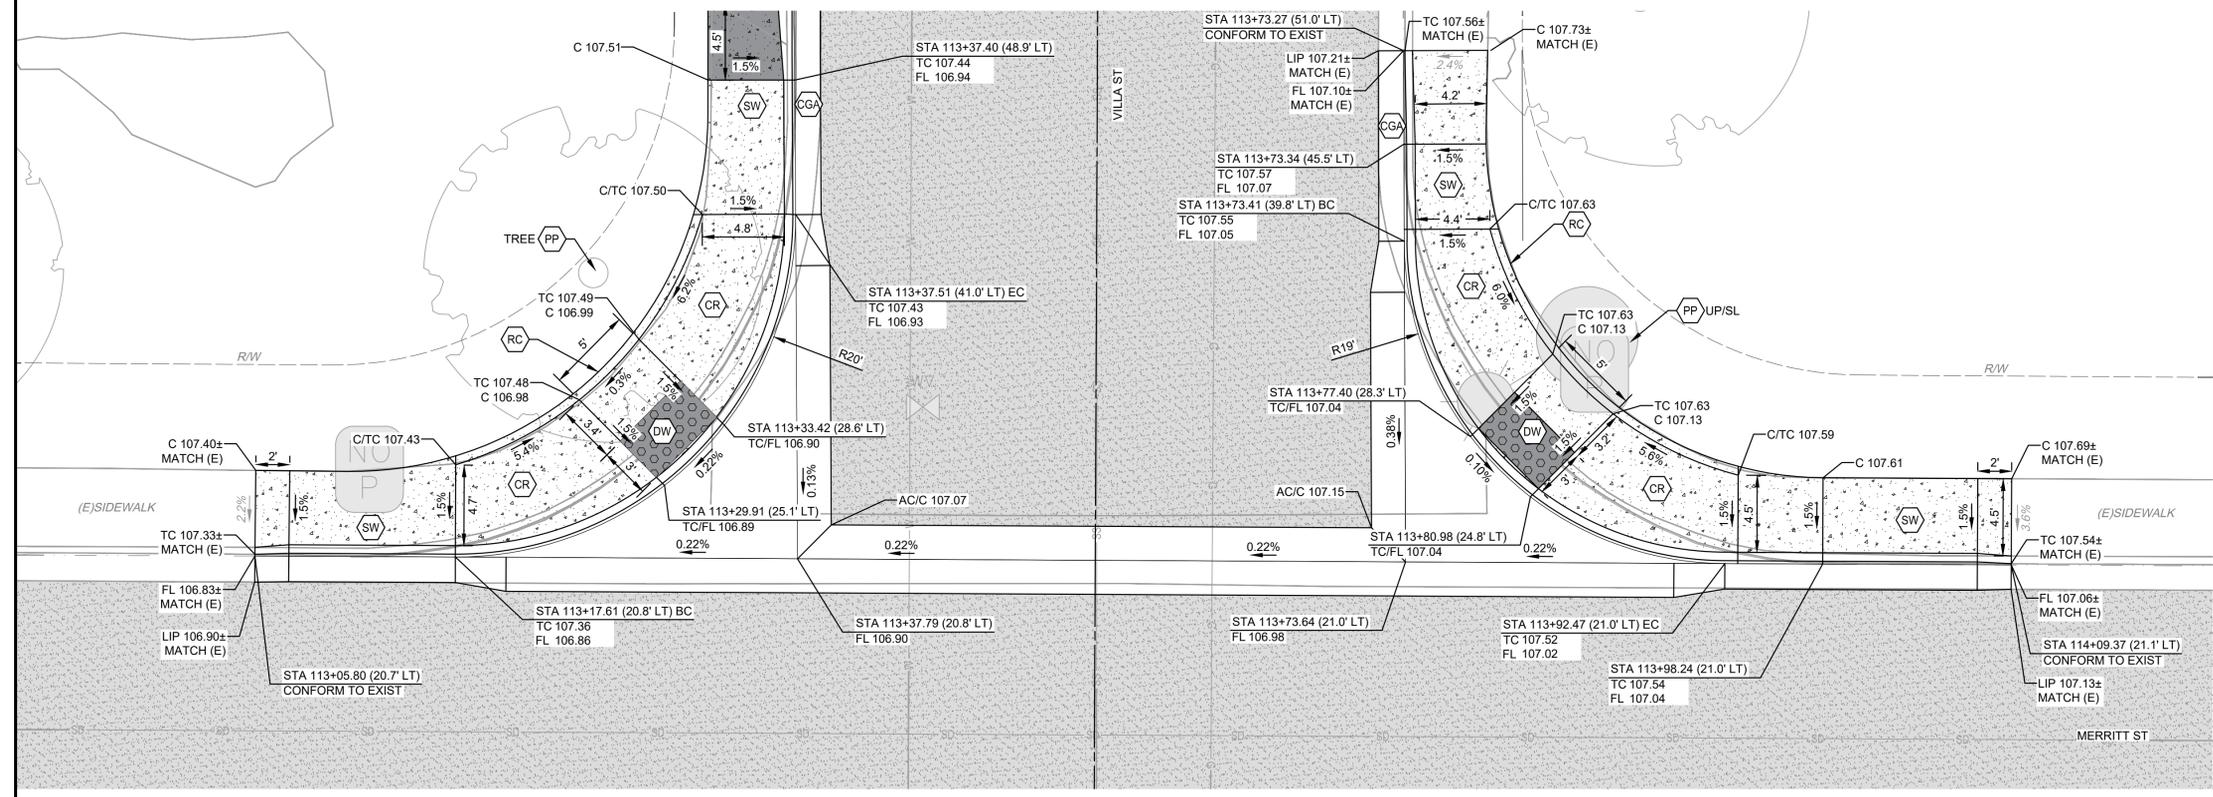
PHASE: 3

0 1" INCH ADJUST SCALE FOR REDUCED OR ENLARGED PLANS.

ORIGINAL SCALE SHOWN IS ONE INCH ADJUST SCALE FOR REDUCED OR ENLARGED PLANS.


SHEET D18

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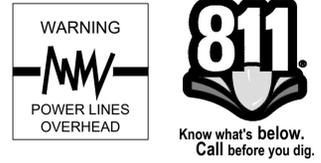
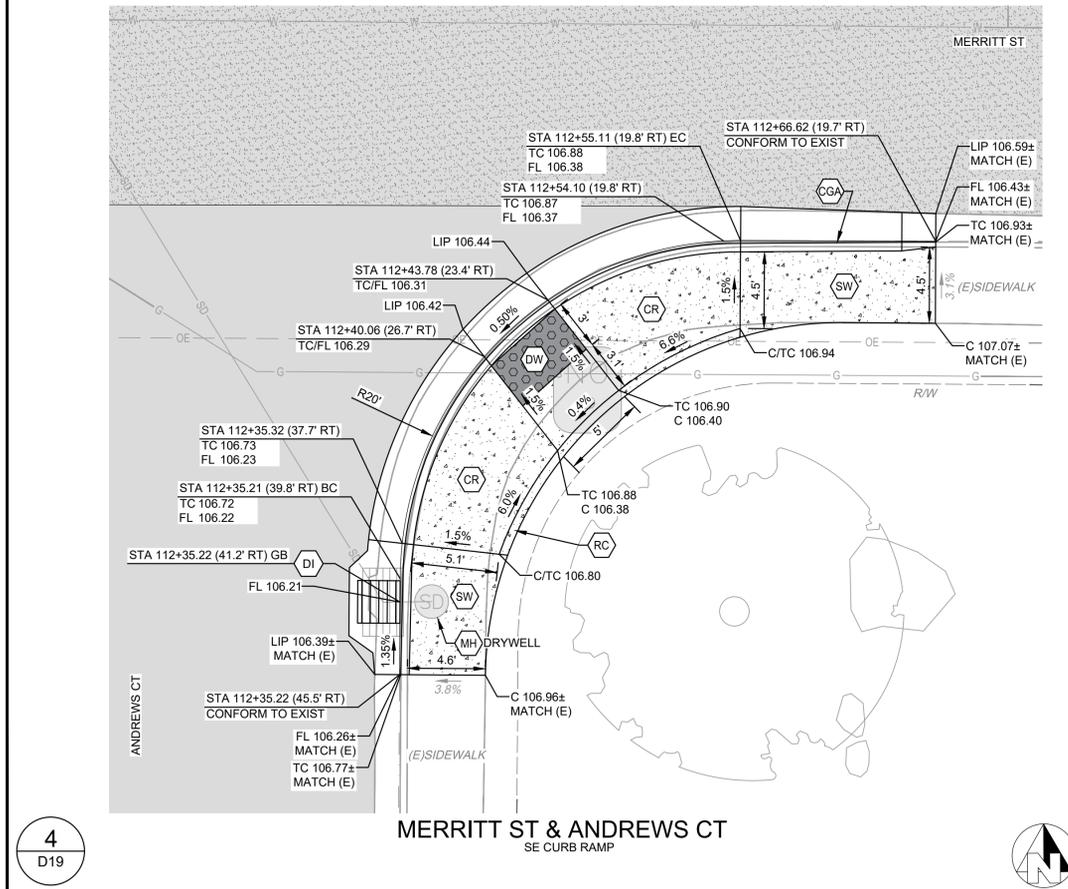
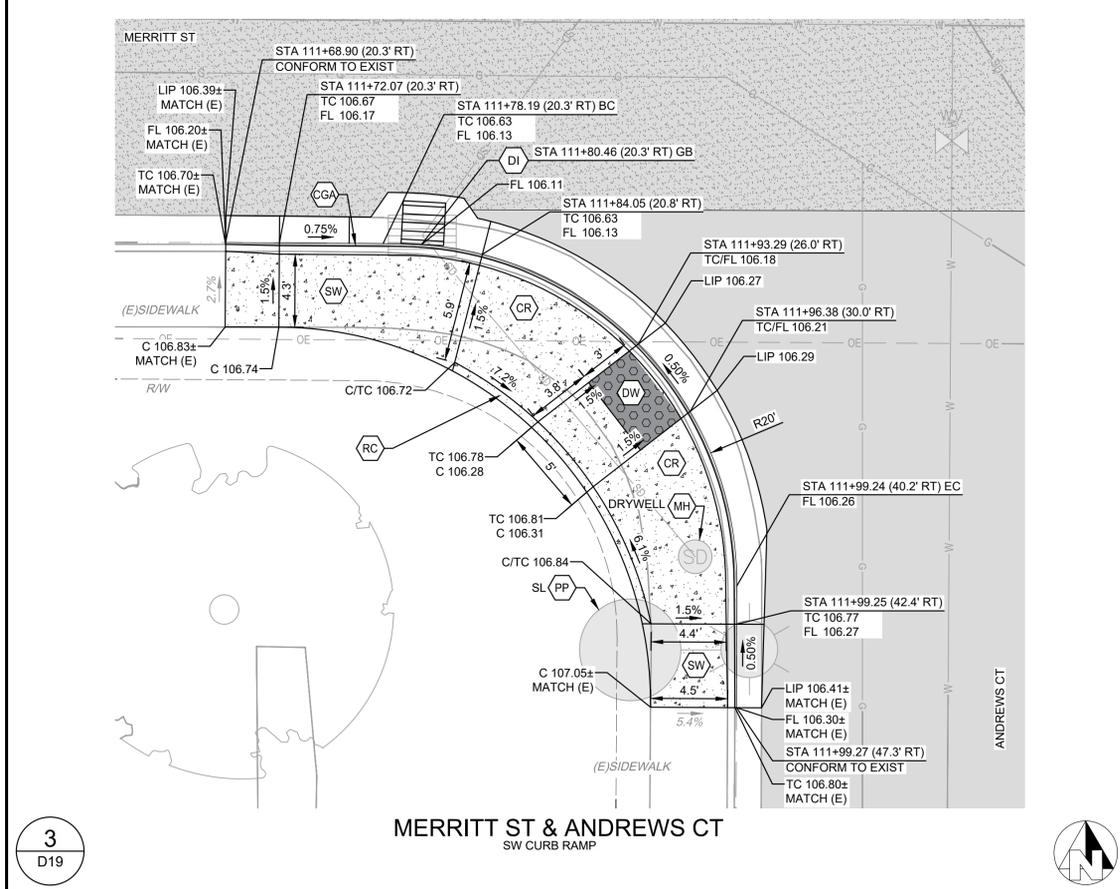
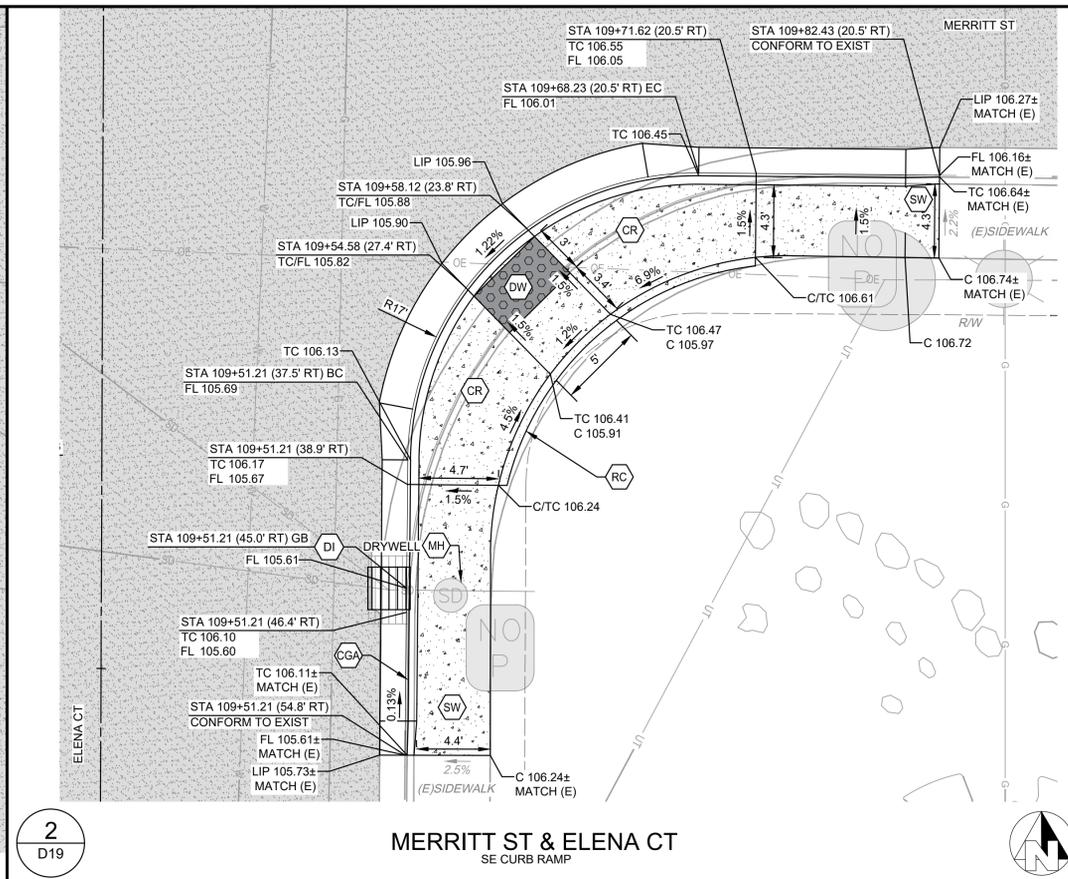
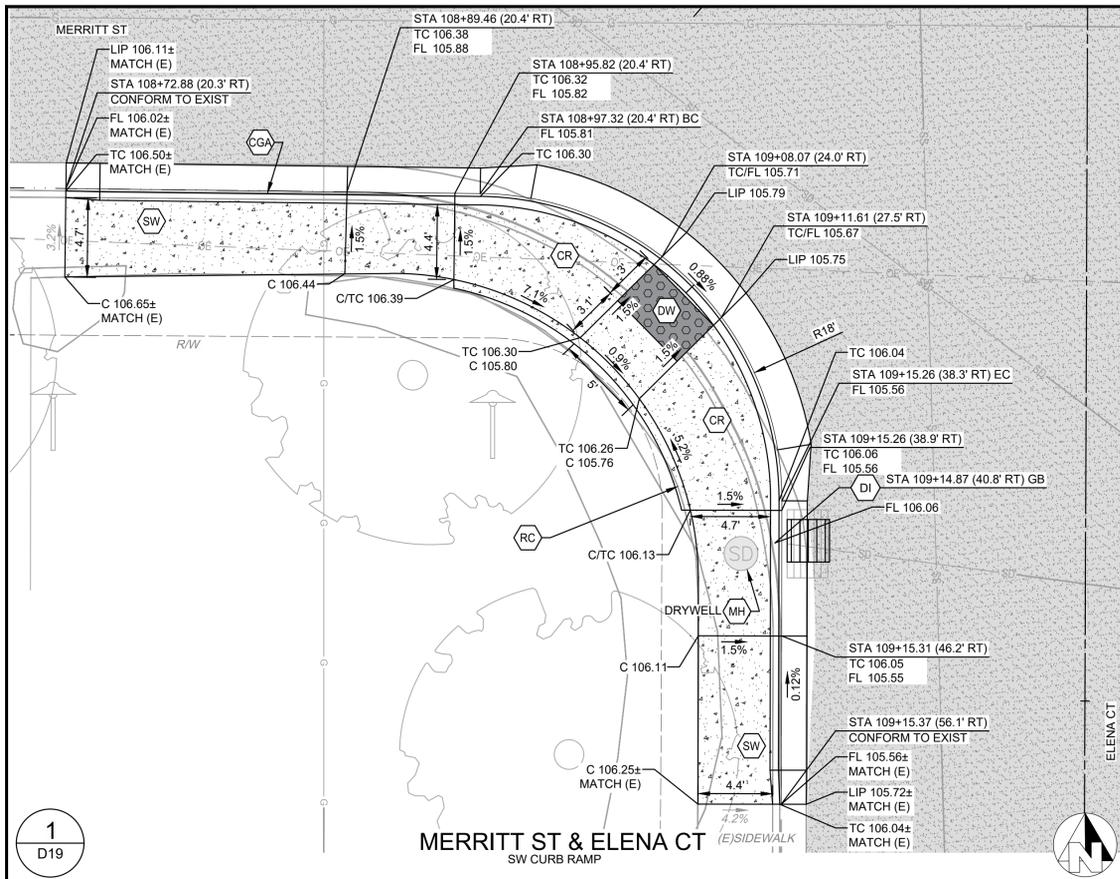


3  
D18

MERRITT ST & VILLA CT (EAST)  
NW & NE CURB RAMP

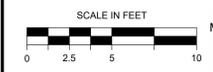

CITY OF TURLOCK  
MUNICIPAL SERVICES DEPARTMENT  
ROADS PROGRAM DIVISION  
156 S. BROADWAY, SUITE 150  
(209) 668-5520



CONSTRUCTION CALLOUTS	
SYM	DESCRIPTION
AA	ALLEY APPROACH PER CITY OF TURLOCK STD DWG C-7
AG	ADJUST TO FINISHED GRADE
CGA	SAWCUT AND REMOVE (E) CURB AND GUTTER AND CONSTRUCT NEW CURB AND GUTTER PER CITY OF TURLOCK STD DWG C-1. DOWEL INTO EXISTING CURB AND GUTTER PER DETAIL 1, SHEET D5
CG	CONSTRUCT NEW CURB AND GUTTER PER CITY OF TURLOCK STD DWG C-1. DOWEL INTO EXISTING CURB AND GUTTER PER DETAIL 1, SHEET D5
CR	SAWCUT AND REMOVE (E) CURB RETURN, RAMPS, AND SIDEWALK AND CONSTRUCT NEW CURB RETURN, RAMP, AND SIDEWALK PER PROJECT SPECIFICATIONS AND SITE DETAILS
DA	RESIDENTIAL DRIVE APPROACH PER CITY OF TURLOCK STD DWG C-5
DA1	REMOVE AND REPLACE EXISTING DRIVE APPROACH TO MATCH AT EXISTING CONCRETE HINGE POINT PER CITY OF TURLOCK STD DWG C-5
DI	REMOVE AND REPLACE CATCH BASIN PER CITY OF TURLOCK STD SD-3 AND T-1
DOC	SAWCUT AND REMOVE (E) CURB AND GUTTER AND CONSTRUCT NEW DRIVE OVER CURB PER CITY OF TURLOCK PER DETAIL 3 ON SHEET D4. DOWEL INTO EXISTING CURB AND GUTTER PER DETAIL 1, SHEET D5
DW	DETECTABLE WARNING SURFACE PER CALTRANS STD DWG SHEET A88A
FH	CONSTRUCT FIRE HYDRANT PER CITY OF TURLOCK STD DWG W-1 AND T-1
MH	ADJUST MANHOLE TO FINISHED GRADE AFTER PAVING OPERATIONS PER DETAIL S-3
NDI	CONSTRUCT CATCH BASIN PER CITY OF TURLOCK STD SD-3 AND T-1
NMH	CONSTRUCT NEW MANHOLE PER CITY OF TURLOCK STD DWG S-3 AND T-1
PP	PROTECT IN PLACE
RC	RETAINING CURB
RD1	REMOVE DRAINAGE INLET
RL	REMOVE AND RELOCATE
SW	CONSTRUCT SIDEWALK PER CITY OF TURLOCK STD DWG C-3. PROVIDE 2' SIDEWALK TRANSITION WITHIN LIMITS SHOWN TO MATCH (E) ELEVATIONS. SLOPES WITHIN TRANSITION AREA SHALL NOT EXCEED 4.5% LONGITUDINALLY. DOWEL INTO EXISTING SIDEWALK PER DETAIL 1, SHEET D5. PROTECT (E) ROOF DRAINS IN PLACE OR REPLACE IN KIND
VG	CONSTRUCT VALLEY GUTTER PER CITY OF TURLOCK STD DWG C-1

LEGEND	
[Pattern]	FDR-C RECONSTRUCTION PER DETAIL 2 SHEET D5
[Pattern]	6.0" TYPE A HMA PAVEMENT PLUG OVER
[Pattern]	6" CNS COMPACTED TO 95%
[Pattern]	3.5" MINIMUM THICK CONCRETE OVER
[Pattern]	6" CNS COMPACTED TO 90%
[Pattern]	ALLEY/DRIVE APPROACH CONCRETE THICKNESS PER CITY OF TURLOCK STD DWG C-5, C-7 & C-8
[Pattern]	8.0" TYPE A HMA PAVEMENT OVER
[Pattern]	6" CNS COMPACTED TO 95%

- CONSTRUCTION NOTES**
- EXISTING DRIVEWAYS, CURB, AND GUTTER TO REMAIN UNLESS OTHERWISE NOTED ON THE PLANS.
  - STATION AND OFFSET ON CURB AND GUTTER REFERS TO A POINT ON THE FLOWLINE.
  - DETAILED RAMP AND DRIVE APPROACH GRADING IS PROVIDED ON SHEETS D7-D22.
  - PROTECT IN PLACE ALL (E) SIDEWALK DRAINS.
  - NOT ALL SEWER LATERALS ARE SHOWN ON THE PLANS.




BID SET  
 1/22/2026  
 CITY OF TURLOCK  
 ROADS PROGRAM CIP  
 CITY PROJECT No. 23-068, PACKAGE 3  
 DETAILS  
 SITE DETAILS


NO.	REVISION	DATE

DESIGN ENGINEER: JEFF DORN  
 LICENSE NO: 76,749  
 DRAFTED BY: AR  
 CHECKED BY: JD  
 DATE: JAN 2026  
 JOB NO: 229224001  
 PROJECT NO: 229224001  
 PHASE: 3  
 ORIGINAL SCALE SHOWN IS ONE INCH. ADJUST SCALE FOR REDUCED OR ENLARGED PLANS.  
 SHEET **D19**  
 43 OF 78


CITY OF TURLOCK  
 MUNICIPAL SERVICES DEPARTMENT  
 ROADS PROGRAM DIVISION  
 156 S. BROADWAY, SUITE 150  
 (209) 668-5520

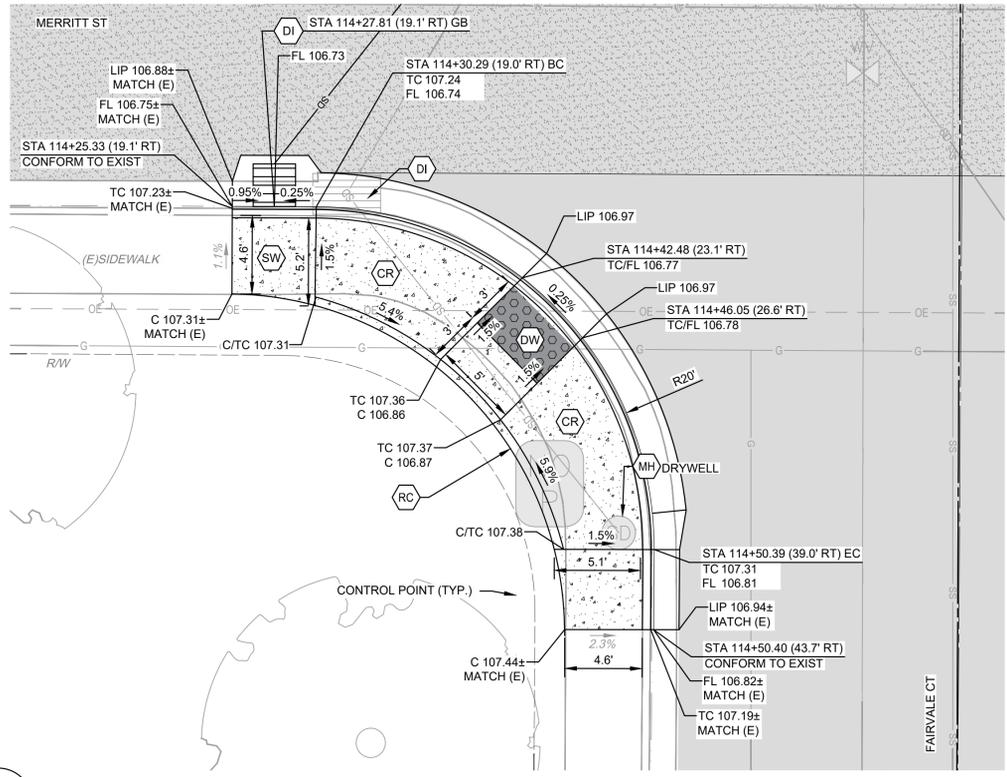


**MERRITT ST & FAIRVALE CT**  
SW CURB RAMP

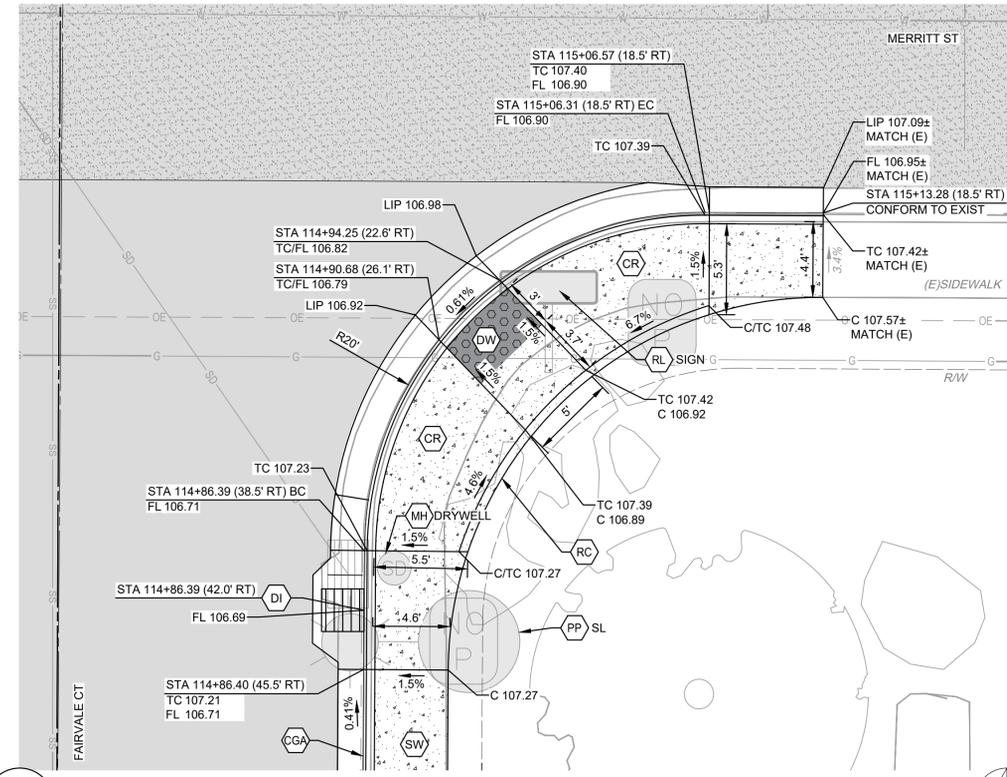


**MERRITT ST & FAIRVALE CT**  
SE CURB RAMP

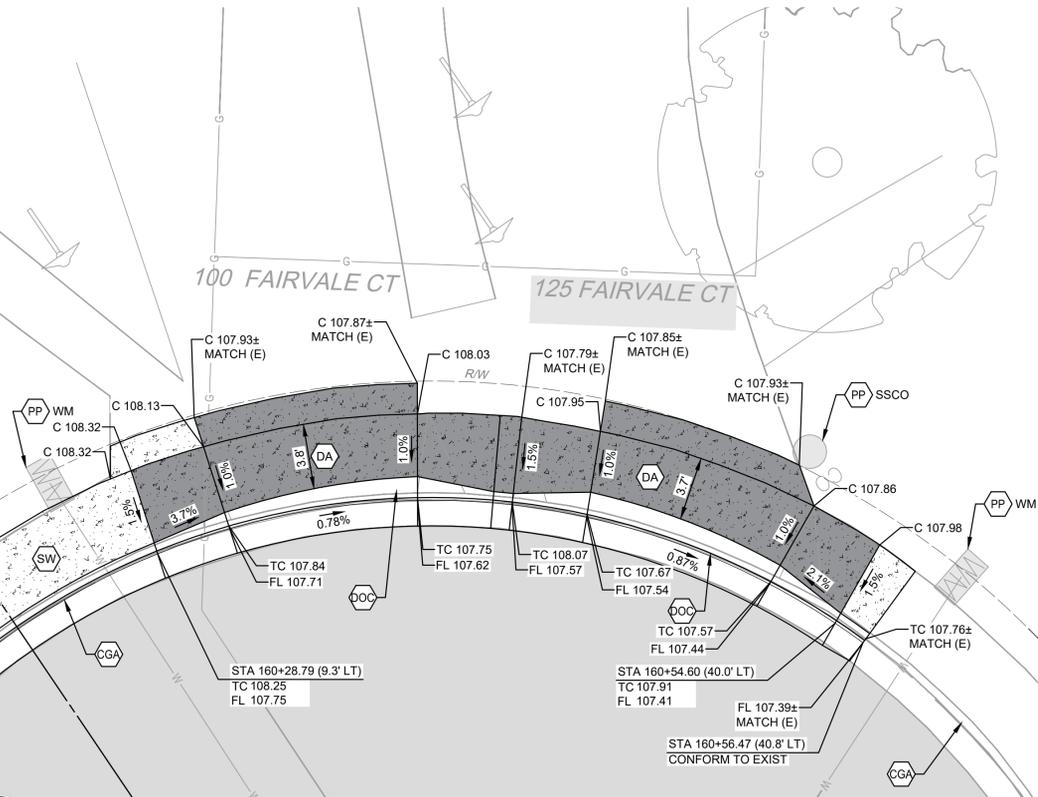

**FAIRVALE CT**  
DRIVEWAY APPROACH

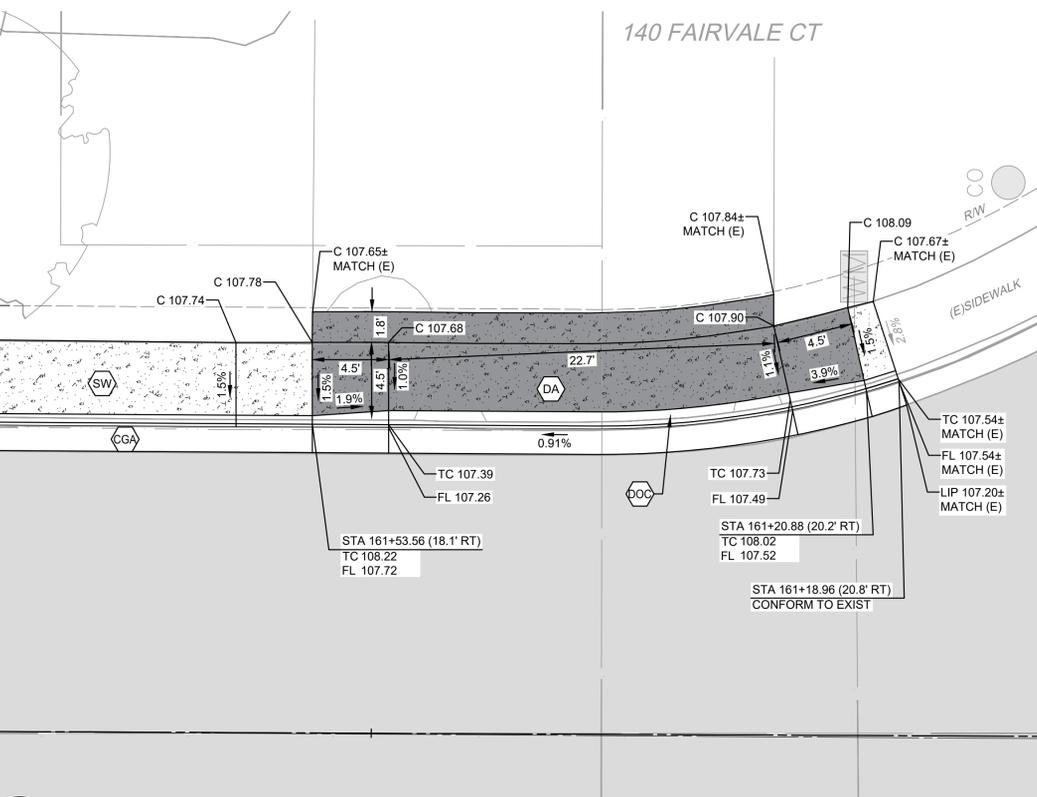

**FAIRVALE CT**  
DRIVEWAY APPROACH

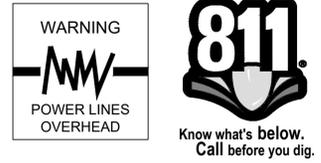

CONSTRUCTION CALLOUTS	
SYM	DESCRIPTION
AA	ALLEY APPROACH PER CITY OF TURLOCK STD DWG C-7
AG	ADJUST TO FINISHED GRADE
CGA	SAWCUT AND REMOVE (E) CURB AND GUTTER AND CONSTRUCT NEW CURB AND GUTTER PER CITY OF TURLOCK STD DWG C-1. DOWEL INTO EXISTING CURB AND GUTTER PER DETAIL 1, SHEET D5
CG	CONSTRUCT NEW CURB AND GUTTER PER CITY OF TURLOCK STD DWG C-1. DOWEL INTO EXISTING CURB AND GUTTER PER DETAIL 1, SHEET D5
CR	SAWCUT AND REMOVE (E) CURB RETURN, RAMPS, AND SIDEWALK AND CONSTRUCT NEW CURB RETURN, RAMP, AND SIDEWALK PER PROJECT SPECIFICATIONS AND SITE DETAILS
DA	RESIDENTIAL DRIVE APPROACH PER CITY OF TURLOCK STD DWG C-5
DA1	REMOVE AND REPLACE EXISTING DRIVE APPROACH TO MATCH AT EXISTING CONCRETE HINGE POINT PER CITY OF TURLOCK STD DWG C-5
DI	REMOVE AND REPLACE CATCH BASIN PER CITY OF TURLOCK STD SD-3 AND T-1
DOC	SAWCUT AND REMOVE (E) CURB AND GUTTER AND CONSTRUCT NEW DRIVE OVER CURB PER CITY OF TURLOCK PER DETAIL 3 ON SHEET D4. DOWEL INTO EXISTING CURB AND GUTTER PER DETAIL 1, SHEET D5
DW	DETECTABLE WARNING SURFACE PER CALTRANS STD DWG SHEET A88A
FH	CONSTRUCT FIRE HYDRANT PER CITY OF TURLOCK STD DWG W-1 AND T-1
MH	ADJUST MANHOLE TO FINISHED GRADE AFTER PAVING OPERATIONS PER DETAIL S-3
NDI	CONSTRUCT CATCH BASIN PER CITY OF TURLOCK STD SD-3 AND T-1
NMH	CONSTRUCT NEW MANHOLE PER CITY OF TURLOCK STD DWG S-3 AND T-1
PP	PROTECT IN PLACE
RC	RETAINING CURB
RD1	REMOVE DRAINAGE INLET
RL	REMOVE AND RELOCATE
SW	CONSTRUCT SIDEWALK PER CITY OF TURLOCK STD DWG C-3. PROVIDE 2' SIDEWALK TRANSITION WITHIN LIMITS SHOWN TO MATCH (E) ELEVATIONS. SLOPES WITHIN TRANSITION AREA SHALL NOT EXCEED 4.5% LONGITUDINALLY. DOWEL INTO EXISTING SIDEWALK PER DETAIL 1, SHEET D5. PROTECT (E) ROOF DRAINS IN PLACE OR REPLACE IN KIND
VG	CONSTRUCT VALLEY GUTTER PER CITY OF TURLOCK STD DWG C-1


**LEGEND**

- FDR-C RECONSTRUCTION PER DETAIL 2 SHEET D5
- 6.0" TYPE A HMA PAVEMENT PLUG OVER
- 6" CNS COMPACTED TO 95%
- 3.5" MINIMUM THICK CONCRETE OVER
- 6" CNS COMPACTED TO 90%
- ALLEY/DRIVE APPROACH CONCRETE THICKNESS PER CITY OF TURLOCK STD DWG C-5, C-7 & C-8
- 8.0" TYPE A HMA PAVEMENT OVER
- 6" CNS COMPACTED TO 95%

- CONSTRUCTION NOTES**
- EXISTING DRIVEWAYS, CURB, AND GUTTER TO REMAIN UNLESS OTHERWISE NOTED ON THE PLANS.
  - STATION AND OFFSET ON CURB AND GUTTER REFERS TO A POINT ON THE FLOWLINE.
  - DETAILED RAMP AND DRIVE APPROACH GRADING IS PROVIDED ON SHEETS D7-D22.
  - PROTECT IN PLACE ALL (E) SIDEWALK DRAINS.
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1/22/2026



**CITY OF TURLOCK**  
ROADS PROGRAM CIP  
CITY PROJECT No. 23-068, PACKAGE 3  
DETAILS  
**SITE DETAILS**

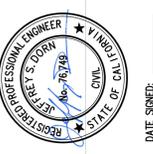**PROVOST & PRITCHARD**  
425 W. FIR AVENUE  
TURLOCK, CA 95259  
PHONE (530) 449-2700  
FAX (530) 449-2715  
www.provostandpritchard.com

DESIGN ENGINEER:  
JEFF DORN  
LICENSE NO:  
76,749

DRAFTED BY: AR  
CHECKED BY: JD

DATE: JAN 2026  
JOB NO: 229224001

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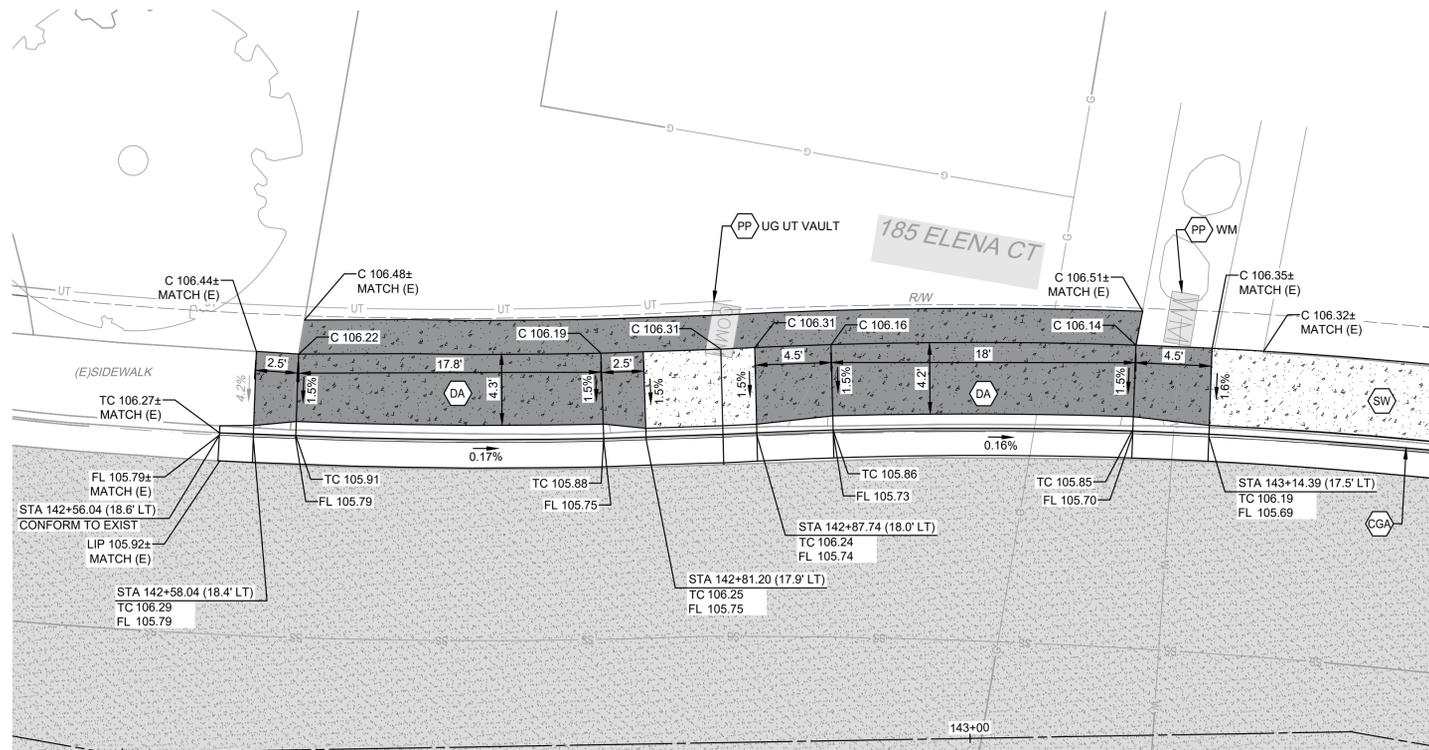
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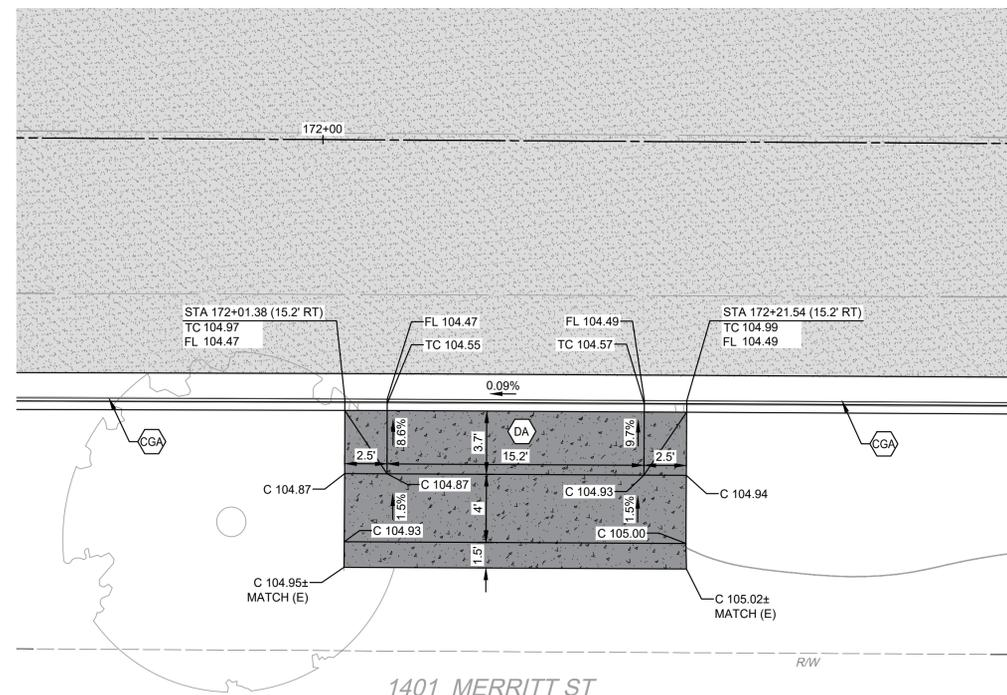
SHEET **D20**  
44 OF 78




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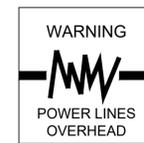
**ELENA CT**  
DRIVEWAY APPROACH



**BELL ST**  
DRIVEWAY APPROACH



**BELL ST**  
DRIVEWAY APPROACH

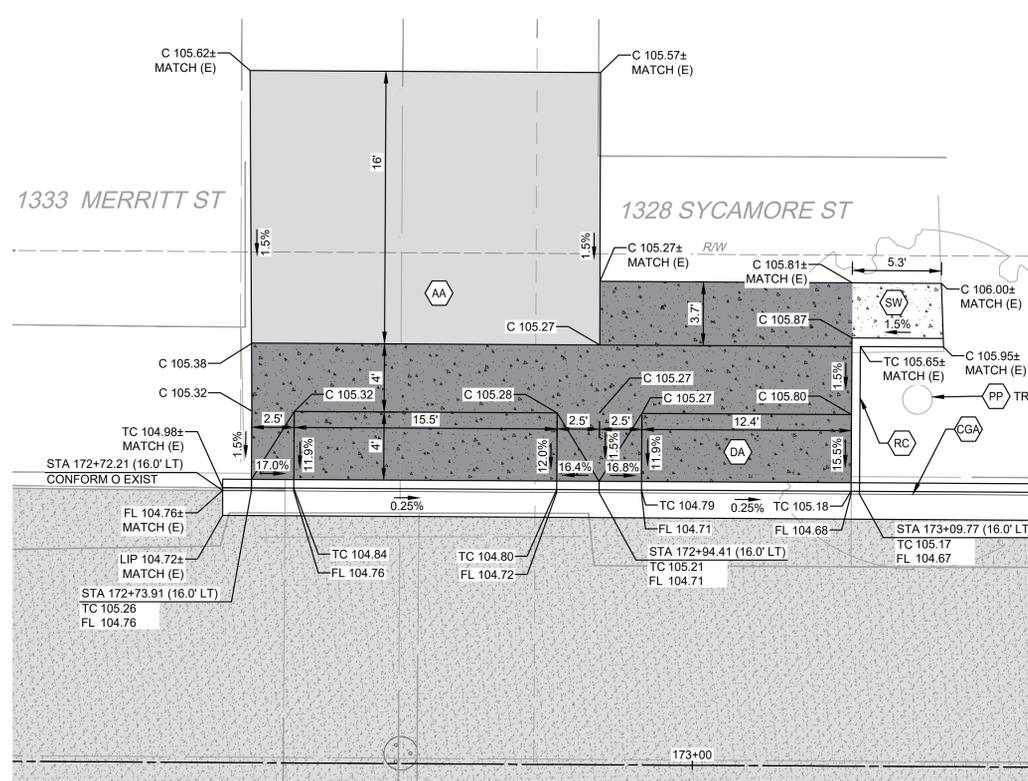

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CONSTRUCTION CALLOUTS	
SYM	DESCRIPTION
AA	ALLEY APPROACH PER CITY OF TURLOCK STD DWG C-7
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CGA	SAWCUT AND REMOVE (E) CURB AND GUTTER AND CONSTRUCT NEW CURB AND GUTTER PER CITY OF TURLOCK STD DWG C-1. DOWEL INTO EXISTING CURB AND GUTTER PER DETAIL 1, SHEET D5
CG	CONSTRUCT NEW CURB AND GUTTER PER CITY OF TURLOCK STD DWG C-1. DOWEL INTO EXISTING CURB AND GUTTER PER DETAIL 1, SHEET D5
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MH	ADJUST MANHOLE TO FINISHED GRADE AFTER PAVING OPERATIONS PER DETAIL S-3
NDI	CONSTRUCT CATCH BASIN PER CITY OF TURLOCK STD SD-3 AND T-1
NMH	CONSTRUCT NEW MANHOLE PER CITY OF TURLOCK STD DWG S-3 AND T-1
PP	PROTECT IN PLACE
RC	RETAINING CURB
RD	REMOVE DRAINAGE INLET
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SW	CONSTRUCT SIDEWALK PER CITY OF TURLOCK STD DWG C-3. PROVIDE 2' SIDEWALK TRANSITION WITHIN LIMITS SHOWN TO MATCH (E) ELEVATIONS. SLOPES WITHIN TRANSITION AREA SHALL NOT EXCEED 4.5% LONGITUDINALLY. DOWEL INTO EXISTING SIDEWALK PER DETAIL 1, SHEET D5. PROTECT (E) ROOF DRAINS IN PLACE OR REPLACE IN KIND
VG	CONSTRUCT VALLEY GUTTER PER CITY OF TURLOCK STD DWG C-1

LEGEND	
[Pattern]	FDR-C RECONSTRUCTION PER DETAIL 2 SHEET D5
[Pattern]	6.0" TYPE A HMA PAVEMENT PLUG OVER 6" CNS COMPACTED TO 95%
[Pattern]	3.5" MINIMUM THICK CONCRETE OVER 6" CNS COMPACTED TO 90%
[Pattern]	ALLEY/DRIVE APPROACH CONCRETE THICKNESS PER CITY OF TURLOCK STD DWG C-5, C-7 & C-8
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**BID SET**  
1/22/2026



**CITY OF TURLOCK**  
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PHASE: 3


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SHEET **D21**


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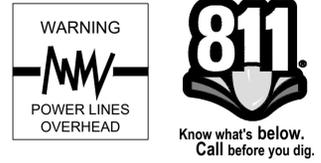
CITY OF TURLOCK  
MUNICIPAL SERVICES DEPARTMENT  
ROADS PROGRAM DIVISION  
156 S. BROADWAY, SUITE 150  
(209) 668-5520



**BELL STREET**  
ALLEY APPROACH AND DRIVE APPROACH

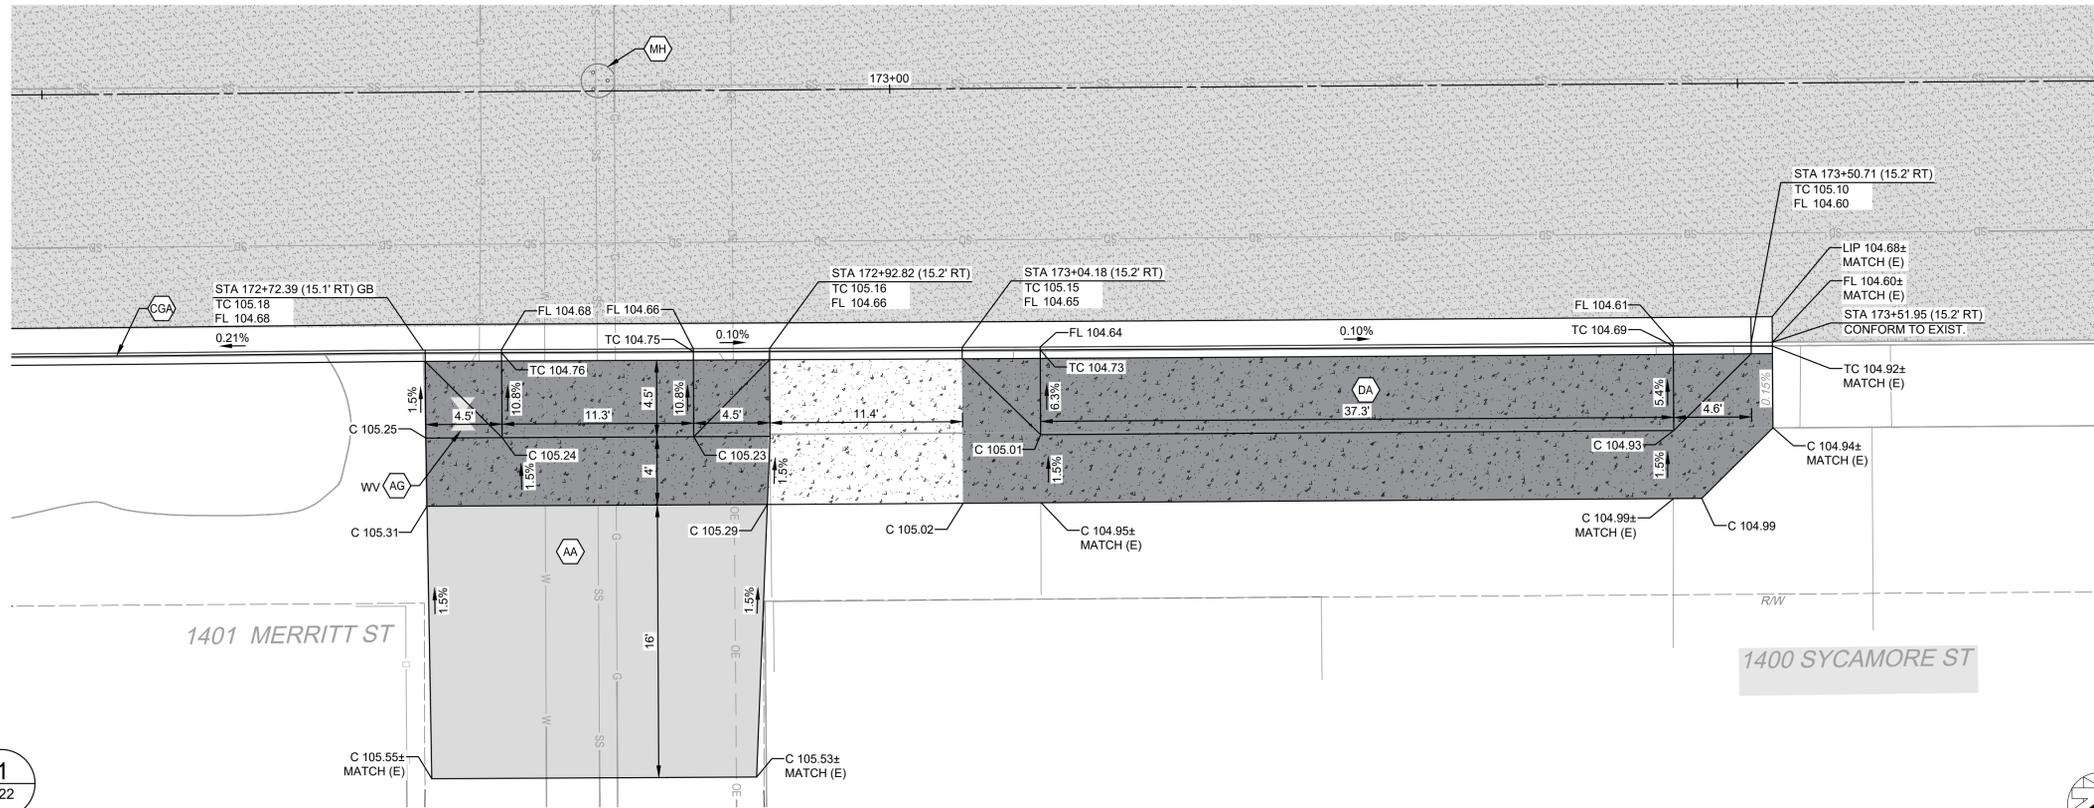


**MARSHALL STREET & BERKELEY AVE**  
SW CURB RAMP

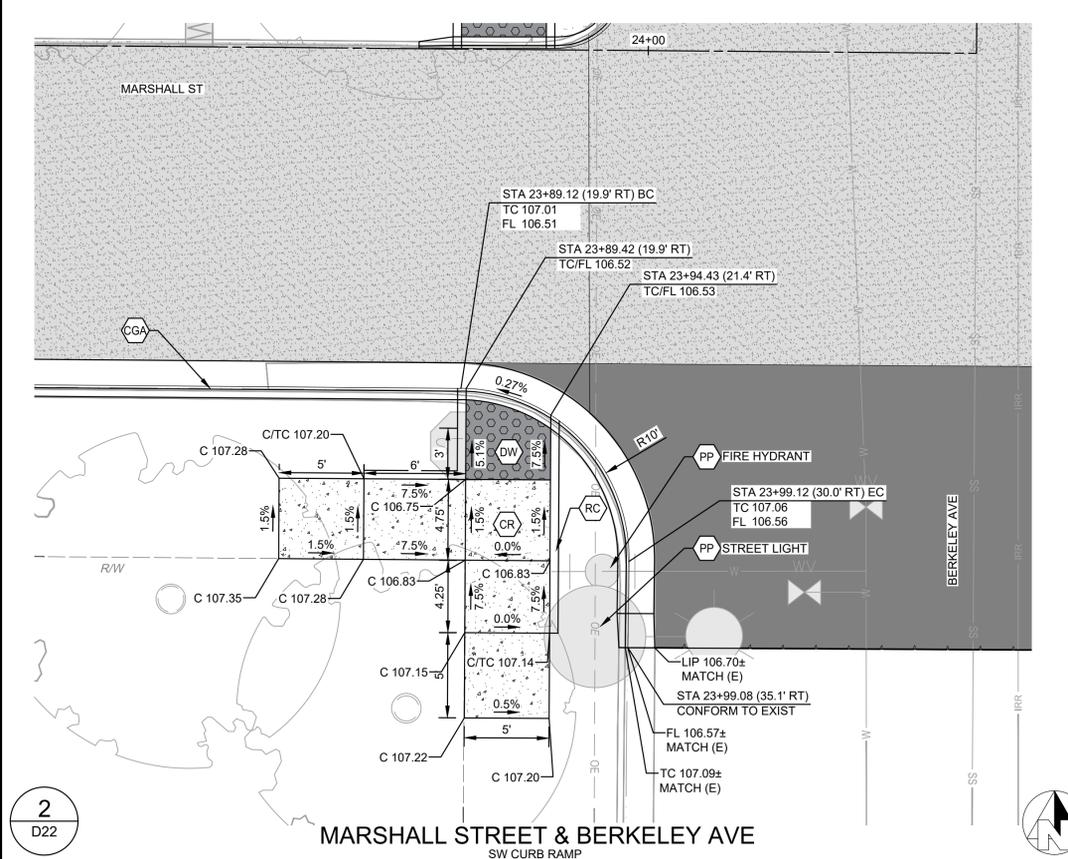

CONSTRUCTION CALLOUTS	
SYM	DESCRIPTION
AA	ALLEY APPROACH PER CITY OF TURLOCK STD DWG C-7
AG	ADJUST TO FINISHED GRADE
CGA	SAWCUT AND REMOVE (E) CURB AND GUTTER AND CONSTRUCT NEW CURB AND GUTTER PER CITY OF TURLOCK STD DWG C-1. DOWEL INTO EXISTING CURB AND GUTTER PER DETAIL 1, SHEET D5
CG	CONSTRUCT NEW CURB AND GUTTER PER CITY OF TURLOCK STD DWG C-1. DOWEL INTO EXISTING CURB AND GUTTER PER DETAIL 1, SHEET D5
CR	SAWCUT AND REMOVE (E) CURB RETURN, RAMPS, AND SIDEWALK AND CONSTRUCT NEW CURB RETURN, RAMP, AND SIDEWALK PER PROJECT SPECIFICATIONS AND SITE DETAILS
DA	RESIDENTIAL DRIVE APPROACH PER CITY OF TURLOCK STD DWG C-5
DA1	REMOVE AND REPLACE EXISTING DRIVE APPROACH TO MATCH AT EXISTING CONCRETE HINGE POINT PER CITY OF TURLOCK STD DWG C-5
DI	REMOVE AND REPLACE CATCH BASIN PER CITY OF TURLOCK STD SD-3 AND T-1
DOC	SAWCUT AND REMOVE (E) CURB AND GUTTER AND CONSTRUCT NEW DRIVE OVER CURB PER CITY OF TURLOCK PER DETAIL 3 ON SHEET D4. DOWEL INTO EXISTING CURB AND GUTTER PER DETAIL 1, SHEET D5
DW	DETECTABLE WARNING SURFACE PER CALTRANS STD DWG SHEET A88A
FH	CONSTRUCT FIRE HYDRANT PER CITY OF TURLOCK STD DWG W-1 AND T-1
MH	ADJUST MANHOLE TO FINISHED GRADE AFTER PAVING OPERATIONS PER DETAIL S-3
NDI	CONSTRUCT CATCH BASIN PER CITY OF TURLOCK STD SD-3 AND T-1
NMH	CONSTRUCT NEW MANHOLE PER CITY OF TURLOCK STD DWG S-3 AND T-1
PP	PROTECT IN PLACE
RC	RETAINING CURB
RD	REMOVE DRAINAGE INLET
RL	REMOVE AND RELOCATE
SW	CONSTRUCT SIDEWALK PER CITY OF TURLOCK STD DWG C-3. PROVIDE 2' SIDEWALK TRANSITION WITHIN LIMITS SHOWN TO MATCH (E) ELEVATIONS. SLOPES WITHIN TRANSITION AREA SHALL NOT EXCEED 4.5% LONGITUDINALLY. DOWEL INTO EXISTING SIDEWALK PER DETAIL 1, SHEET D5. PROTECT (E) ROOF DRAINS IN PLACE OR REPLACE IN KIND
VG	CONSTRUCT VALLEY GUTTER PER CITY OF TURLOCK STD DWG C-1

LEGEND	
	FDR-C RECONSTRUCTION PER DETAIL 2 SHEET D5
	6.0" TYPE A HMA PAVEMENT PLUG OVER 6" CNS COMPACTED TO 95%
	3.5" MINIMUM THICK CONCRETE OVER 6" CNS COMPACTED TO 90%
	ALLEY/DRIVE APPROACH CONCRETE THICKNESS PER CITY OF TURLOCK STD DWG C-5, C-7 & C-8
	8.0" TYPE A HMA PAVEMENT OVER 6" CNS COMPACTED TO 95%

- CONSTRUCTION NOTES**
- EXISTING DRIVEWAYS, CURB, AND GUTTER TO REMAIN UNLESS OTHERWISE NOTED ON THE PLANS.
  - STATION AND OFFSET ON CURB AND GUTTER REFERS TO A POINT ON THE FLOWLINE.
  - DETAILED RAMP AND DRIVE APPROACH GRADING IS PROVIDED ON SHEETS D7-D22.
  - PROTECT IN PLACE ALL (E) SIDEWALK DRAINS.
  - NOT ALL SEWER LATERALS ARE SHOWN ON THE PLANS.

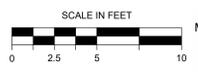

CITY OF TURLOCK  
MUNICIPAL SERVICES DEPARTMENT  
ROADS PROGRAM DIVISION  
156 S. BROADWAY, SUITE 150  
(209) 668-5520

**BID SET**  
1/22/2026

CITY OF TURLOCK  
ROADS PROGRAM CIP  
CITY PROJECT No. 23-068, PACKAGE 3  
DETAILS  
SITE DETAILS

DESIGN ENGINEER:  
JEFF DORN  
LICENSE NO:  
76,749

DRAFTED BY: AR  
CHECKED BY: JD


DATE: JAN 2026  
JOB NO: 229224001  
PROJECT NO: 229224001  
PHASE: 3

ORIGINAL SCALE SHOWN IS ONE INCH. ADJUST SCALE FOR REDUCED OR ENLARGED PLANS.

SHEET **D22**  
46 OF 78


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TURLOCK, CA 95259  
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1/19/2026 9:20 AM G:\Turlock\_City of 229224001\2024 Road Rehab\300 CAD\343 Sheet Set\04\_Civil\_Details\02 SITE DETAILS.dwg -Annemarie Fox

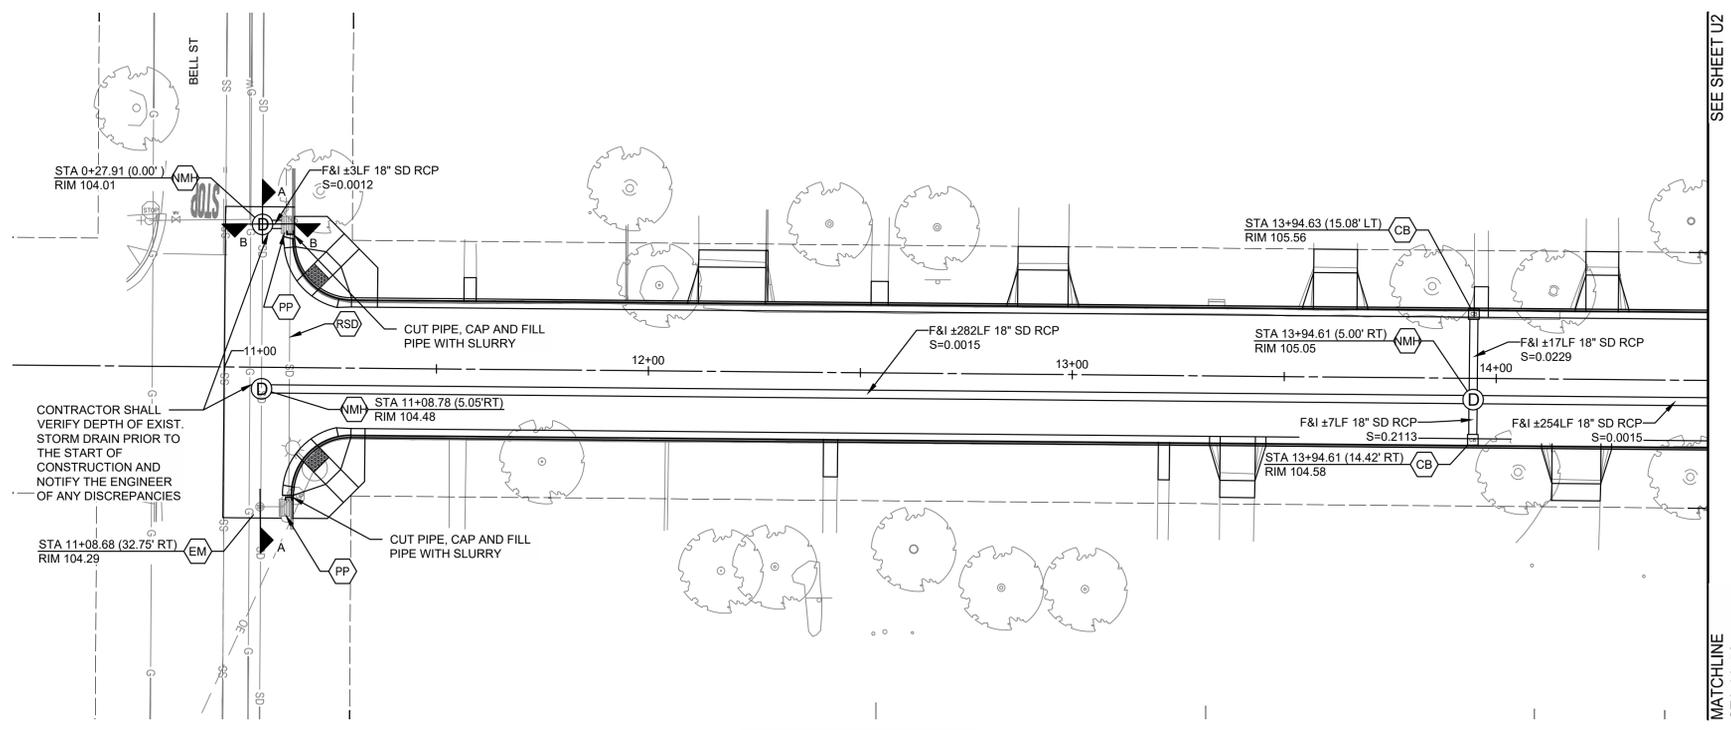


**MARSHALL AVENUE**  
STATIONING ALONG CENTER OF RW


SEE SHEET U2  
MATCHLINE  
STA 14+50

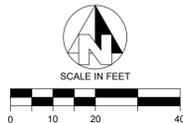


CONSTRUCTION CALLOUTS	
SYMBOL	DESCRIPTION
(AB)	ABANDON PIPE IN PLACE
(DI)	REMOVE AND REPLACE CATCH BASIN PER CITY OF TURLOCK STD SD-3
(CB)	CONSTRUCT CATCH BASIN PER CITY OF TURLOCK STD SD-3
(EM)	ADJUST EXISTING MANHOLE TO FINISHED GRADE AFTER PAVING OPERATIONS PER DETAIL
(NMH)	CONSTRUCT MANHOLE PER CITY OF TURLOCK STD S-3
(PP)	PROTECT IN PLACE
(RSD)	REMOVE EXISTING SD LINE

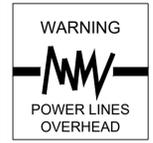


NOTE:  
STORM DRAIN PIPELINES SHALL BE LOW PRESSURE AIR TESTED PER SECTION 16-30 OF THE CITY STANDARD SPECIFICATIONS.

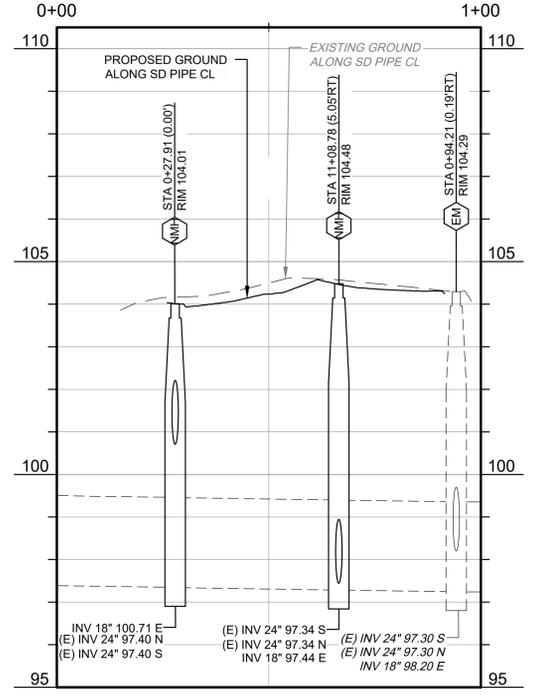

STORM DRAIN ALONG CENTERLINE (A-A)

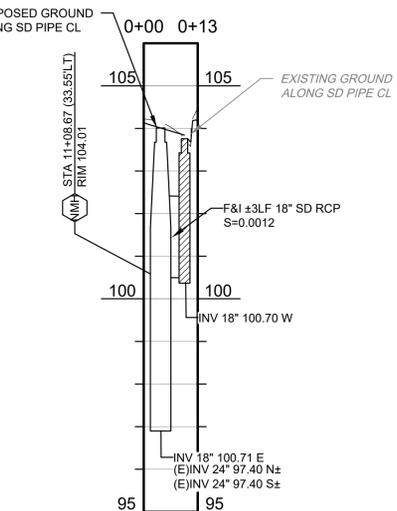

STORM DRAIN ALONG CENTERLINE (B-B)

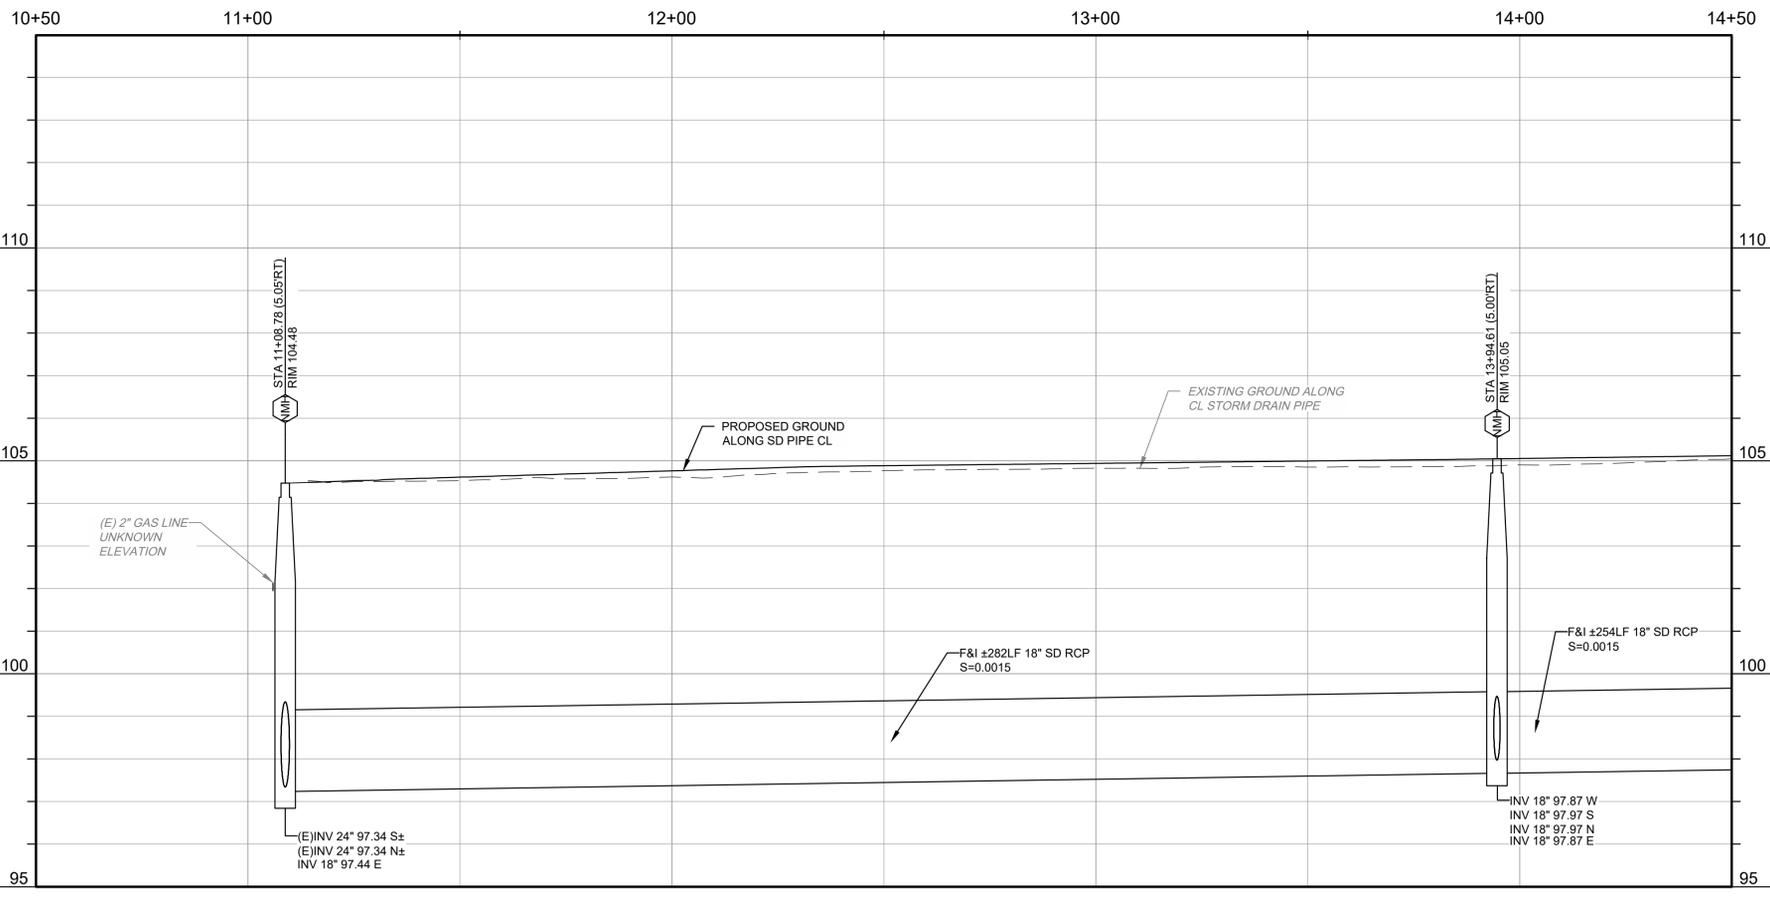

**BID SET**  
1/22/2026

CITY OF TURLOCK  
ROADS PROGRAM CIP  
CITY PROJECT No. 23-068, PACKAGE 3  
STORM DRAIN  
MARSHALL ST

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TURLOCK, CA 95259  
PHONE (559) 448-2700  
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DESIGN ENGINEER:  
JEFF DORN  
LICENSE NO:  
76,749

DRAFTED BY: AR  
CHECKED BY: JD

DATE: JAN 2026  
JOB NO: 229224001  
PROJECT NO: 229224001  
PHASE: 3

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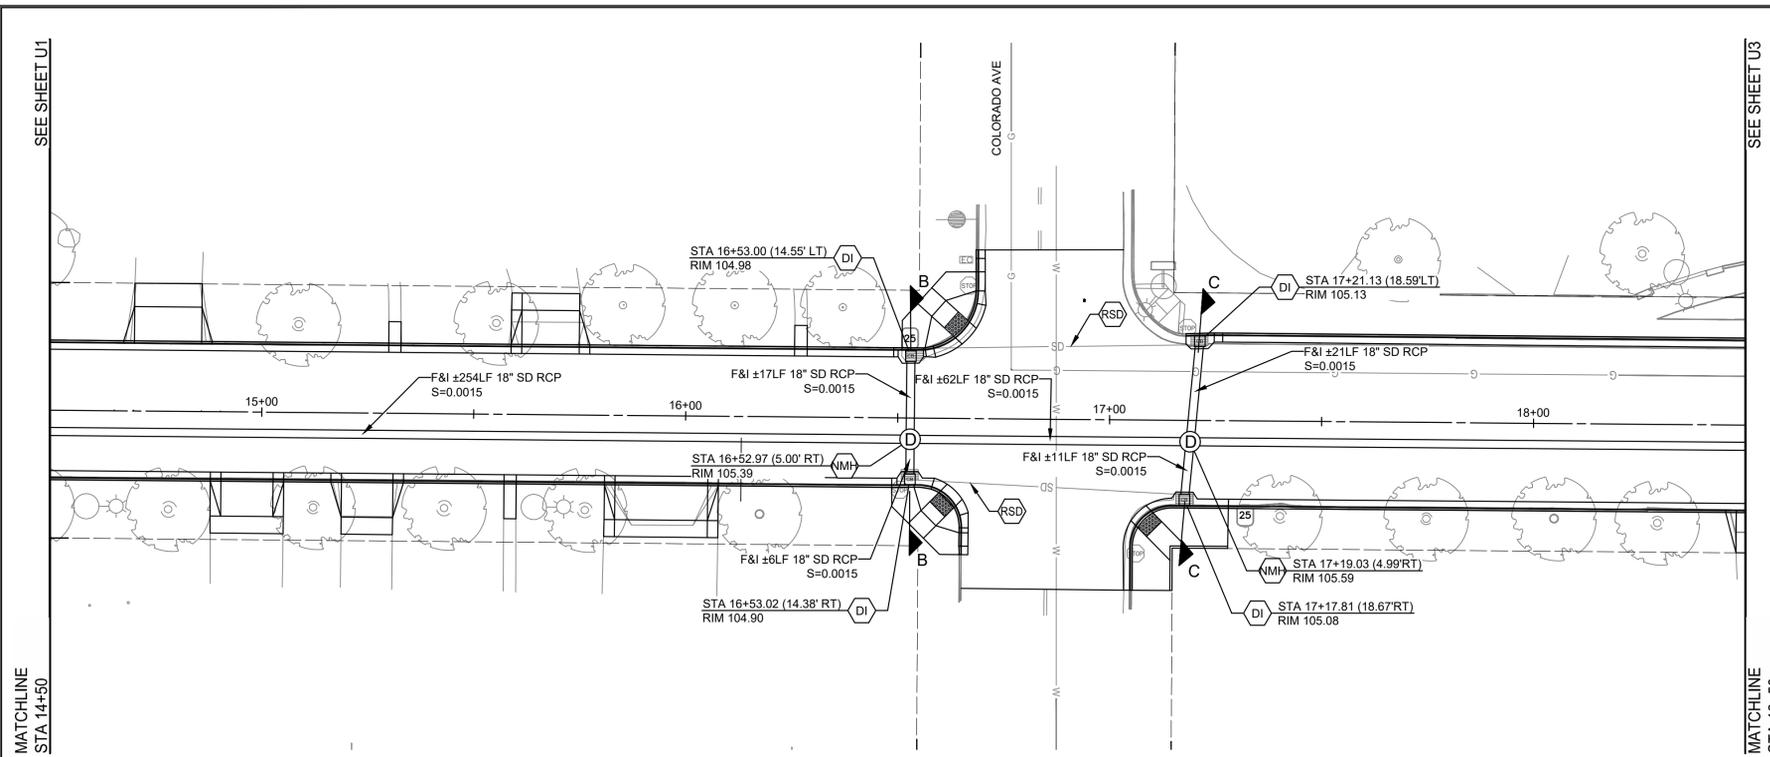
SHEET **U1**  
47 OF 78

DATE SIGNED: \_\_\_\_\_  
REVISION: \_\_\_\_\_  
BY: \_\_\_\_\_  
DATE: \_\_\_\_\_






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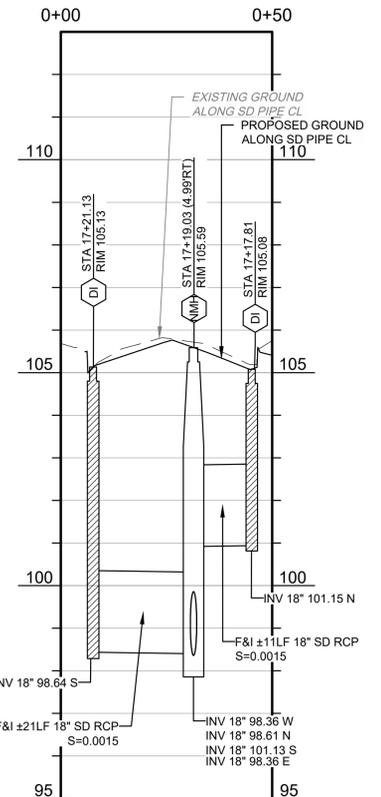
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**MARSHALL AVENUE**  
STATIONING ALONG CENTER OF RW




**STORM DRAIN CENTERLINE (B-B)**

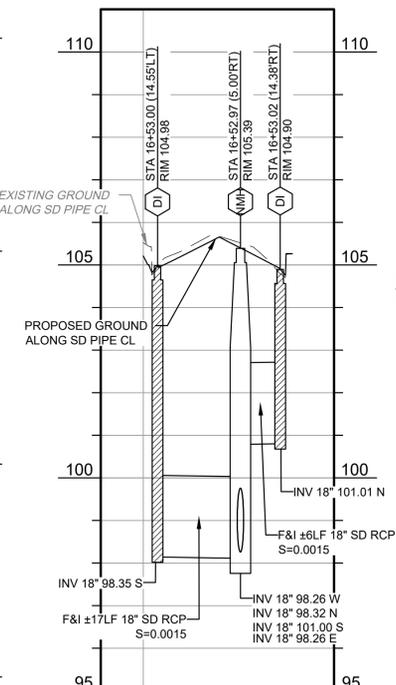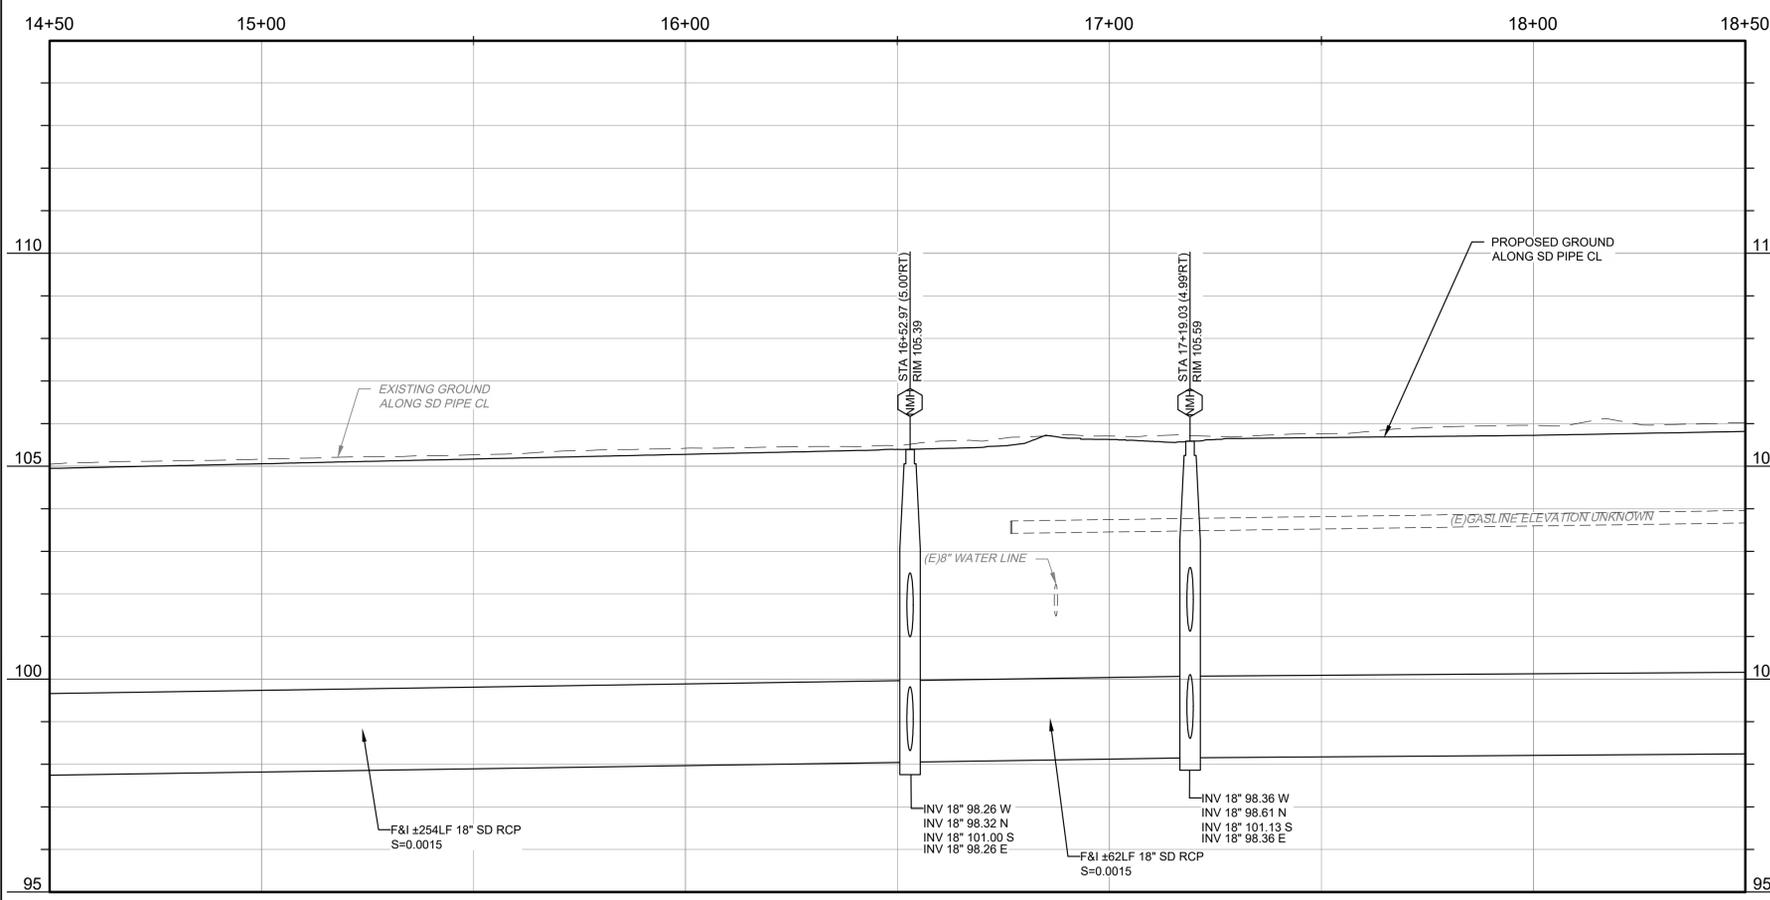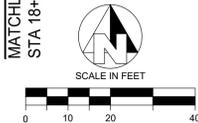

**STORM DRAIN CENTERLINE (C-C)**


CONSTRUCTION CALLOUTS	
SYMBOL	DESCRIPTION
(AB)	ABANDON PIPE IN PLACE
(DI)	REMOVE AND REPLACE CATCH BASIN PER CITY OF TURLOCK STD SD-3
(CB)	CONSTRUCT CATCH BASIN PER CITY OF TURLOCK STD SD-3
(EM)	ADJUST EXISTING MANHOLE TO FINISHED GRADE AFTER PAVING OPERATIONS PER DETAIL
(MH)	CONSTRUCT MANHOLE PER CITY OF TURLOCK STD S-3
(RP)	REMOVE PIPE
(SD)	REMOVE EXISTING SD LINE

NOTE:  
STORM DRAIN PIPELINES SHALL BE LOW PRESSURE AIR TESTED PER SECTION 16-30 OF THE CITY STANDARD SPECIFICATIONS.

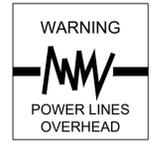

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1/22/2026

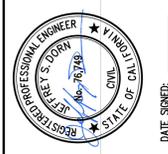

**CITY OF TURLOCK**  
ROADS PROGRAM CIP  
CITY PROJECT No. 23-068, PACKAGE 3  
STORM DRAIN  
MARSHALL ST

**PROVOST & PRITCHARD**  
425 W. FIR AVENUE  
TURLOCK, CA 95259  
PHONE (559) 449-2700  
FAX (559) 449-2715  
www.provostandpritchard.com

DESIGN ENGINEER:  
JEFF DORN  
LICENSE NO:  
76,749  
DRAFTED BY: AR  
CHECKED BY: JD  
DATE: JAN 2026  
JOB NO: 229224001  
PROJECT NO: 229224001  
PHASE: 3




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ROADS PROGRAM DIVISION  
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SHEET **U2**  
48 OF 78




SEE SHEET U2

SEE SHEET U5



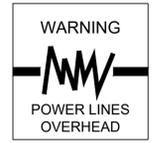


CONSTRUCTION CALLOUTS	
SYMBOL	DESCRIPTION
(DI)	REMOVE AND REPLACE CATCH BASIN PER CITY OF TURLOCK STD SD-3
(CB)	CONSTRUCT CATCH BASIN PER CITY OF TURLOCK STD SD-3
(EM)	ADJUST EXISTING MANHOLE TO FINISHED GRADE AFTER PAVING OPERATIONS PER DETAIL
(NMH)	CONSTRUCT MANHOLE PER CITY OF TURLOCK STD S-3
(RP)	REMOVE PIPE

NOTE:  
STORM DRAIN PIPELINES SHALL BE LOW PRESSURE AIR TESTED PER SECTION 16-30 OF THE CITY STANDARD SPECIFICATIONS.

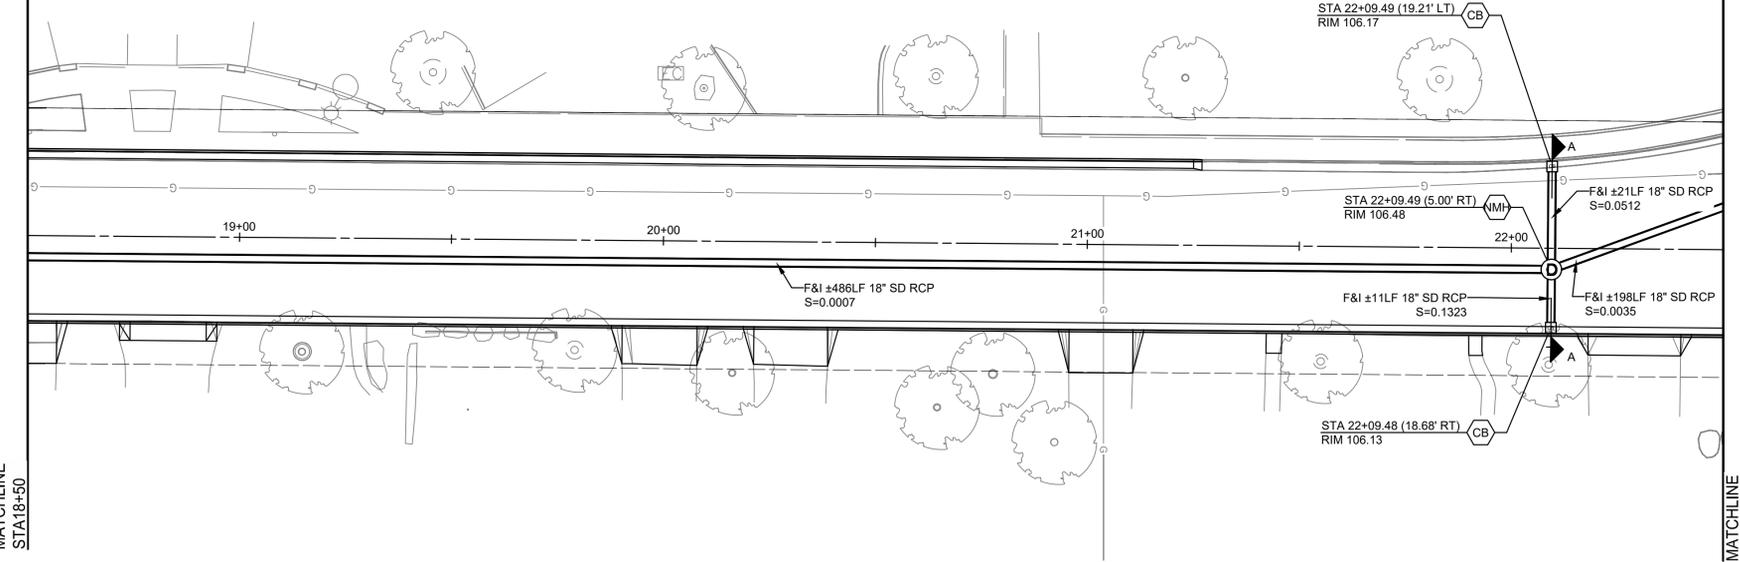


**MARSHALL AVENUE**  
STATIONING ALONG CENTER OF R/W

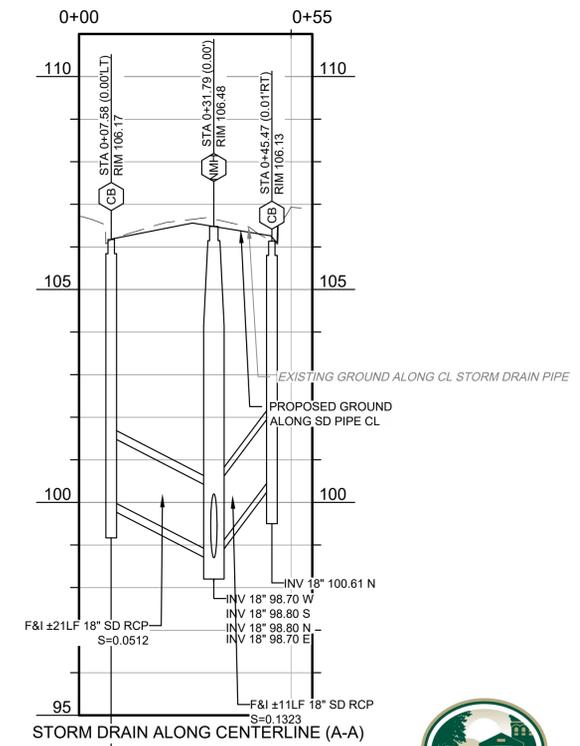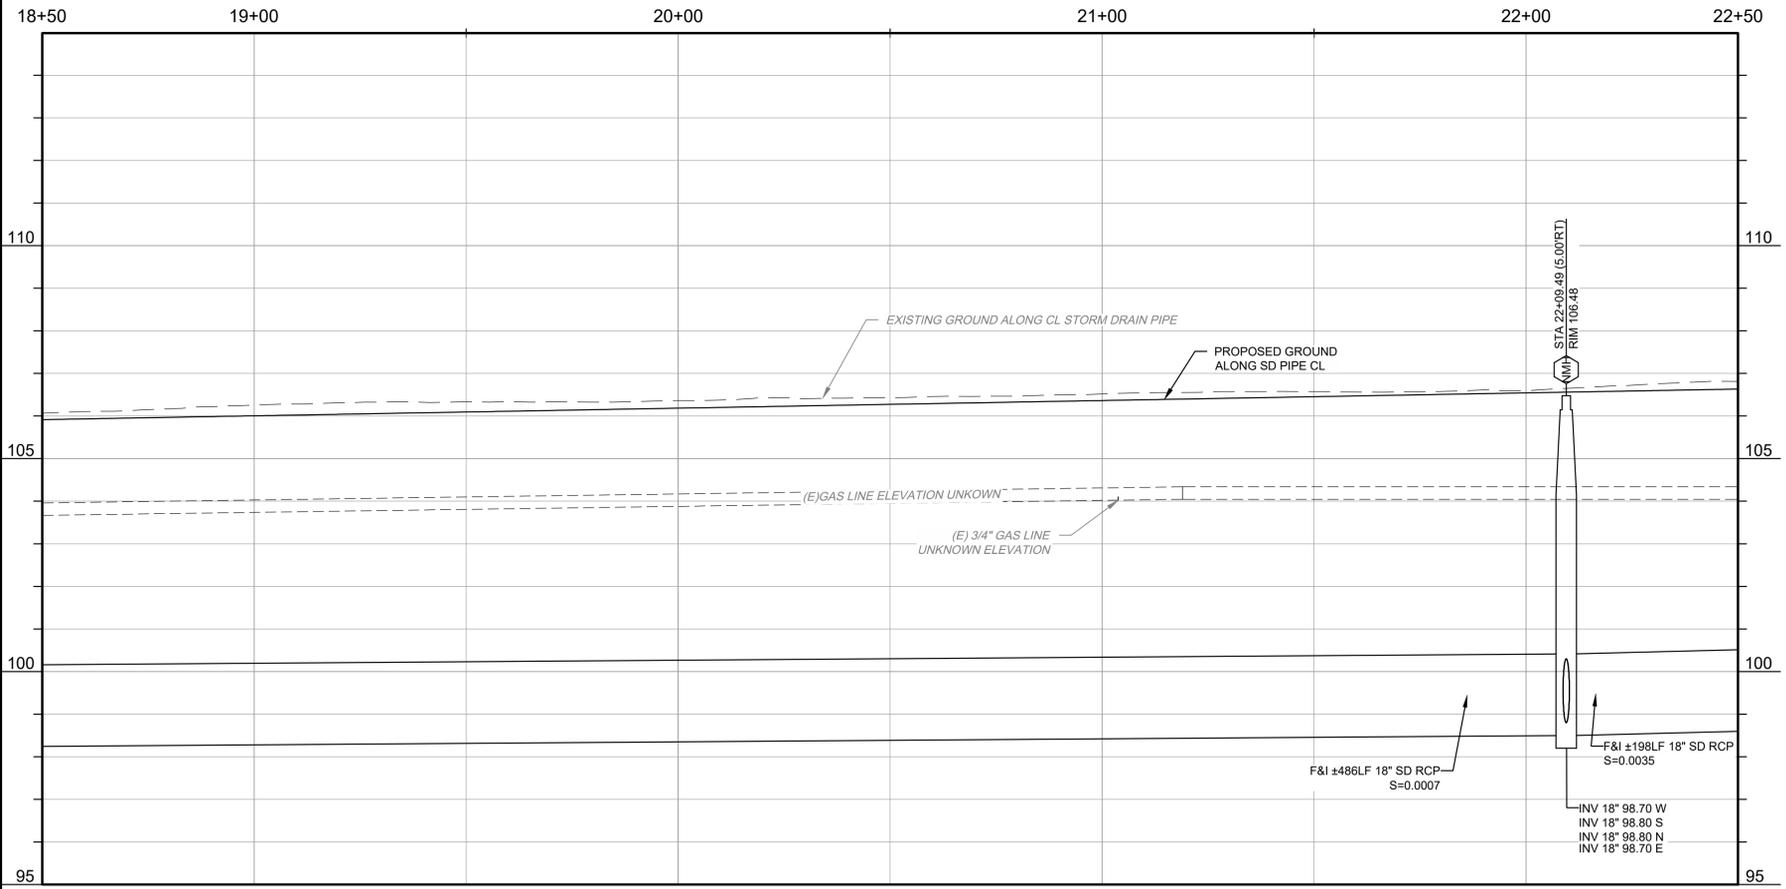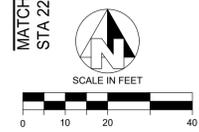

CITY OF TURLOCK  
MUNICIPAL SERVICES DEPARTMENT  
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CITY OF TURLOCK  
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CITY PROJECT No. 23-068, PACKAGE 3  
STORM DRAIN  
MARSHALL ST

**PROVOST & PRITCHARD**  
425 W. FIR AVENUE  
TURLOCK, CA 95259  
PHONE (559) 449-2700  
FAX (559) 449-2719  
www.provostandpritchard.com

DESIGN ENGINEER:  
JEFF DORN  
LICENSE NO:  
76,749

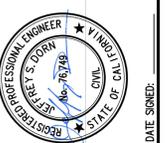DRAFTED BY: AR  
CHECKED BY: JD


DATE: JAN 2026  
JOB NO: 229224001

PROJECT NO: 229224001  
PHASE: 3

0" = 1"  
INCH, ADJUST SCALE FOR  
REDUCED OR ENLARGED PLANS.

SHEET **U3**  
49 OF 78

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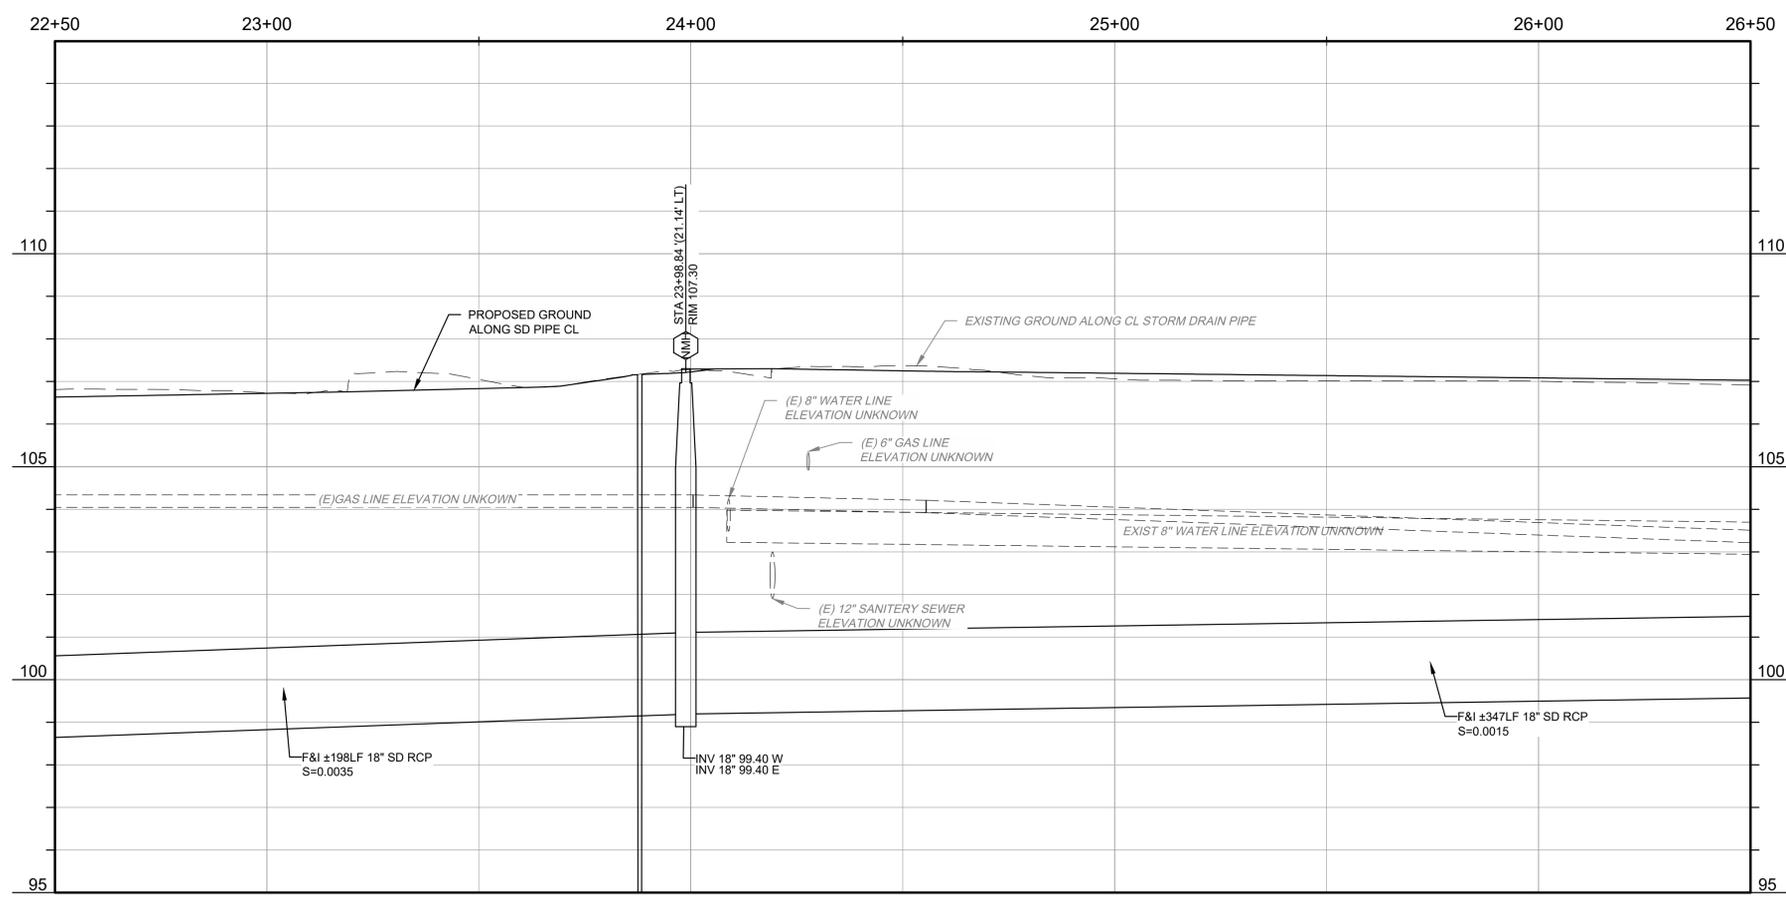
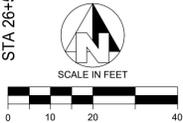


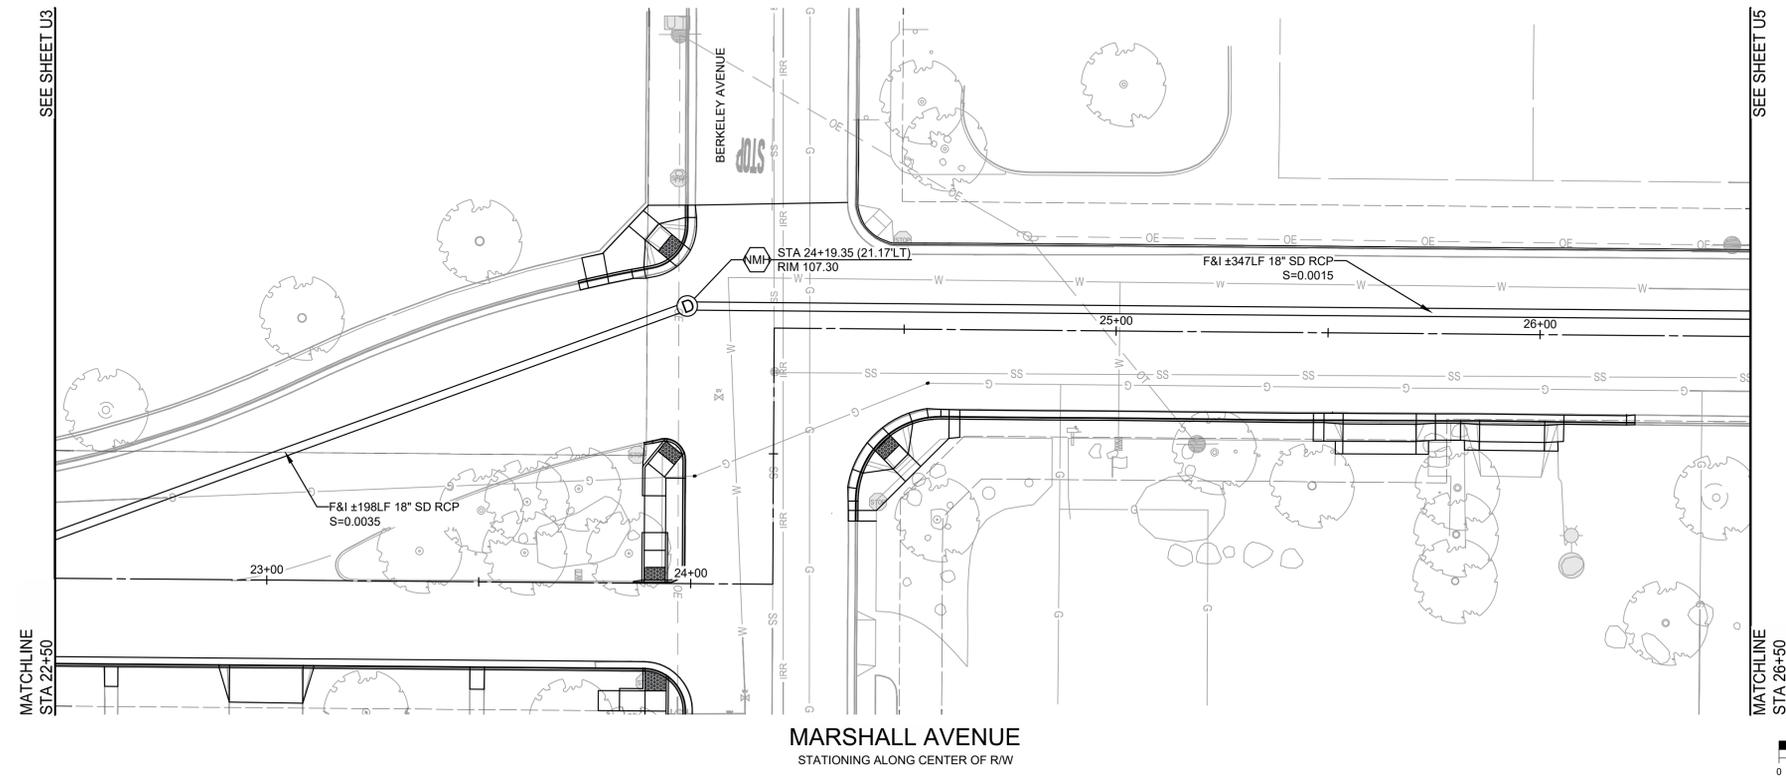**WARNING**  
  
**POWER LINES OVERHEAD**

**811**  
 Know what's below.  
 Call before you dig.

CONSTRUCTION CALLOUTS	
SYMBOL	DESCRIPTION
	REMOVE AND REPLACE CATCH BASIN PER CITY OF TURLOCK STD SD-3
	CONSTRUCT CATCH BASIN PER CITY OF TURLOCK STD SD-3
	ADJUST EXISTING MANHOLE TO FINISHED GRADE AFTER PAVING OPERATIONS PER DETAIL
	CONSTRUCT MANHOLE PER CITY OF TURLOCK STD S-3
	REMOVE PIPE

NOTE:  
 STORM DRAIN PIPELINES SHALL BE LOW PRESSURE AIR TESTED PER SECTION 16-30 OF THE CITY STANDARD SPECIFICATIONS.



CITY OF TURLOCK  
 MUNICIPAL SERVICES DEPARTMENT  
 ROADS PROGRAM DIVISION  
 156 S. BROADWAY, SUITE 150  
 (209) 668-5520

**PROVOST & PRITCHARD**  
 425 W FIR AVENUE  
 CHICO, CA 95926  
 PHONE (530) 449-2700  
 FAX (530) 449-2715  
 www.provostandpritchard.com

DESIGN ENGINEER:  
**JEFF DORN**  
 LICENSE NO:  
 76,749

DRAFTED BY: **AR** CHECKED BY: **JD**

DATE: JAN 2026  
 JOB NO: 229224001  
 PROJECT NO: 229224001  
 PHASE: 3

ORIGINAL SCALE SHOWN IS ONE INCH. ADJUST SCALE FOR REDUCED OR ENLARGED PLANS.

SHEET **U4**

50 OF 78

CITY OF TURLOCK  
 ROADS PROGRAM CIP  
 CITY PROJECT No. 23-068, PACKAGE 3  
 STORM DRAIN  
 MARSHALL ST

DATE SIGNED: \_\_\_\_\_  
 REVISION: \_\_\_\_\_  
 BY: \_\_\_\_\_  
 DATE: \_\_\_\_\_


**BID SET**  
 1/22/2026

PROFESSIONAL ENGINEER  
 JEFF DORN  
 No. 76,749  
 CIVIL  
 STATE OF CALIFORNIA


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SEE SHEET U4

MATCHLINE  
STA 26+50

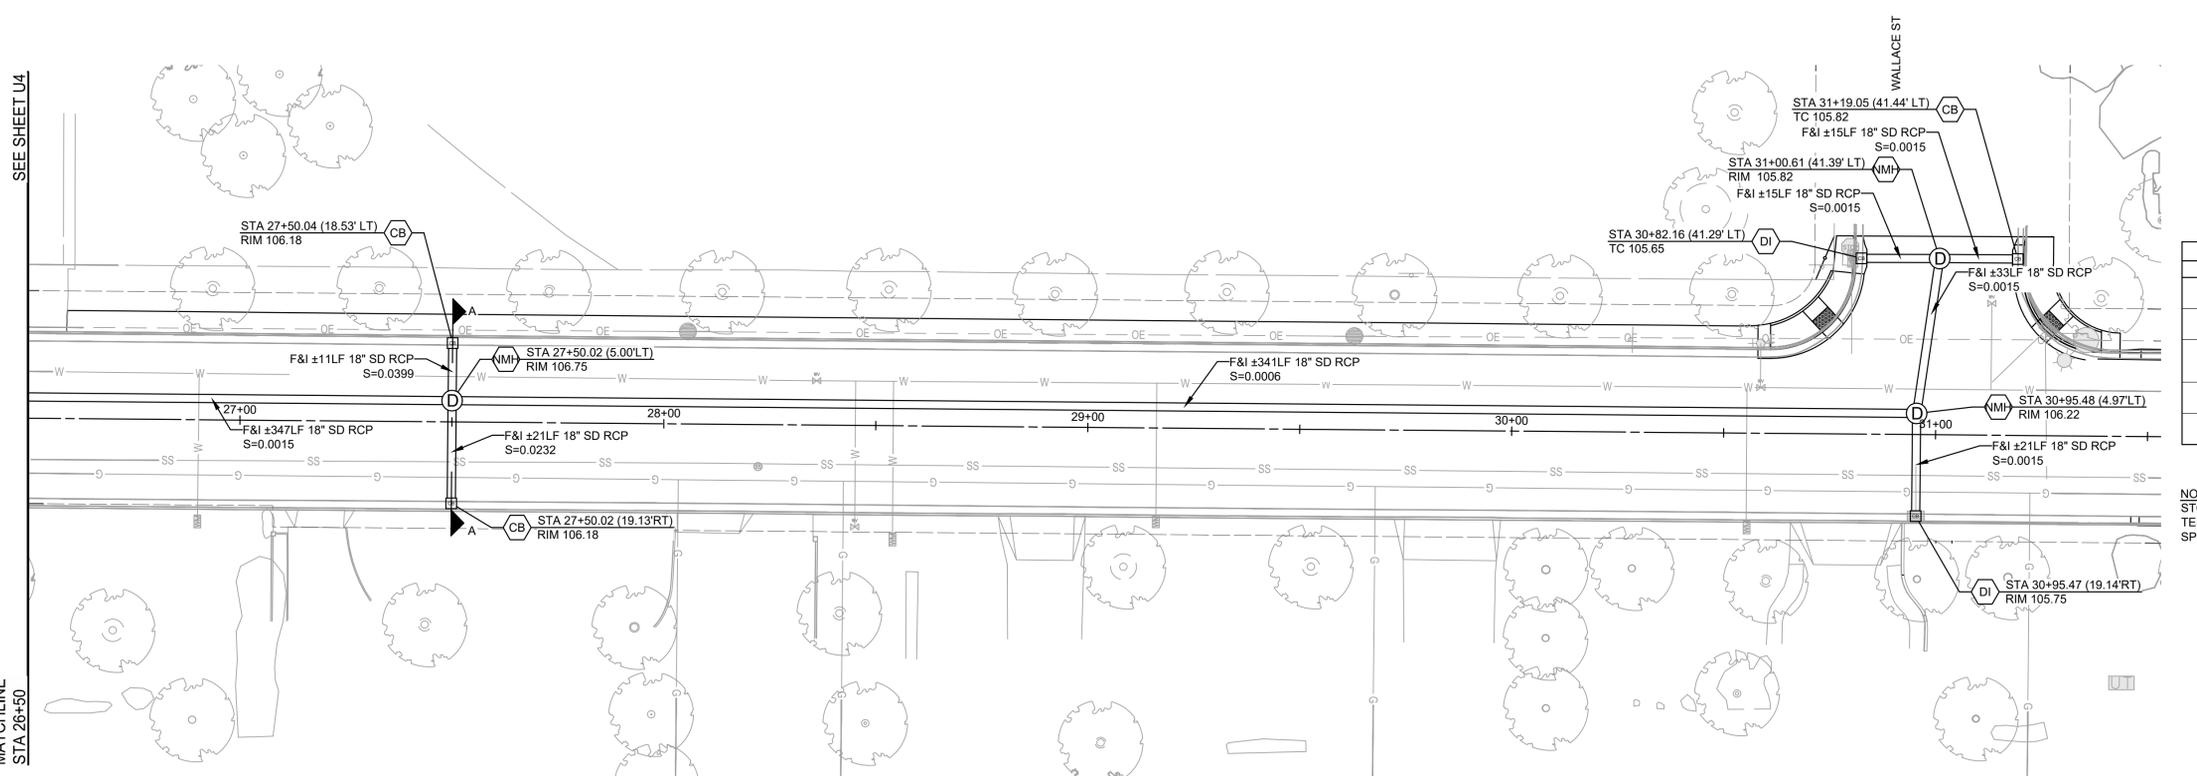

MARSHALL AVENUE  
STATIONING ALONG CENTER OF R/W

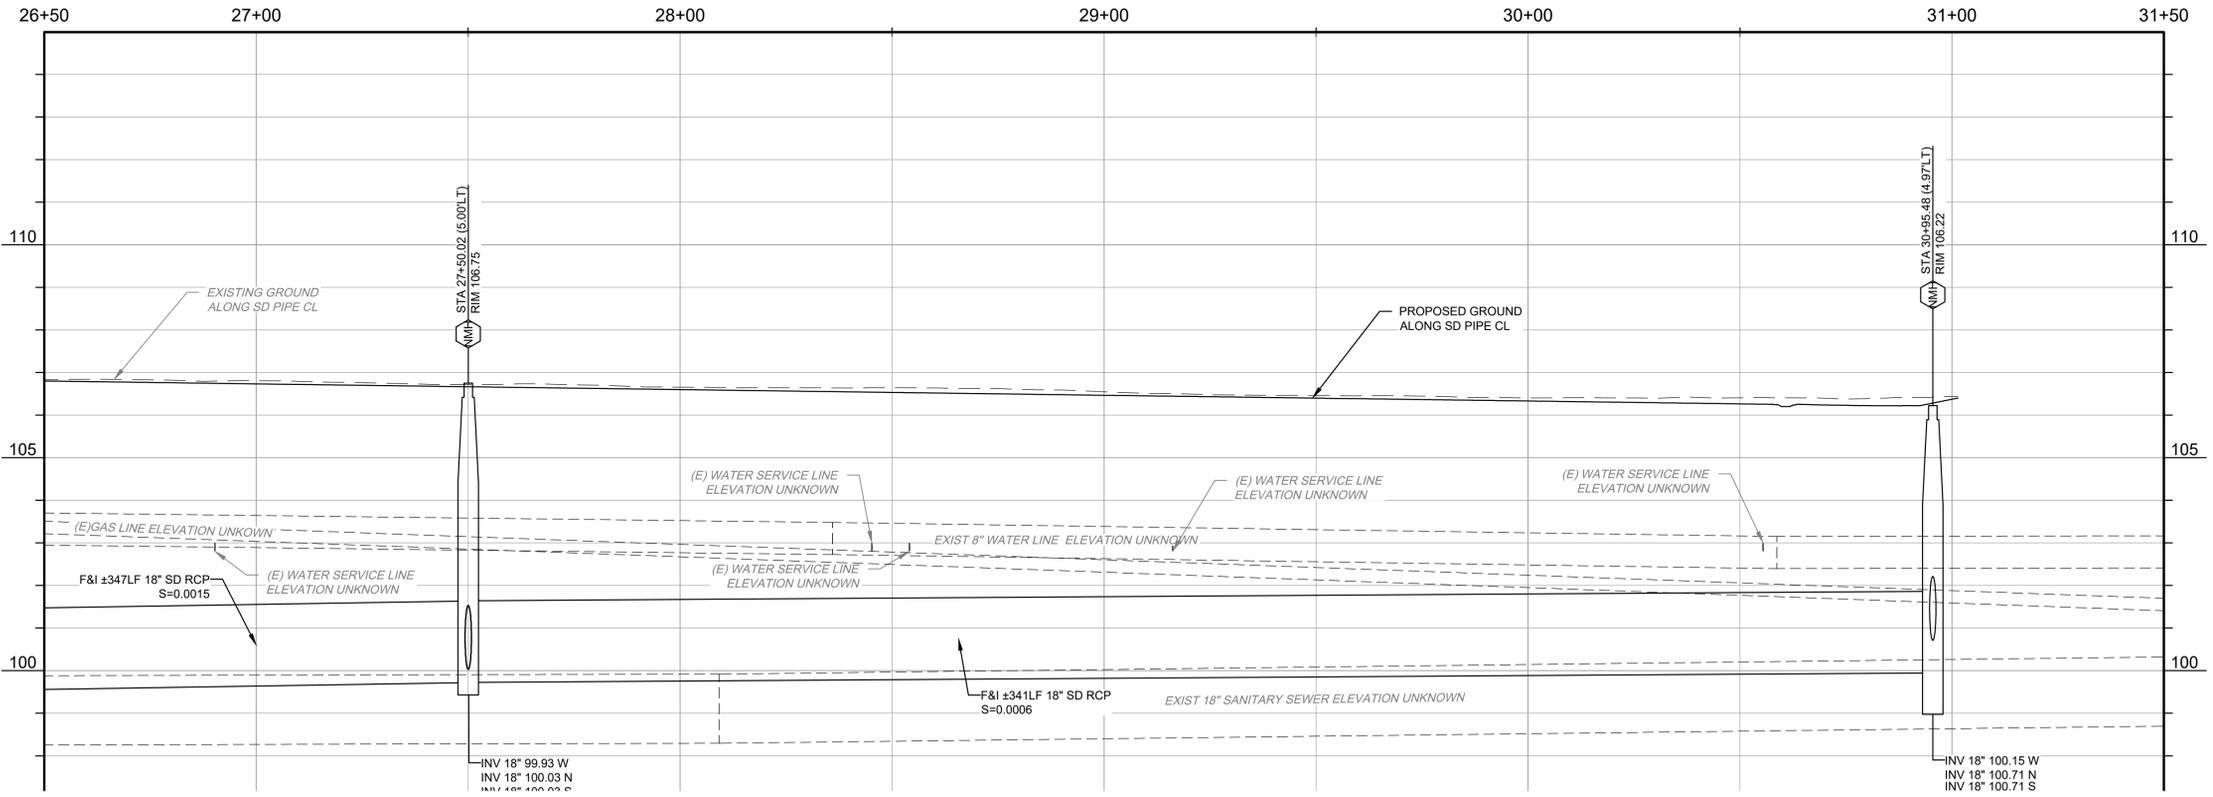


**WARNING**  
POWER LINES  
OVERHEAD

CONSTRUCTION CALLOUTS	
SYMBOL	DESCRIPTION
DI	REMOVE AND REPLACE CATCH BASIN PER CITY OF TURLOCK STD. SD-3
CB	CONSTRUCT CATCH BASIN PER CITY OF TURLOCK STD SD-3
EM	ADJUST EXISTING MANHOLE TO FINISHED GRADE AFTER PAVING OPERATIONS PER DETAIL
NMI	CONSTRUCT MANHOLE PER CITY OF TURLOCK STD S-3
RP	REMOVE PIPE

NOTE:  
STORM DRAIN PIPELINES SHALL BE LOW PRESSURE AIR TESTED PER SECTION 16-30 OF THE CITY STANDARD SPECIFICATIONS.

**BID SET**  
1/22/2026

NO.	REVISION	BY	DATE

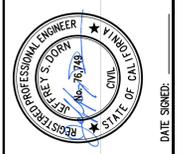

CITY OF TURLOCK  
ROADS PROGRAM CIP  
CITY PROJECT No. 23-068, PACKAGE 3  
STORM DRAIN  
MARSHALL ST

**PROVOST & PRITCHARD**  
425 W. FIR AVENUE  
TURLOCK, CA 95259  
PHONE (559) 449-2700  
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DESIGN ENGINEER:  
JEFF DORN  
LICENSE NO:  
76,749

DRAFTED BY: AR  
CHECKED BY: JD

DATE: JAN 2026  
JOB NO: 229224001  
PROJECT NO: 229224001  
PHASE: 3







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SHEET **U5**  
51 OF 78



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(209) 668-5520

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CONSTRUCTION CALLOUTS	
SYMBOL	DESCRIPTION
DI	REMOVE AND REPLACE INLET PER CITY OF TURLOCK STD SD-3
CB	CONSTRUCT CATCH BASIN PER CITY OF TURLOCK STD SD-3
EM	ADJUST EXISTING MANHOLE TO FINISHED GRADE AFTER PAVING OPERATIONS PER DETAIL
NMH	CONSTRUCT MANHOLE PER CITY OF TURLOCK STD S-3

NOTE:  
STORM DRAIN PIPELINES SHALL BE LOW PRESSURE AIR TESTED PER SECTION 18-30 OF THE CITY STANDARD SPECIFICATIONS.

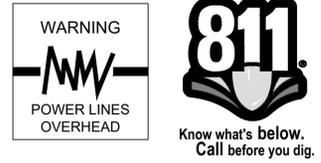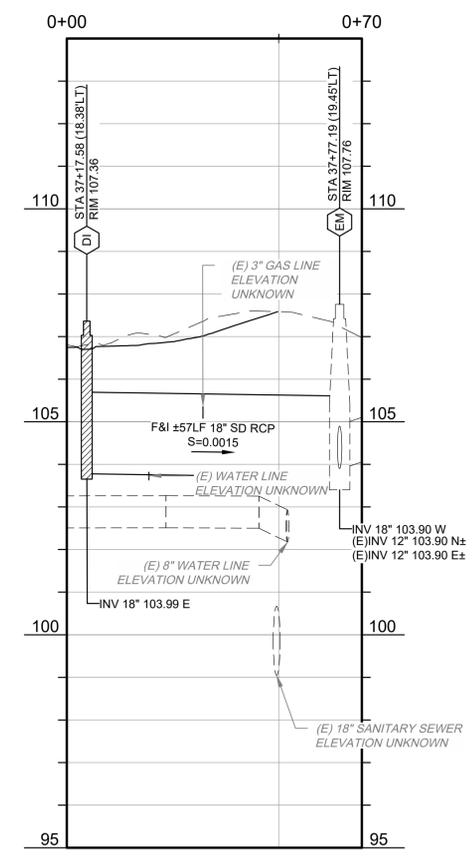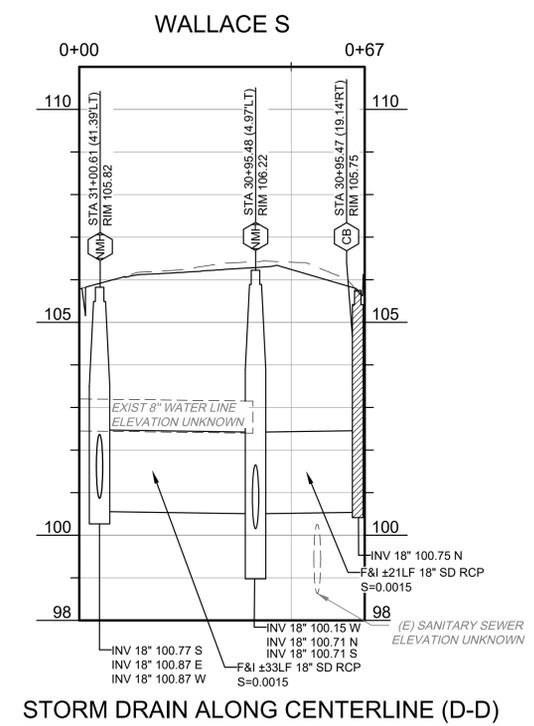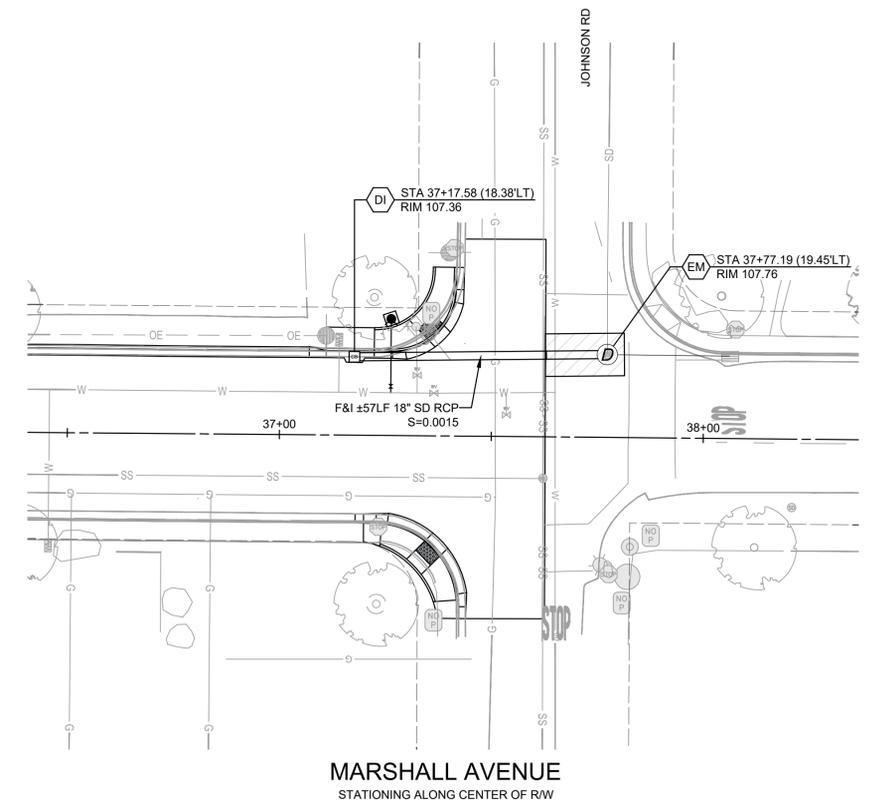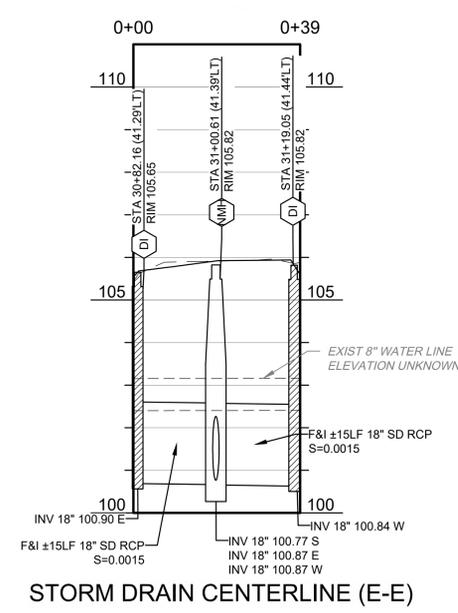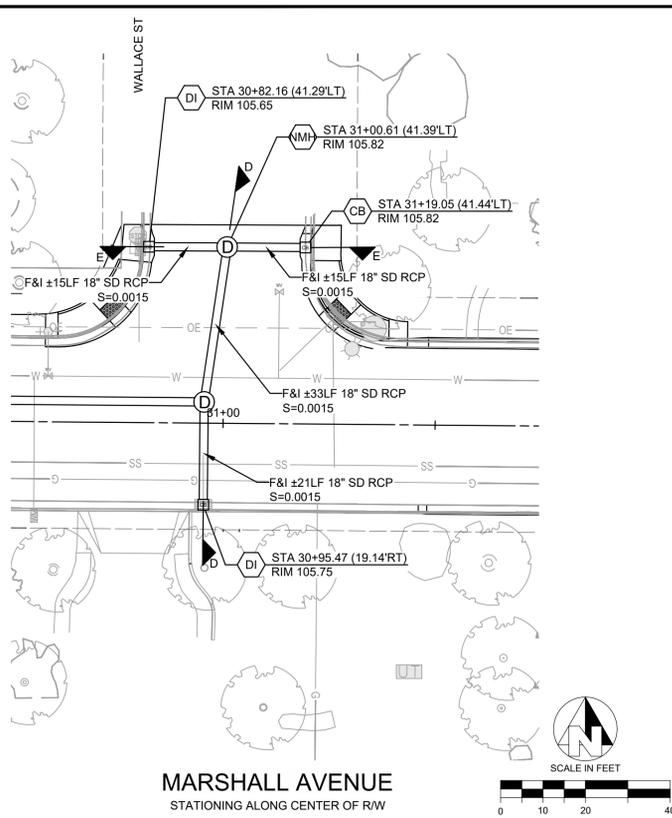LEGEND

TRENCH PER CITY OF TURLOCK STANDARDS T-1,2,3,4,5 & 6.

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**BID SET**  
1/22/2026

DATE SIGNED: \_\_\_\_\_  
BY: \_\_\_\_\_  
REVISION: \_\_\_\_\_  
NO. \_\_\_\_\_

PROFESSIONAL ENGINEER  
JEFF DORN  
No. 76,749  
CIVIL  
STATE OF CALIFORNIA

CITY OF TURLOCK  
ROADS PROGRAM CIP  
CITY PROJECT No. 23-068, PACKAGE 3  
STORM DRAIN  
MARSHALL ST

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425 W FIR AVENUE  
TURLOCK, CA 95259  
PHONE (559) 449-2700  
FAX (559) 449-2715  
www.provostandpritchard.com

DESIGN ENGINEER:  
JEFF DORN  
LICENSE NO:  
76,749

DRAFTED BY: AR  
CHECKED BY: JD

DATE: JAN 2026  
JOB NO: 229224001  
PROJECT NO: 229224001  
PHASE: 3

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SHEET **U6**  
52 OF 78



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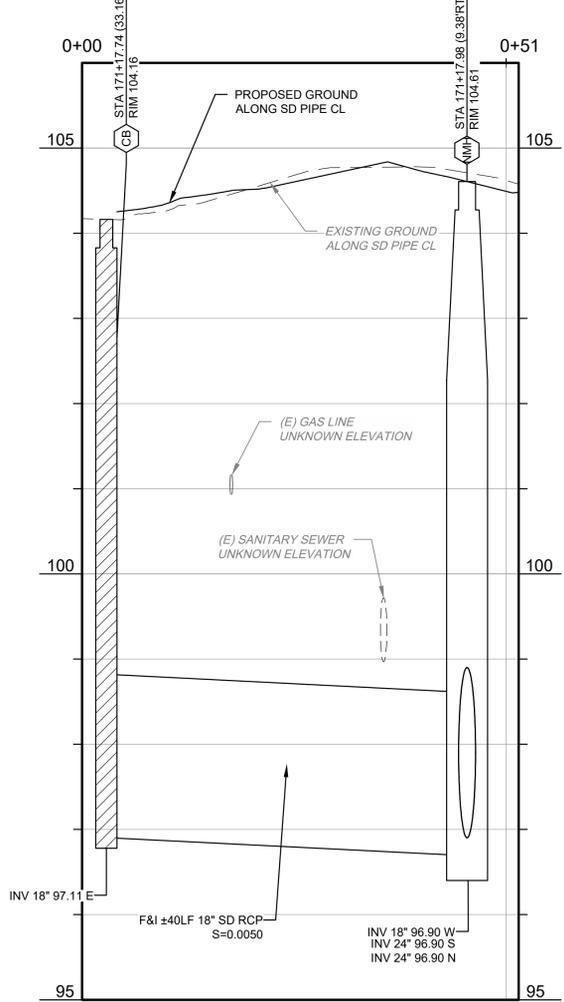
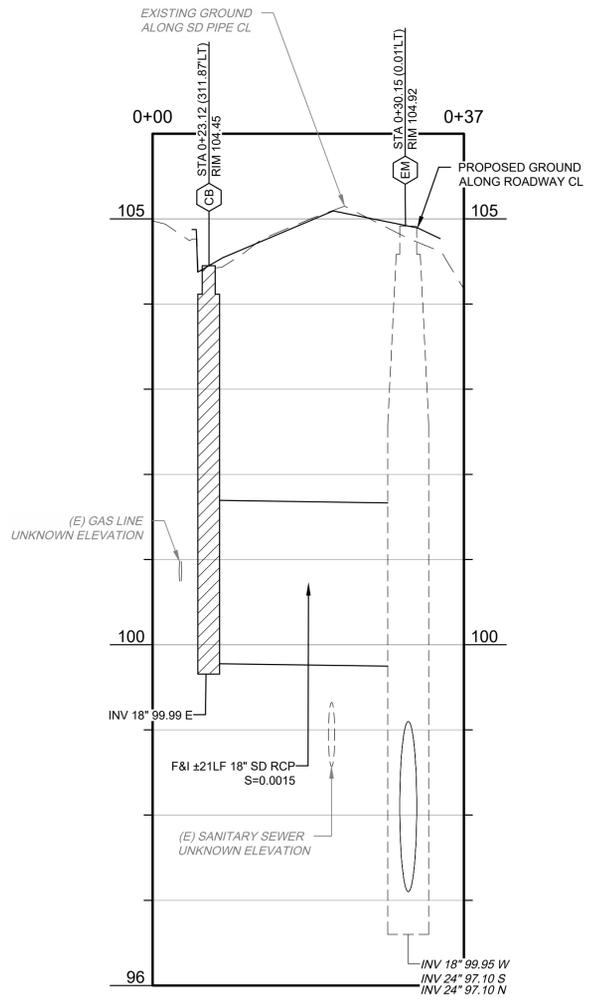
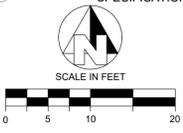
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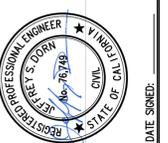


CONSTRUCTION CALLOUTS	
SYMBOL	DESCRIPTION
DI	REMOVE AND REPLACE INLET PER CITY OF TURLOCK STD SD-3
CB	CONSTRUCT CATCH BASIN PER CITY OF TURLOCK STD SD-3
EM	ADJUST EXISTING MANHOLE TO FINISHED GRADE AFTER PAVING OPERATIONS PER DETAIL
NMH	CONSTRUCT MANHOLE PER CITY OF TURLOCK STD S-3
RSD	REMOVE EXISTING SD LINE

NOTE:  
STORM DRAIN PIPELINES SHALL BE LOW PRESSURE AIR TESTED PER SECTION 16-30 OF THE CITY STANDARD SPECIFICATIONS.



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CITY OF TURLOCK  
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STORM DRAIN  
BELL ST
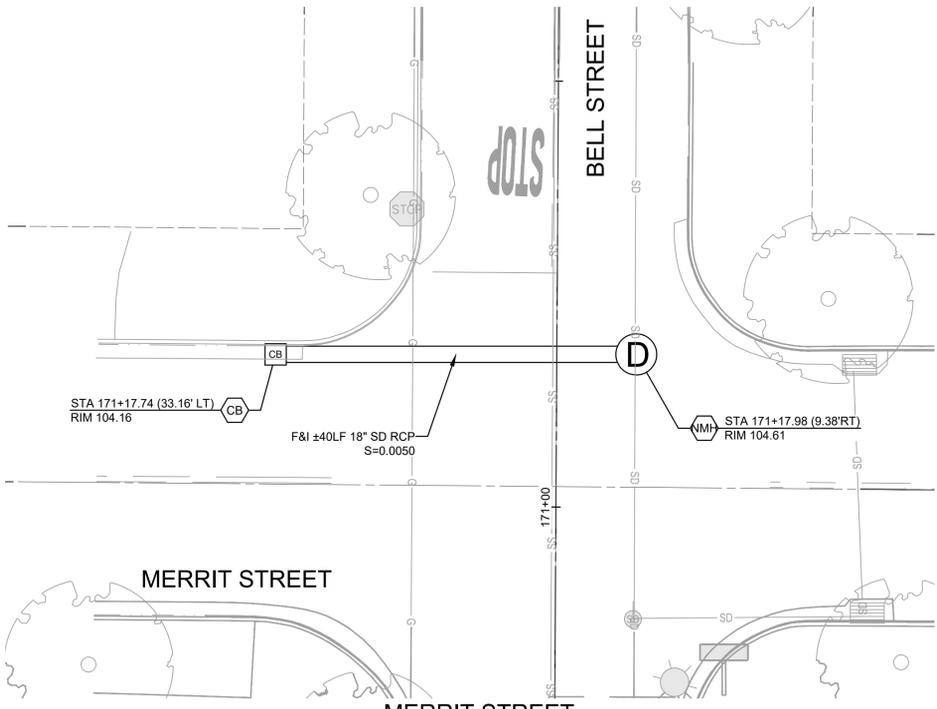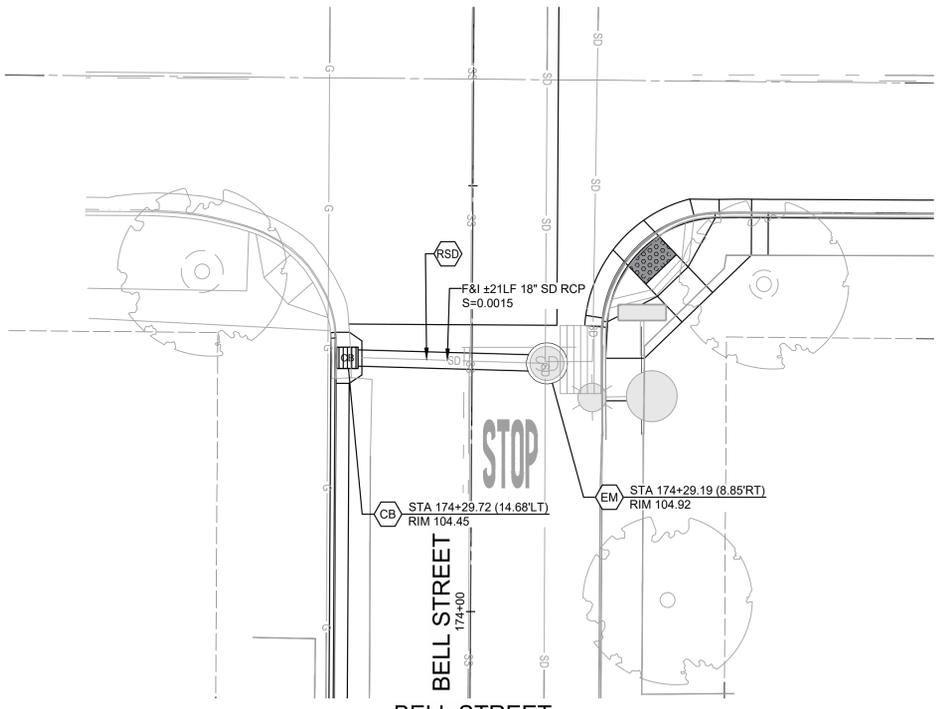
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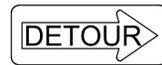
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R11-2



M4-10



M6-4



C19 (CA)



R11-4



W5-1




C23 (CA)



SC3 (CA)



M4-8

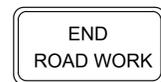

G20-2



W4-2



W20-2



R3-1




R5-1



M4-8a



R3-2

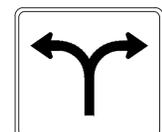

R60B (CA)



R3-5a



R3-5




TRAFFIC CONTROL SIGN LEGEND



TRAFFIC CONTROL GENERAL NOTES:

- 1. VALIDATION: THE TRAFFIC CONTROL PLAN IS NOT VALID UNTIL WORK DATES ARE APPROVED. THE CONTRACTOR SHALL, PER SECTION 601-2 OF THE CITY SUPPLEMENT TO THE STANDARD SPECIFICATIONS FOR PUBLIC WORKS CONSTRUCTION, CONTACT THE PUBLIC WORKS TRAFFIC CONTROL SECTION AT (209) 668-5590 TO OBTAIN A PERMIT. THE CONTRACTOR MUST SUBMIT A COMPLETED TRAFFIC CONTROL PERMIT FORM A MINIMUM OF TWO (2) WORKING DAYS PRIOR TO STARTING WORK, OR FIVE (5) WORKING DAYS WHEN WORK WILL AFFECT A TRAFFIC SIGNAL.
2. STANDARDS: THIS TRAFFIC CONTROL PLAN SHALL CONFORM TO EACH OF THE FOLLOWING MANUALS: EDITION DESCRIPTION 2014 CALIFORNIA MANUAL ON UNIFORM TRAFFIC CONTROL DEVICES CA MUTCD 2016 CITY OF TURLOCK STANDARD SPECIFICATIONS AND DRAWINGS 2024 CALTRANS STANDARD PLANS
3. NOTIFICATIONS: THE CONTRACTOR SHALL NOTIFY RELEVANT AGENCIES A MINIMUM OF FIVE (5) WORKING DAYS PRIOR TO ANY EXCAVATION, CONSTRUCTION, OR TRAFFIC CONTROL.
4. THE CONTRACTOR SHALL NOTIFY PROPERTY OWNERS AND TENANTS A MINIMUM OF SEVEN (7) WORKING DAYS PRIOR TO CLOSURE OF DRIVEWAYS. THE CONTRACTOR SHALL POST SIGNS NOTIFYING THE PUBLIC A MINIMUM OF SEVEN (7) WORKING DAYS PRIOR TO CLOSURE OF STREETS.
5. POSTING PARKING RESTRICTIONS: THE CONTRACTOR SHALL POST "TOW-AWAY/NO PARKING SIGNS SEVENTY TWO (72) HOURS IN ADVANCE OF PARKING REMOVAL. SIGNS SHALL INDICATE SPECIFIC DAYS, DATES, AND TIMES OF RESTRICTIONS.
6. EXCAVATIONS: EXCEPT AS OTHERWISE SHOWN ON THE PLANS, TRENCHES SHALL BE BACKFILLED OR TRENCH-PLATED AT THE END OF EACH WORK DAY, AN ASPHALT RAMP SHALL BE PLACED AROUND EACH TRENCH PLATE TO PREVENT THE PLATE FROM BEING DISLODGED. CONTRACTOR SHALL MONITOR TRENCH PLATES DURING NON-WORKING HOURS TO ENSURE THAT THEY DO NOT BECOME DISLODGED, UPON COMPLETION OF EXCAVATION BACKFILL, THE CONTRACTOR SHALL PROVIDE A SATISFACTORY SURFACE FOR TRAFFIC, WHEN CONSTRUCTION OPERATIONS ARE NOT ACTIVELY IN PROGRESS, THE CONTRACTOR SHALL MAINTAIN ALL TRAVEL LANES, BIKE LANES, AND PEDESTRIAN WALKWAYS OPEN TO THE APPROPRIATE TRAFFIC EXCEPT AS OTHERWISE SHOWN ON THE PLANS.
7. RESTORATION OF TRAFFIC CONTROL DEVICES: THE CONTRACTOR SHALL REPAIR OR REPLACE TRAFFIC CONTROL DEVICES INCLUDING TRAFFIC SIGNS, STRIPING, PAVEMENT MARKERS, PAVEMENT MARKINGS, LEGENDS, CURB MARKINGS, LOOP DETECTORS, TRAFFIC SIGNAL EQUIPMENT, ETC. DAMAGED OR REMOVED AS A RESULT OF OPERATIONS AND NOT DESIGNATED FOR REMOVAL. REPAIRS AND REPLACEMENTS SHALL BE AT LEAST EQUAL TO EXISTING IMPROVEMENT.
8. TEMPORARY TRAFFIC SIGNAL DETECTION: THE CONTRACTOR SHALL INSTALL CITY APPROVED TEMPORARY VIDEO OR RADAR DETECTION WHEN EXISTING TRAFFIC SIGNAL DETECTION SYSTEMS ARE DAMAGED, DISABLED, OR BECOME INEFFECTIVE DUE TO CONSTRUCTION FOR A PERIOD OF FIVE (5) OR MORE DAYS. THE CONTRACTOR SHALL COMPLETELY REMOVE ALL TEMPORARY TRAFFIC SIGNAL DETECTION EQUIPMENT AND RESTORE/INSTALL A CITY APPROVED PERMANENT VEHICLE DETECTION SYSTEM UPON COMPLETION OF CONSTRUCTION. ALL INSTALLATION AND REMOVALS ARE SUBJECT TO APPROVAL BY THE CITY ENGINEER.
9. CHANGE IN WORK: THE CITY ENGINEER WILL OBSERVE THESE TRAFFIC CONTROL PLANS IN OPERATION AND RESERVE THE RIGHT TO MAKE ANY CHANGES AS FIELD CONDITIONS WARRANT, ANY CHANGES SHALL BE DOCUMENTED AND SUPERCEDE THESE PLANS.
10. OPEN TRENCH: THE CONTRACTOR SHALL PLACE "OPEN TRENCH" SIGNS C27 CA ON TYPE BARRICADES WITHIN THE WORK ZONE, AHEAD OF ANY WORK AREA WHICH INCLUDES OPEN TRENCHES IN EXCESS OF THREE (3) INCHES IN DEPTH, PER CA MUTCD SECTION 6F.103 CA GUIDELINES.
11. FOR WORK NOT COVERED BY THESE TRAFFIC CONTROL PLANS: THE CONTRACTOR SHALL PREPARE TRAFFIC CONTROL WORKING DRAWINGS AND SUBMIT THEM TO THE CITY RESIDENT ENGINEER. THE CONTRACTOR SHALL ALLOW A MINIMUM OF TWENTY (20) WORKING DAYS FOR REVIEW OF THE WORKING DRAWINGS. UPON APPROVAL OF THE TRAFFIC CONTROL PLAN, THE PUBLIC WORKS TRAFFIC CONTROL SECTION WILL ISSUE A TRAFFIC CONTROL PLAN TCP PERMIT FOR THIS WORK.
12. CONTRACTOR SHALL INSTALL UNEVEN PAVEMENT SIGNS C46 CA ALONG THE EDGE OF AREAS WHERE A STEP OF GREATER THAN 2" EXISTS WHETHER PARALLEL OR PERPENDICULAR TO THE DIRECTION OF TRAVEL.
13. SEE TABLE 6H-3 IN THE CALIFORNIA MANUAL ON UNIFORM TRAFFIC CONTROL DEVICES CA MUTCD FOR MEANING OF LETTER CODES ON TYPICAL APPLICATION DIAGRAMS.
14. CONTRACTOR SHALL DEPLOY TEN (10) PORTABLE CHANGEABLE MESSAGE SYSTEMS (PCMS) THROUGHOUT CONSTRUCTION, WITH PLACEMENT AS DIRECTED BY THE ENGINEER.

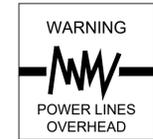

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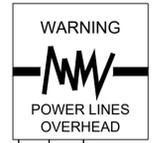
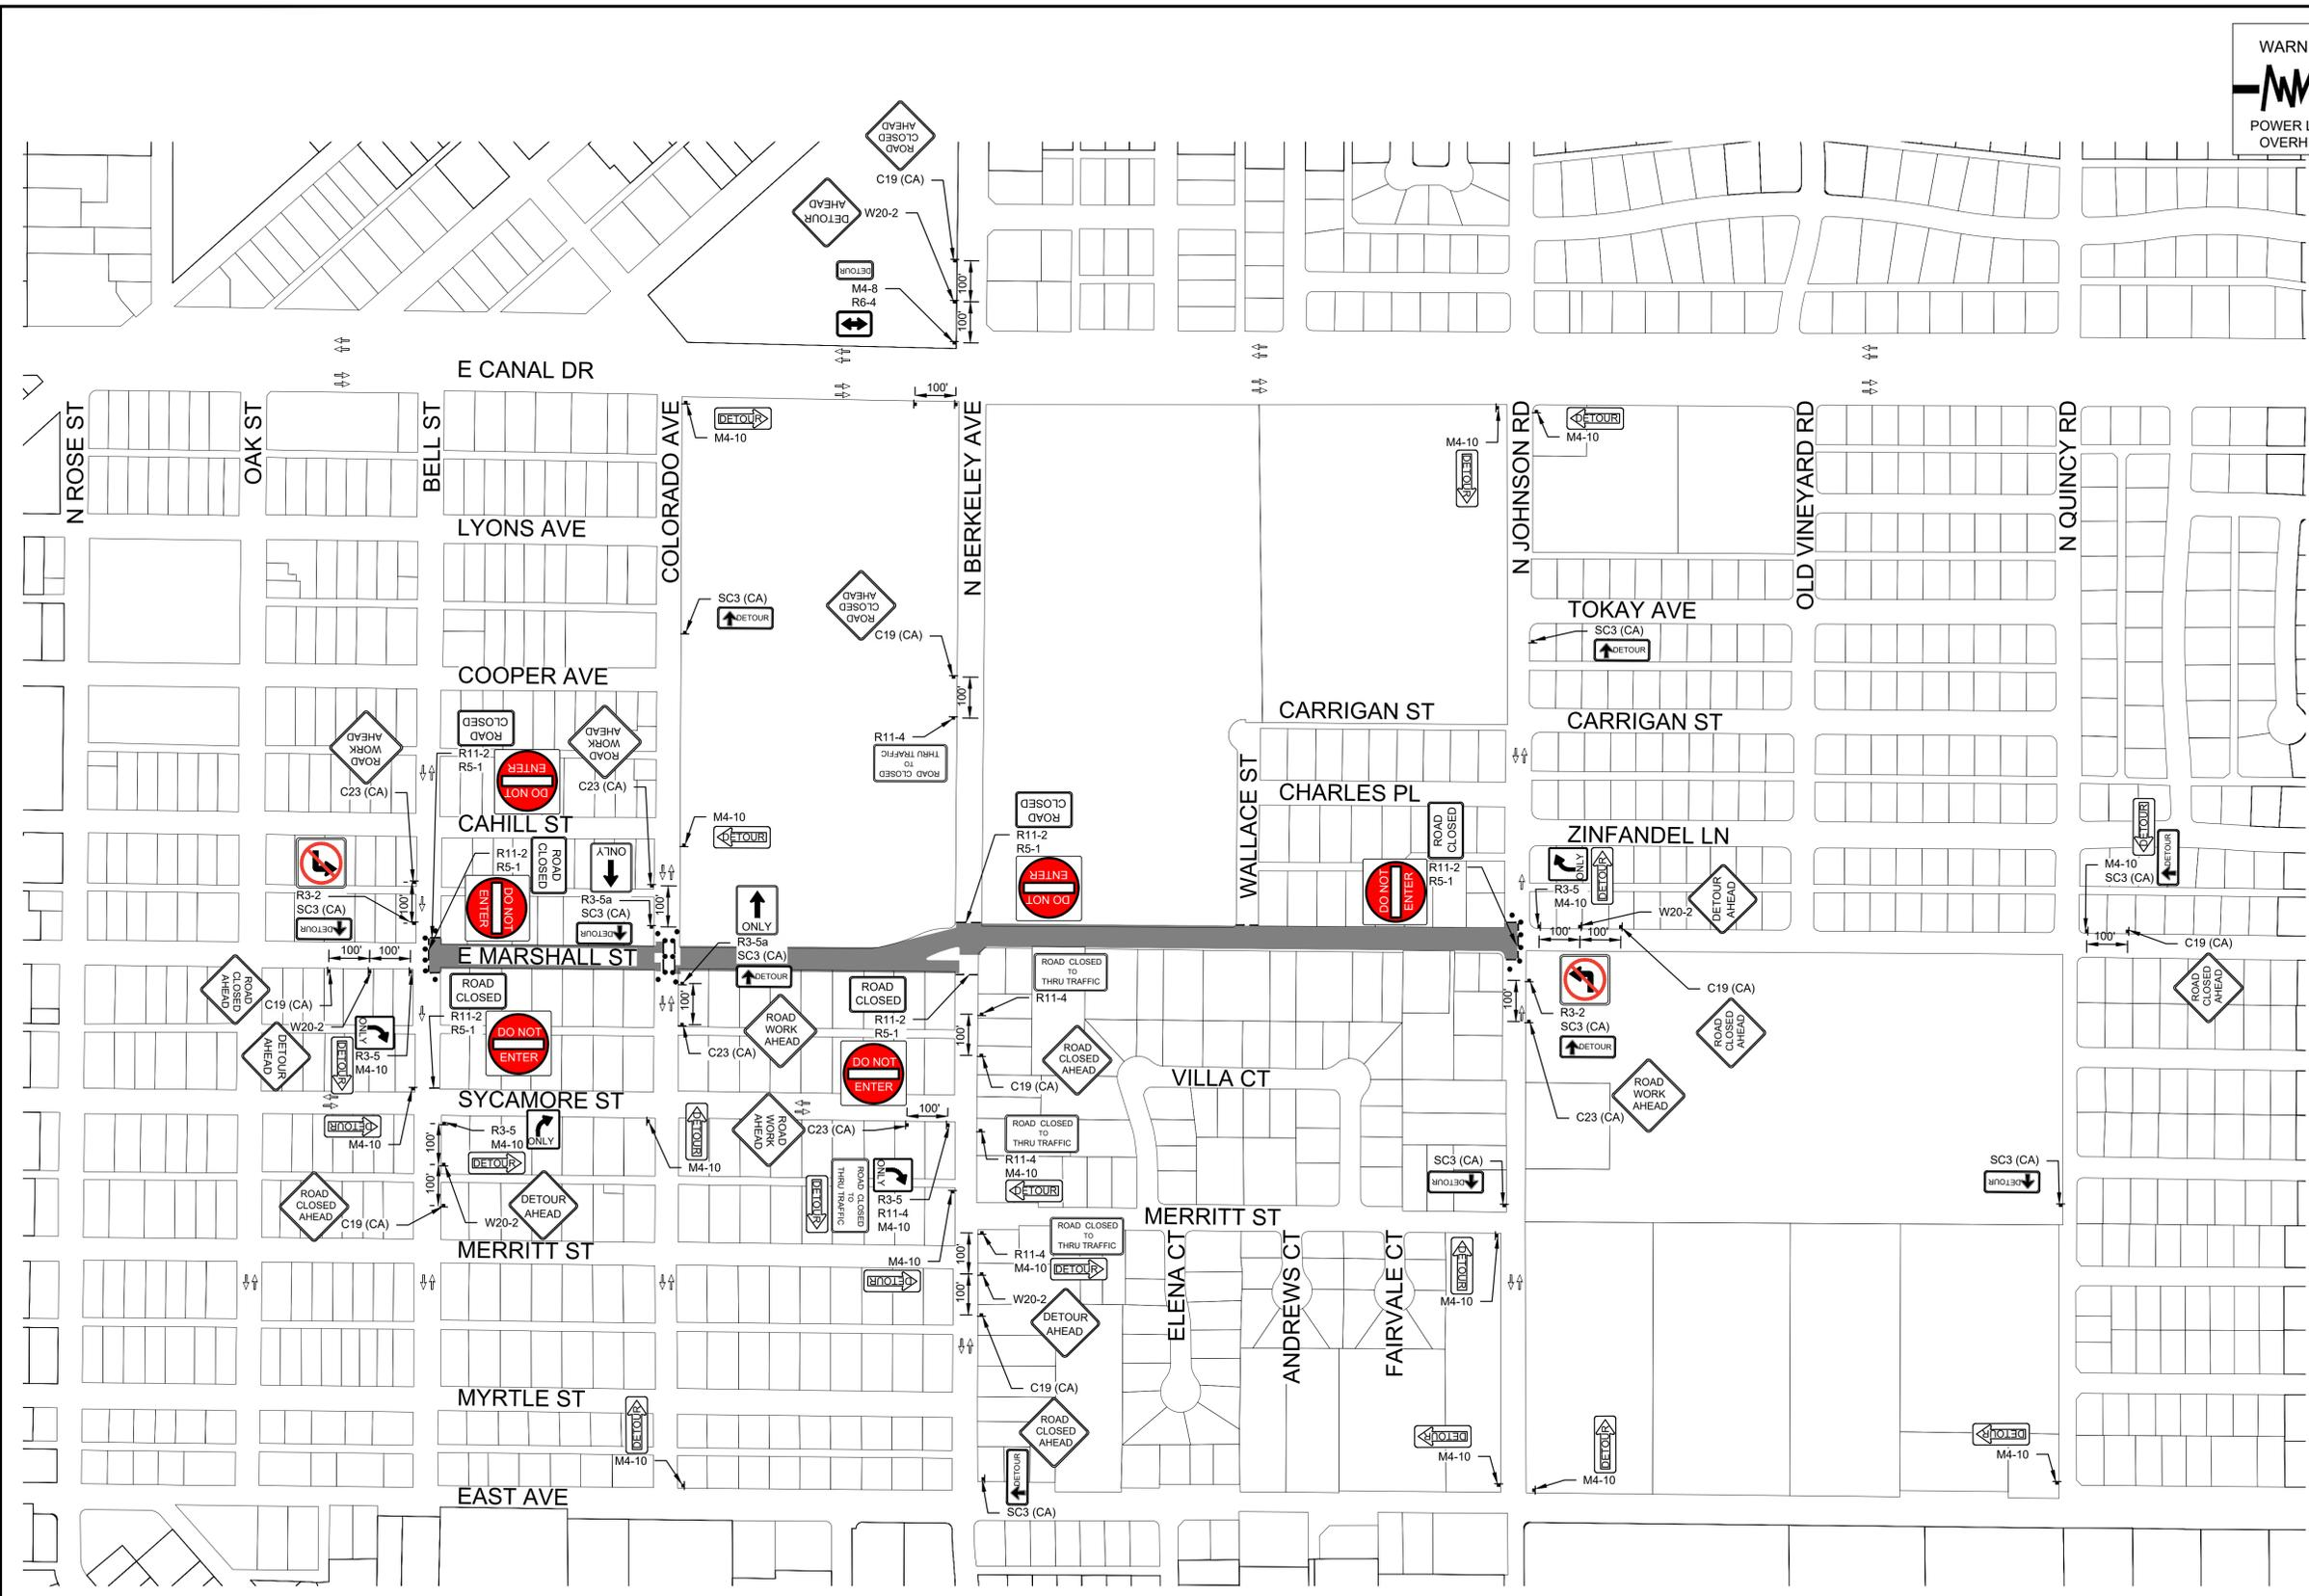
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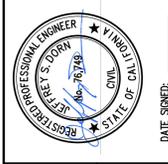
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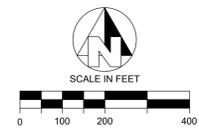
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CITY OF TURLOCK  
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TRAFFIC HANDLING

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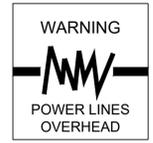


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TRAFFIC DETOUR PLAN - PHASE 2


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TRAFFIC DETOUR PLAN - PHASE 3



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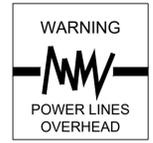
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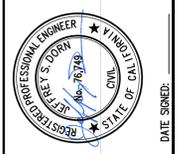
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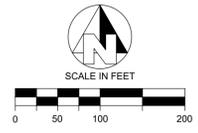
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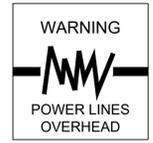
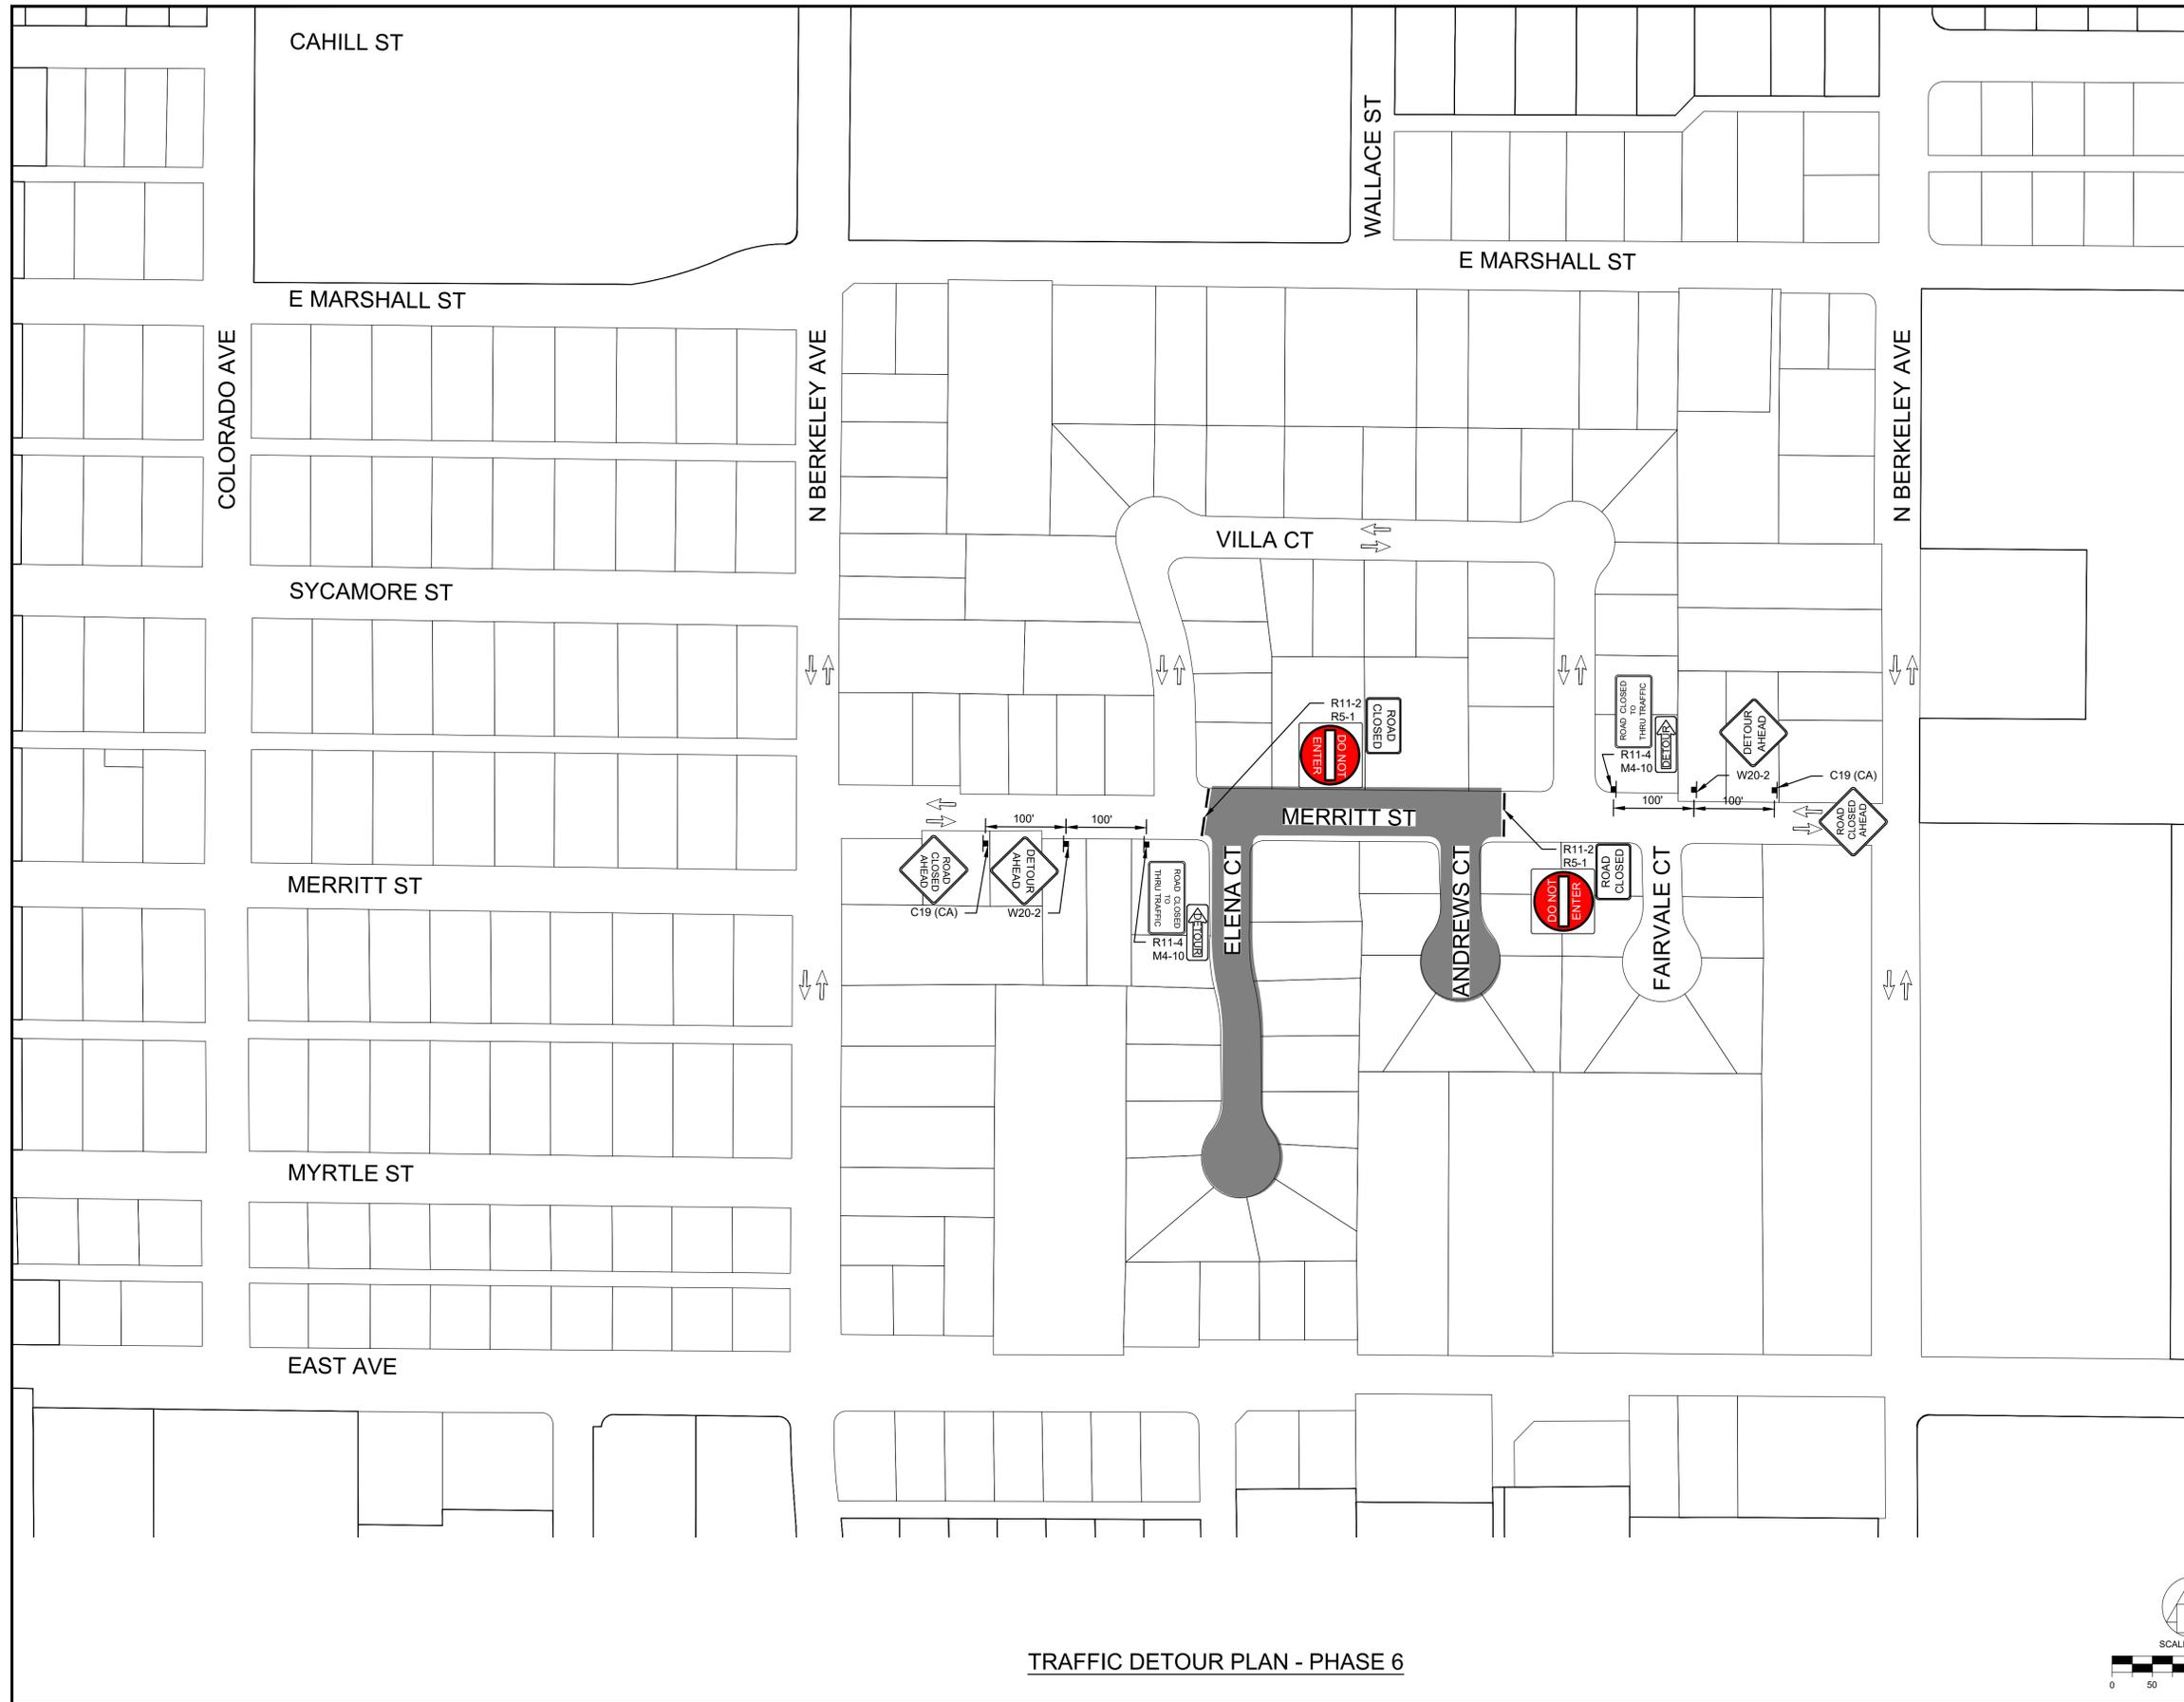


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TRAFFIC DETOUR PLAN - PHASE 4


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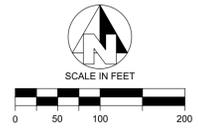

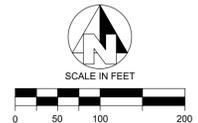
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TRAFFIC HANDLING

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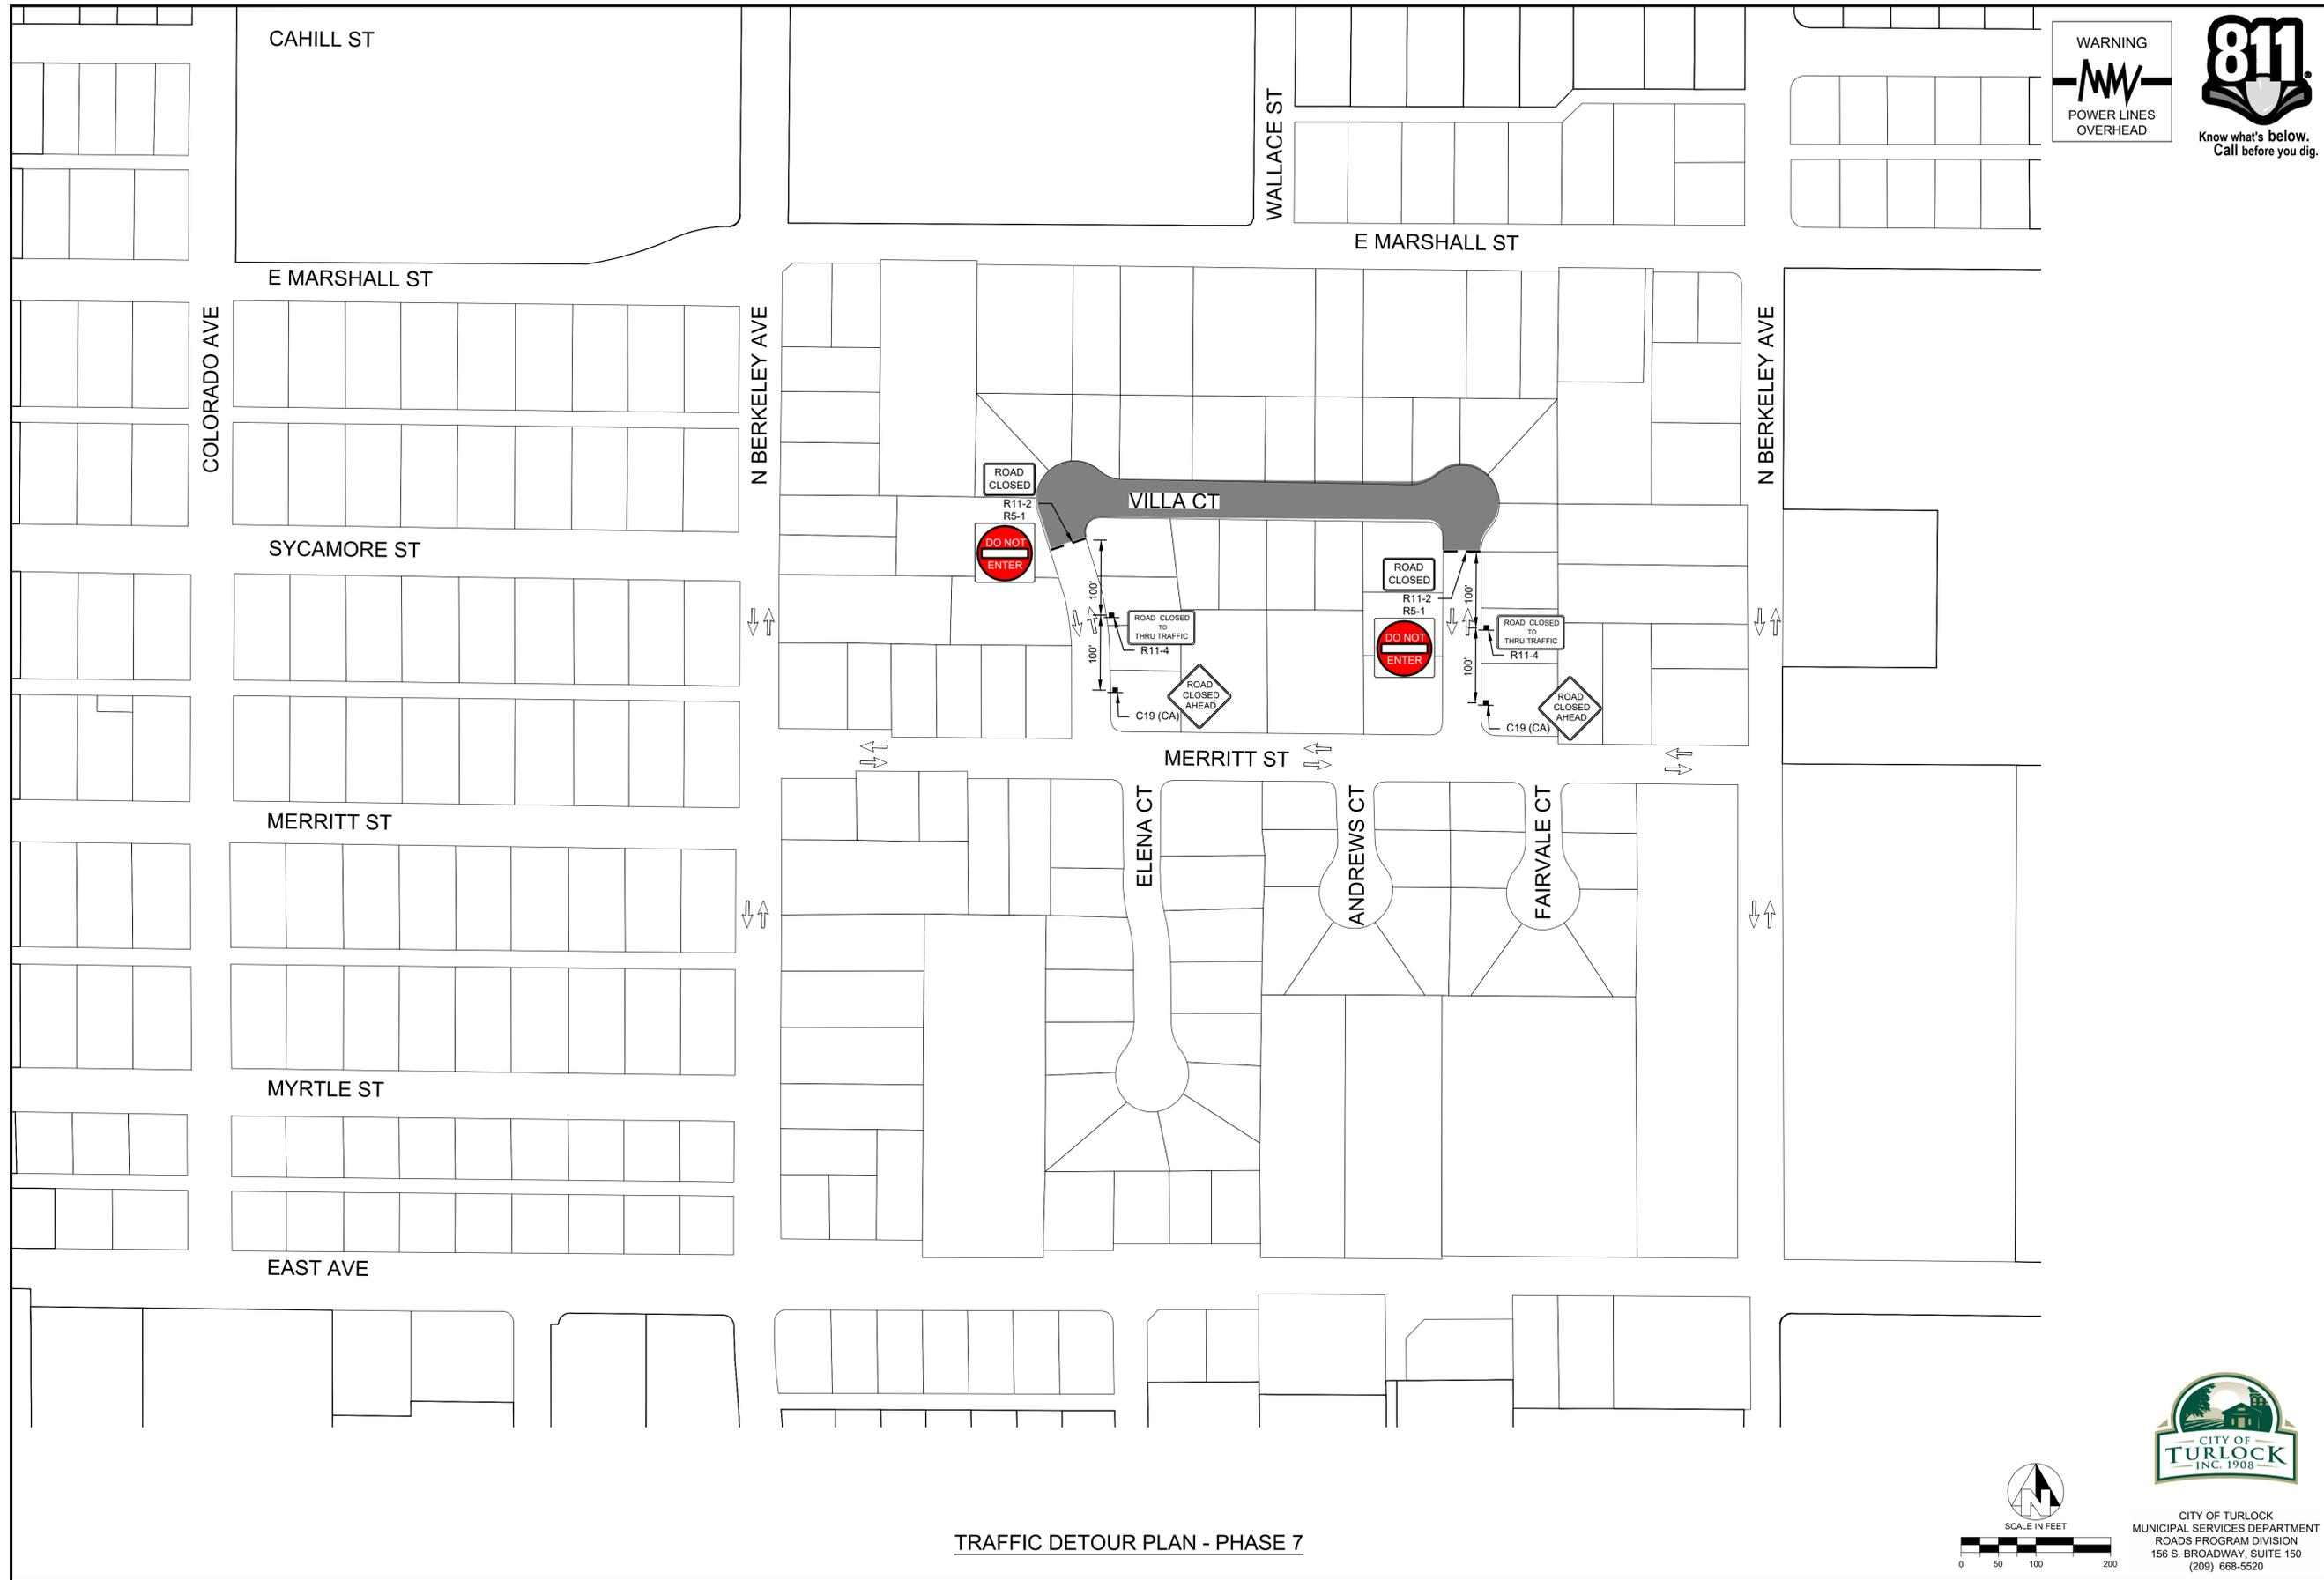
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TRAFFIC DETOUR PLAN - PHASE 6




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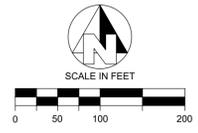

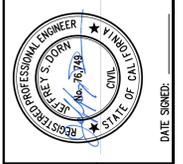
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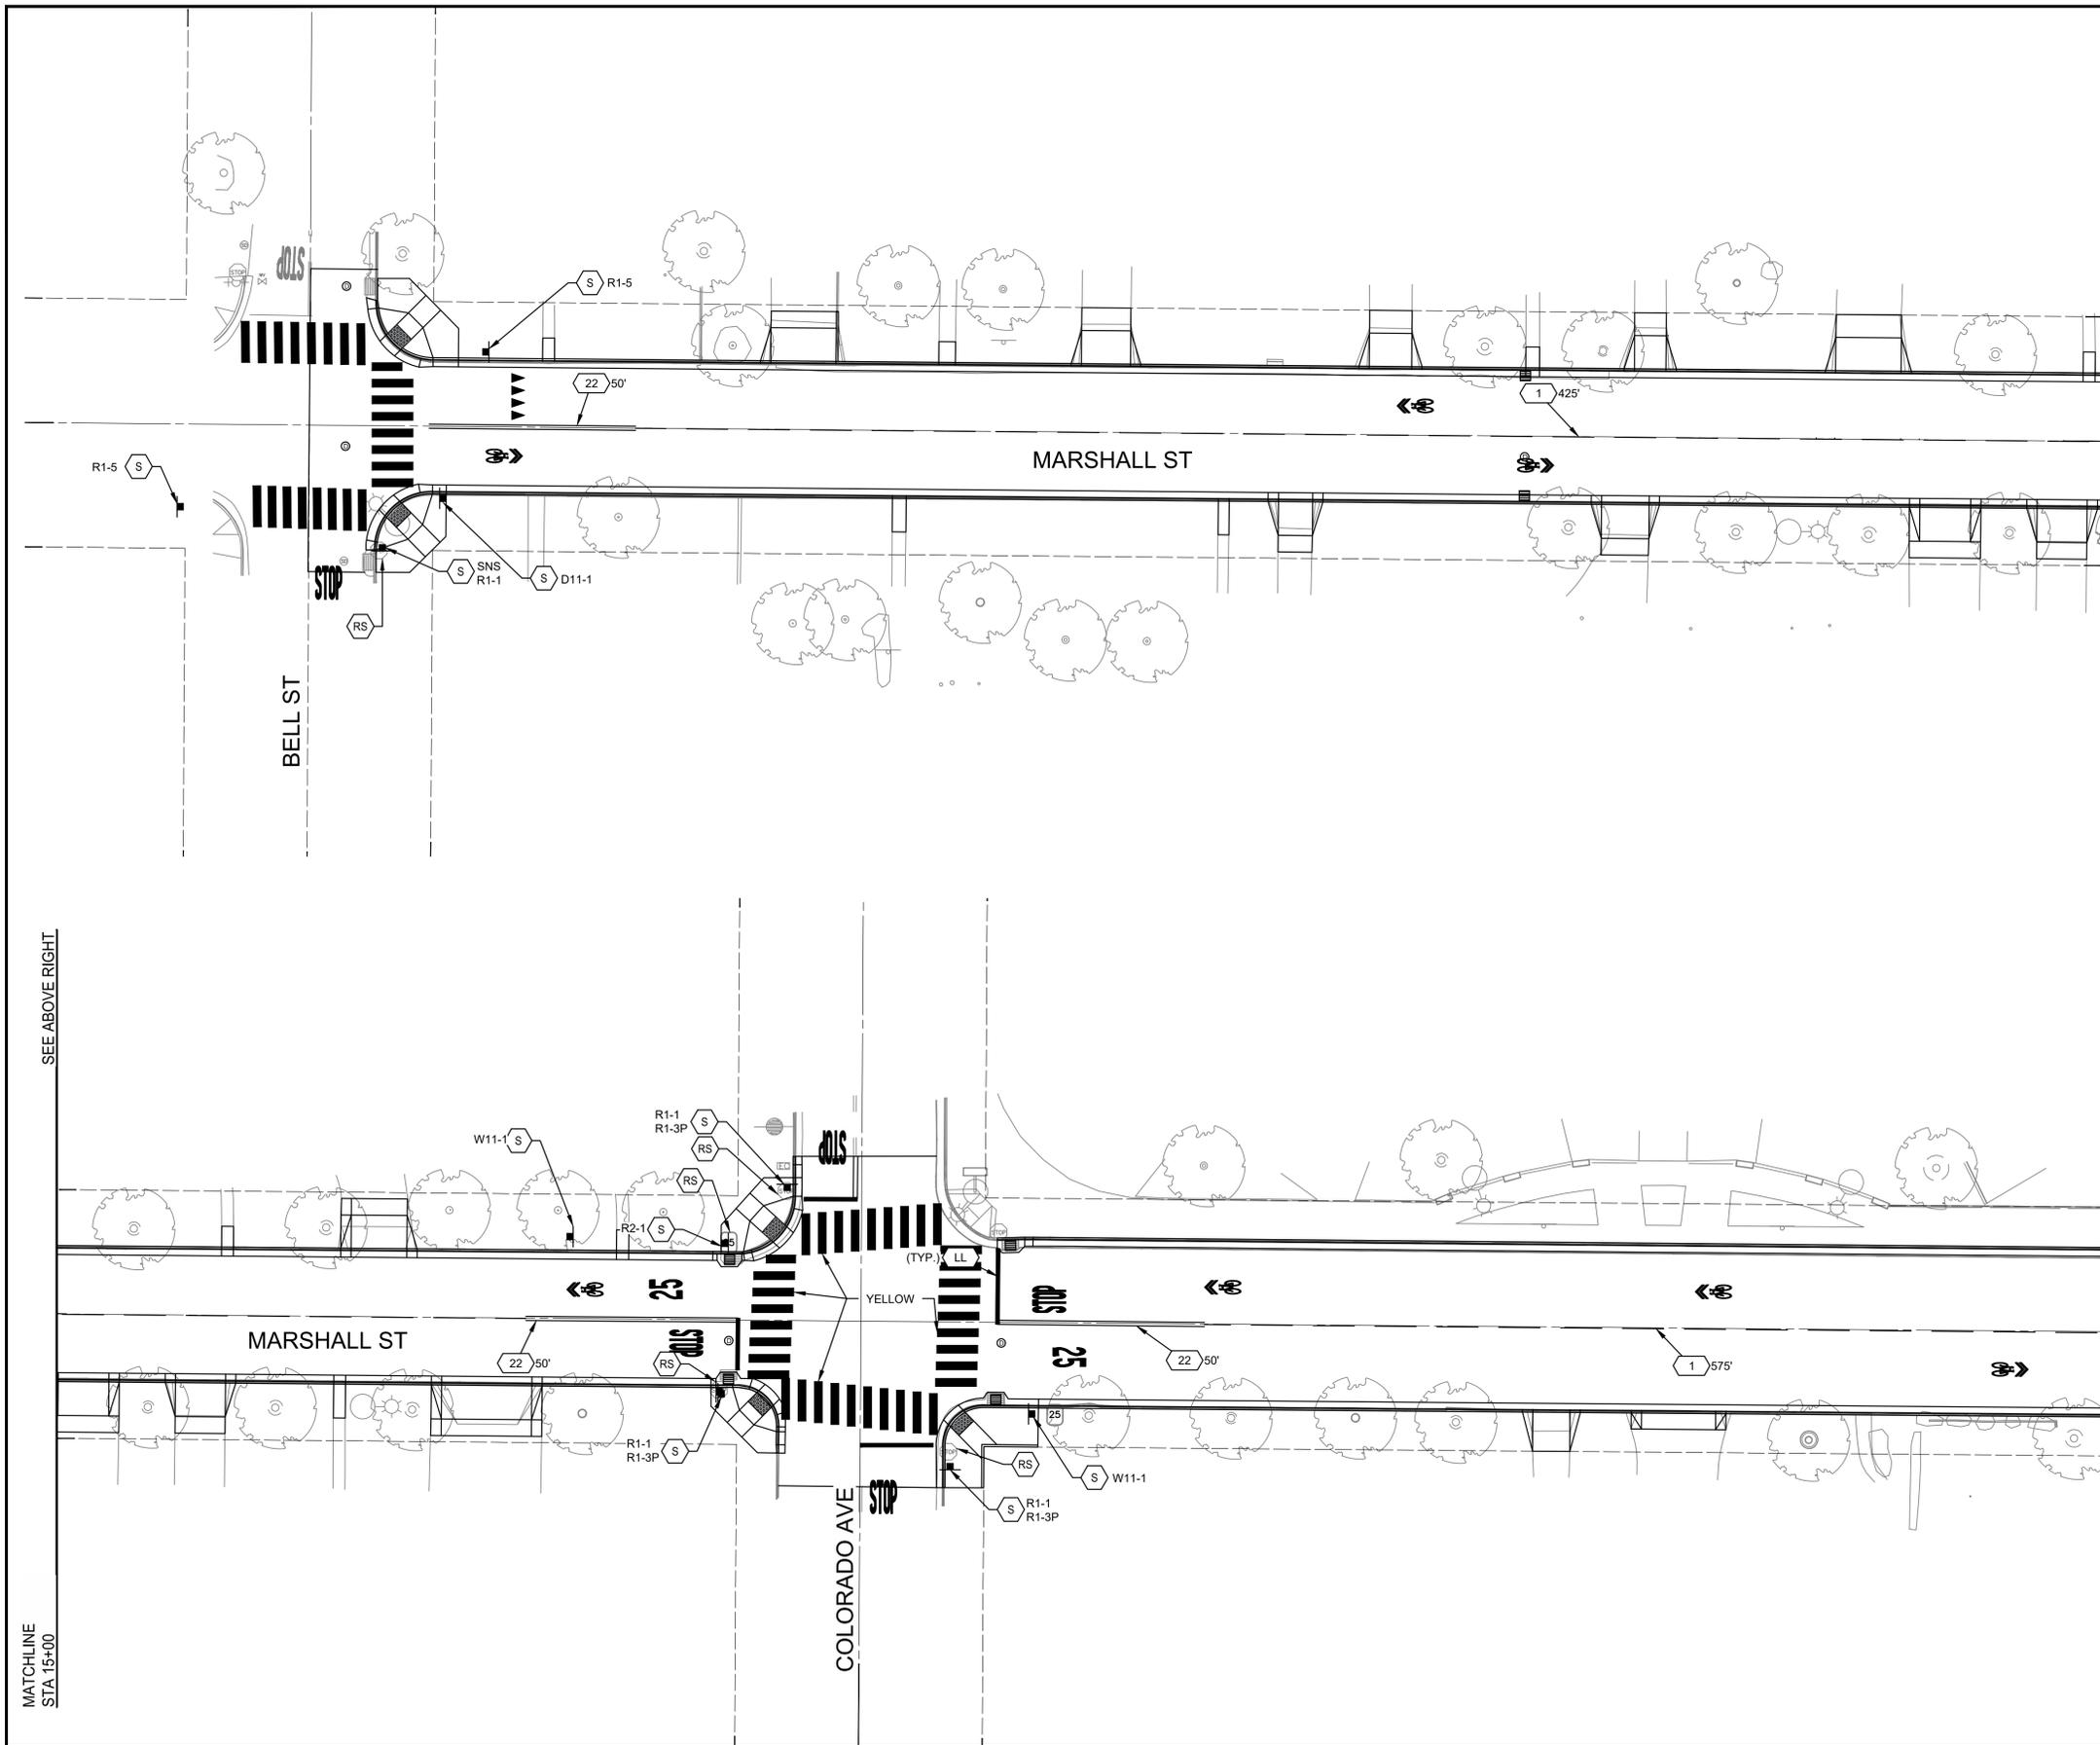
**TRAFFIC DETOUR PLAN - PHASE 7**



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1/19/2026 9:24 AM C:\Turlock\_City of 229224001\2024 Road Rehab\300 CAD\343 Sheet Set\08\_Traffic Handling\TH8 TRAFFIC HANDLING.dwg -Amenemate Fox



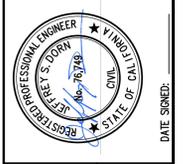


SEE BELOW LEFT

MATCHLINE  
STA 15+00

SEE ABOVE RIGHT

MATCHLINE  
STA 20+00

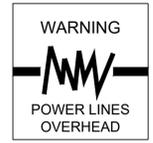

**LEGEND**


- CROSSWALK PER CITY OF TURLOCK STD C-17 ON DETAIL SHEET D2 AND LOCATION PER DETAIL A AND B ON SHEET D5.
- TRAFFIC LINE DETAIL PER CALTRANS STD. PLANS
- TYPE IV (L) ARROW PER CALTRANS STD. PLANS DETAIL A24A
- "STOP" MARKING PER CALTRANS STD. PLANS DETAIL A24D AND LOCATION PER DETAIL A AND B ON SHEET D5.
- SHARED ROADWAY BICYCLE MARKING PER CALTRANS STD. PLANS DETAIL A24C
- YIELD LINE MARKING PER CALTRANS STD. PLANS DETAIL A24G
- REMOVE ROADSIDE SIGN
- RELOCATE ROADSIDE SIGN AS SHOWN ON PLANS.
- FURNISH AND INSTALL ROADSIDE SIGN. SIGN DESIGNATION AS SHOWN ON PLANS.

**NOTES**

1. ALL TRAFFIC STRIPING AND PAVEMENT MARKINGS SHALL BE THERMOPLASTIC

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CITY OF TURLOCK  
ROADS PROGRAM CIP  
CITY PROJECT NO. 23-068, PACKAGE 3  
STRIPING  
MARSHALL ST STA 10+50 - 20+00

**PROVOST & PRITCHARD**  
425 W FIR AVENUE  
TURLOCK, CA 95259  
PHONE (559) 449-2700  
FAX (559) 449-2715  
www.provostandpritchard.com

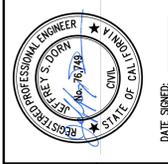DESIGN ENGINEER:  
JEFF DORN  
LICENSE NO:  
76,749


DRAFTED BY: AR  
CHECKED BY: JD

DATE: JAN 2026  
JOB NO: 229224001


PROJECT NO: 229224001  
PHASE: 3

ORIGINAL SCALE SHOWN IS ONE INCH. ADJUST SCALE FOR REDUCED OR ENLARGED PLANS.

SHEET **S-1**  
63 OF 78

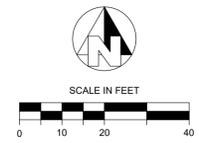

CITY OF TURLOCK  
MUNICIPAL SERVICES DEPARTMENT  
ROADS PROGRAM DIVISION  
156 S. BROADWAY, SUITE 150  
(209) 668-5520

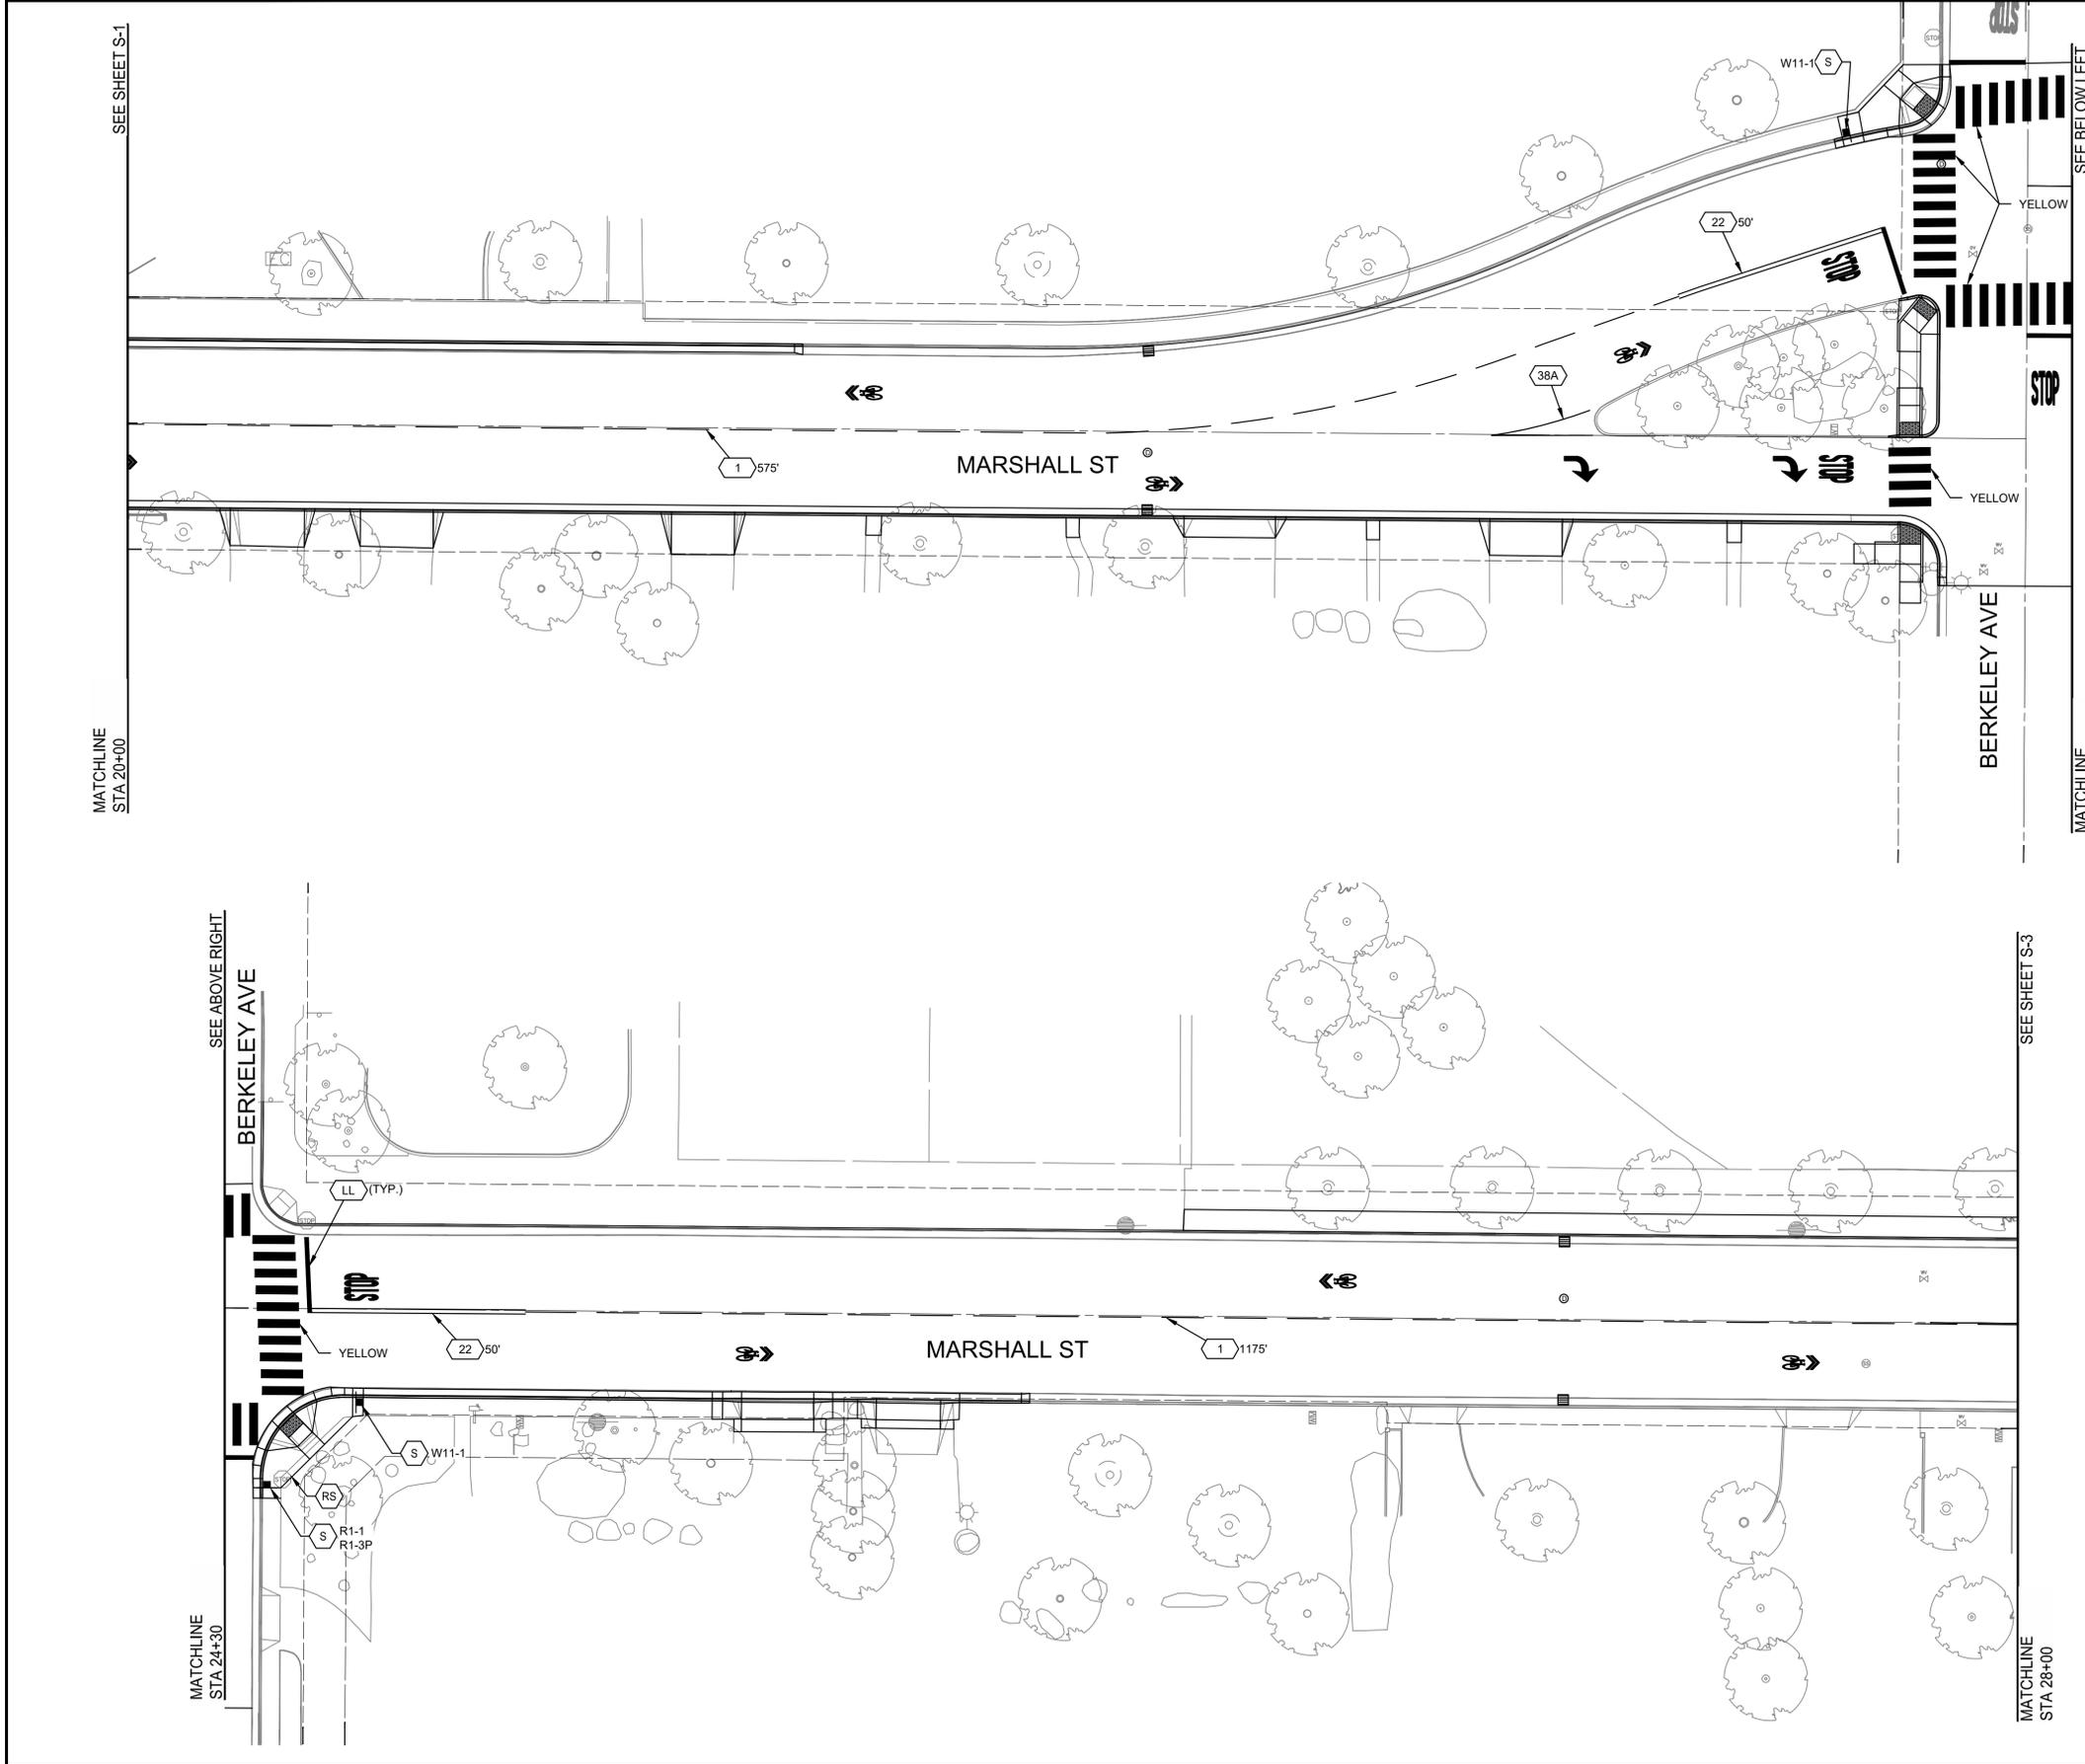


- LEGEND**
- CROSSWALK PER CITY OF TURLOCK STD C-17 ON DETAIL SHEET D2 AND LOCATION PER DETAIL A AND B ON SHEET D5.
  - TRAFFIC LINE DETAIL PER CALTRANS STD. PLANS
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  - SHARED ROADWAY BICYCLE MARKING PER CALTRANS STD. PLANS DETAIL A24C
  - YIELD LINE MARKING PER CALTRANS STD. PLANS DETAIL A24G
  - REMOVE ROADSIDE SIGN
  - RELOCATE ROADSIDE SIGN AS SHOWN ON PLANS.
  - FURNISH AND INSTALL ROADSIDE SIGN. SIGN DESIGNATION AS SHOWN ON PLANS.

- NOTES**
1. ALL TRAFFIC STRIPING AND PAVEMENT MARKINGS SHALL BE THERMOPLASTIC

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1/22/2026

CITY OF TURLOCK  
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CITY PROJECT No. 23-068, PACKAGE 3  
STRIPING

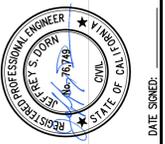MARSHALL ST STA 20+00 - 24+30

**PROVOST & PRITCHARD**  
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TURLOCK, CA 95259  
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www.provostandpritchard.com

DESIGN ENGINEER:  
JEFF DORN  
LICENSE NO:  
76,749

DRAFTED BY: AR  
CHECKED BY: JD

DATE: JAN 2026


JOB NO: 229224001

PROJECT NO: 229224001

PHASE: 3


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SHEET **S-2**  
64 OF 78

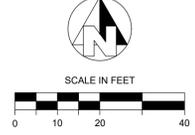

CITY OF TURLOCK  
MUNICIPAL SERVICES DEPARTMENT  
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SEE SHEET S-2

MATCHLINE  
STA 28+00


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MATCHLINE  
STA 33+00
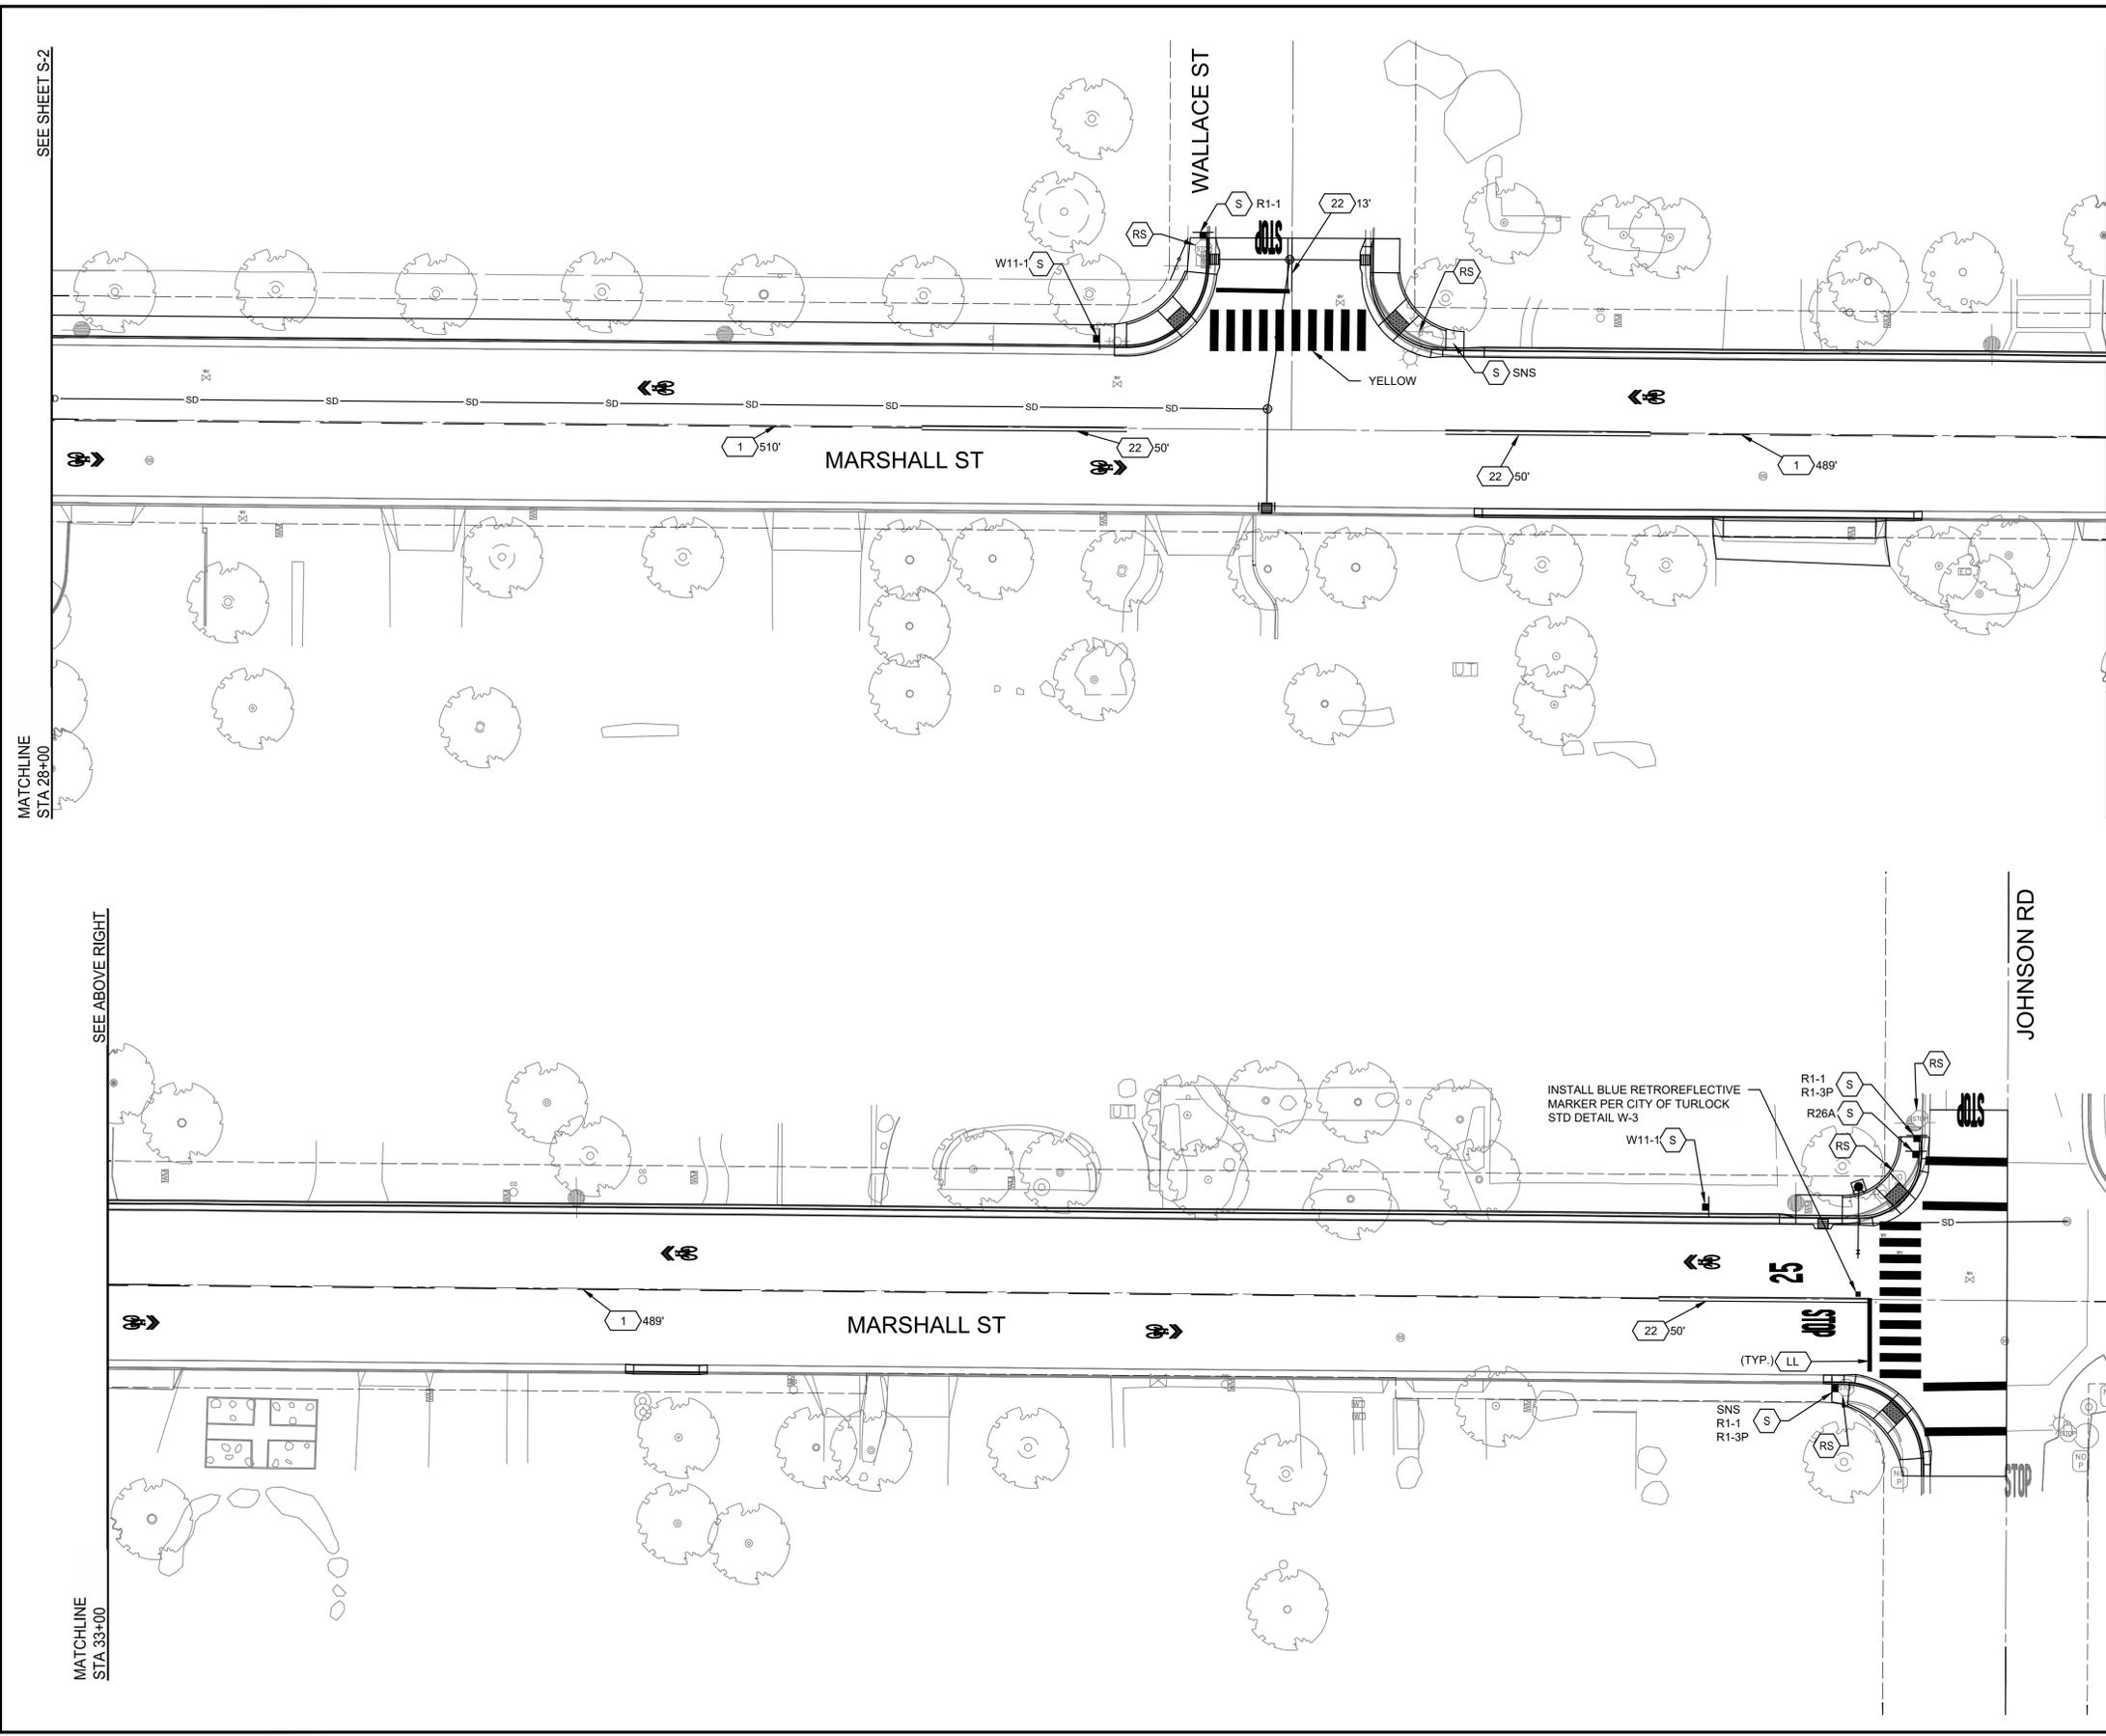
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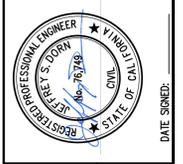
- LEGEND**
- CROSSWALK PER CITY OF TURLOCK STD C-17 ON DETAIL SHEET D2 AND LOCATION PER DETAIL A AND B ON SHEET D5.
  - TRAFFIC LINE DETAIL PER CALTRANS STD. PLANS
  - TYPE IV (L) ARROW PER CALTRANS STD. PLANS DETAIL A24A
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  - SHARED ROADWAY BICYCLE MARKING PER CALTRANS STD. PLANS DETAIL A24C
  - YIELD LINE MARKING PER CALTRANS STD. PLANS DETAIL A24G
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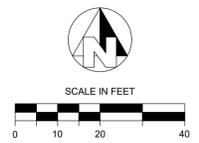
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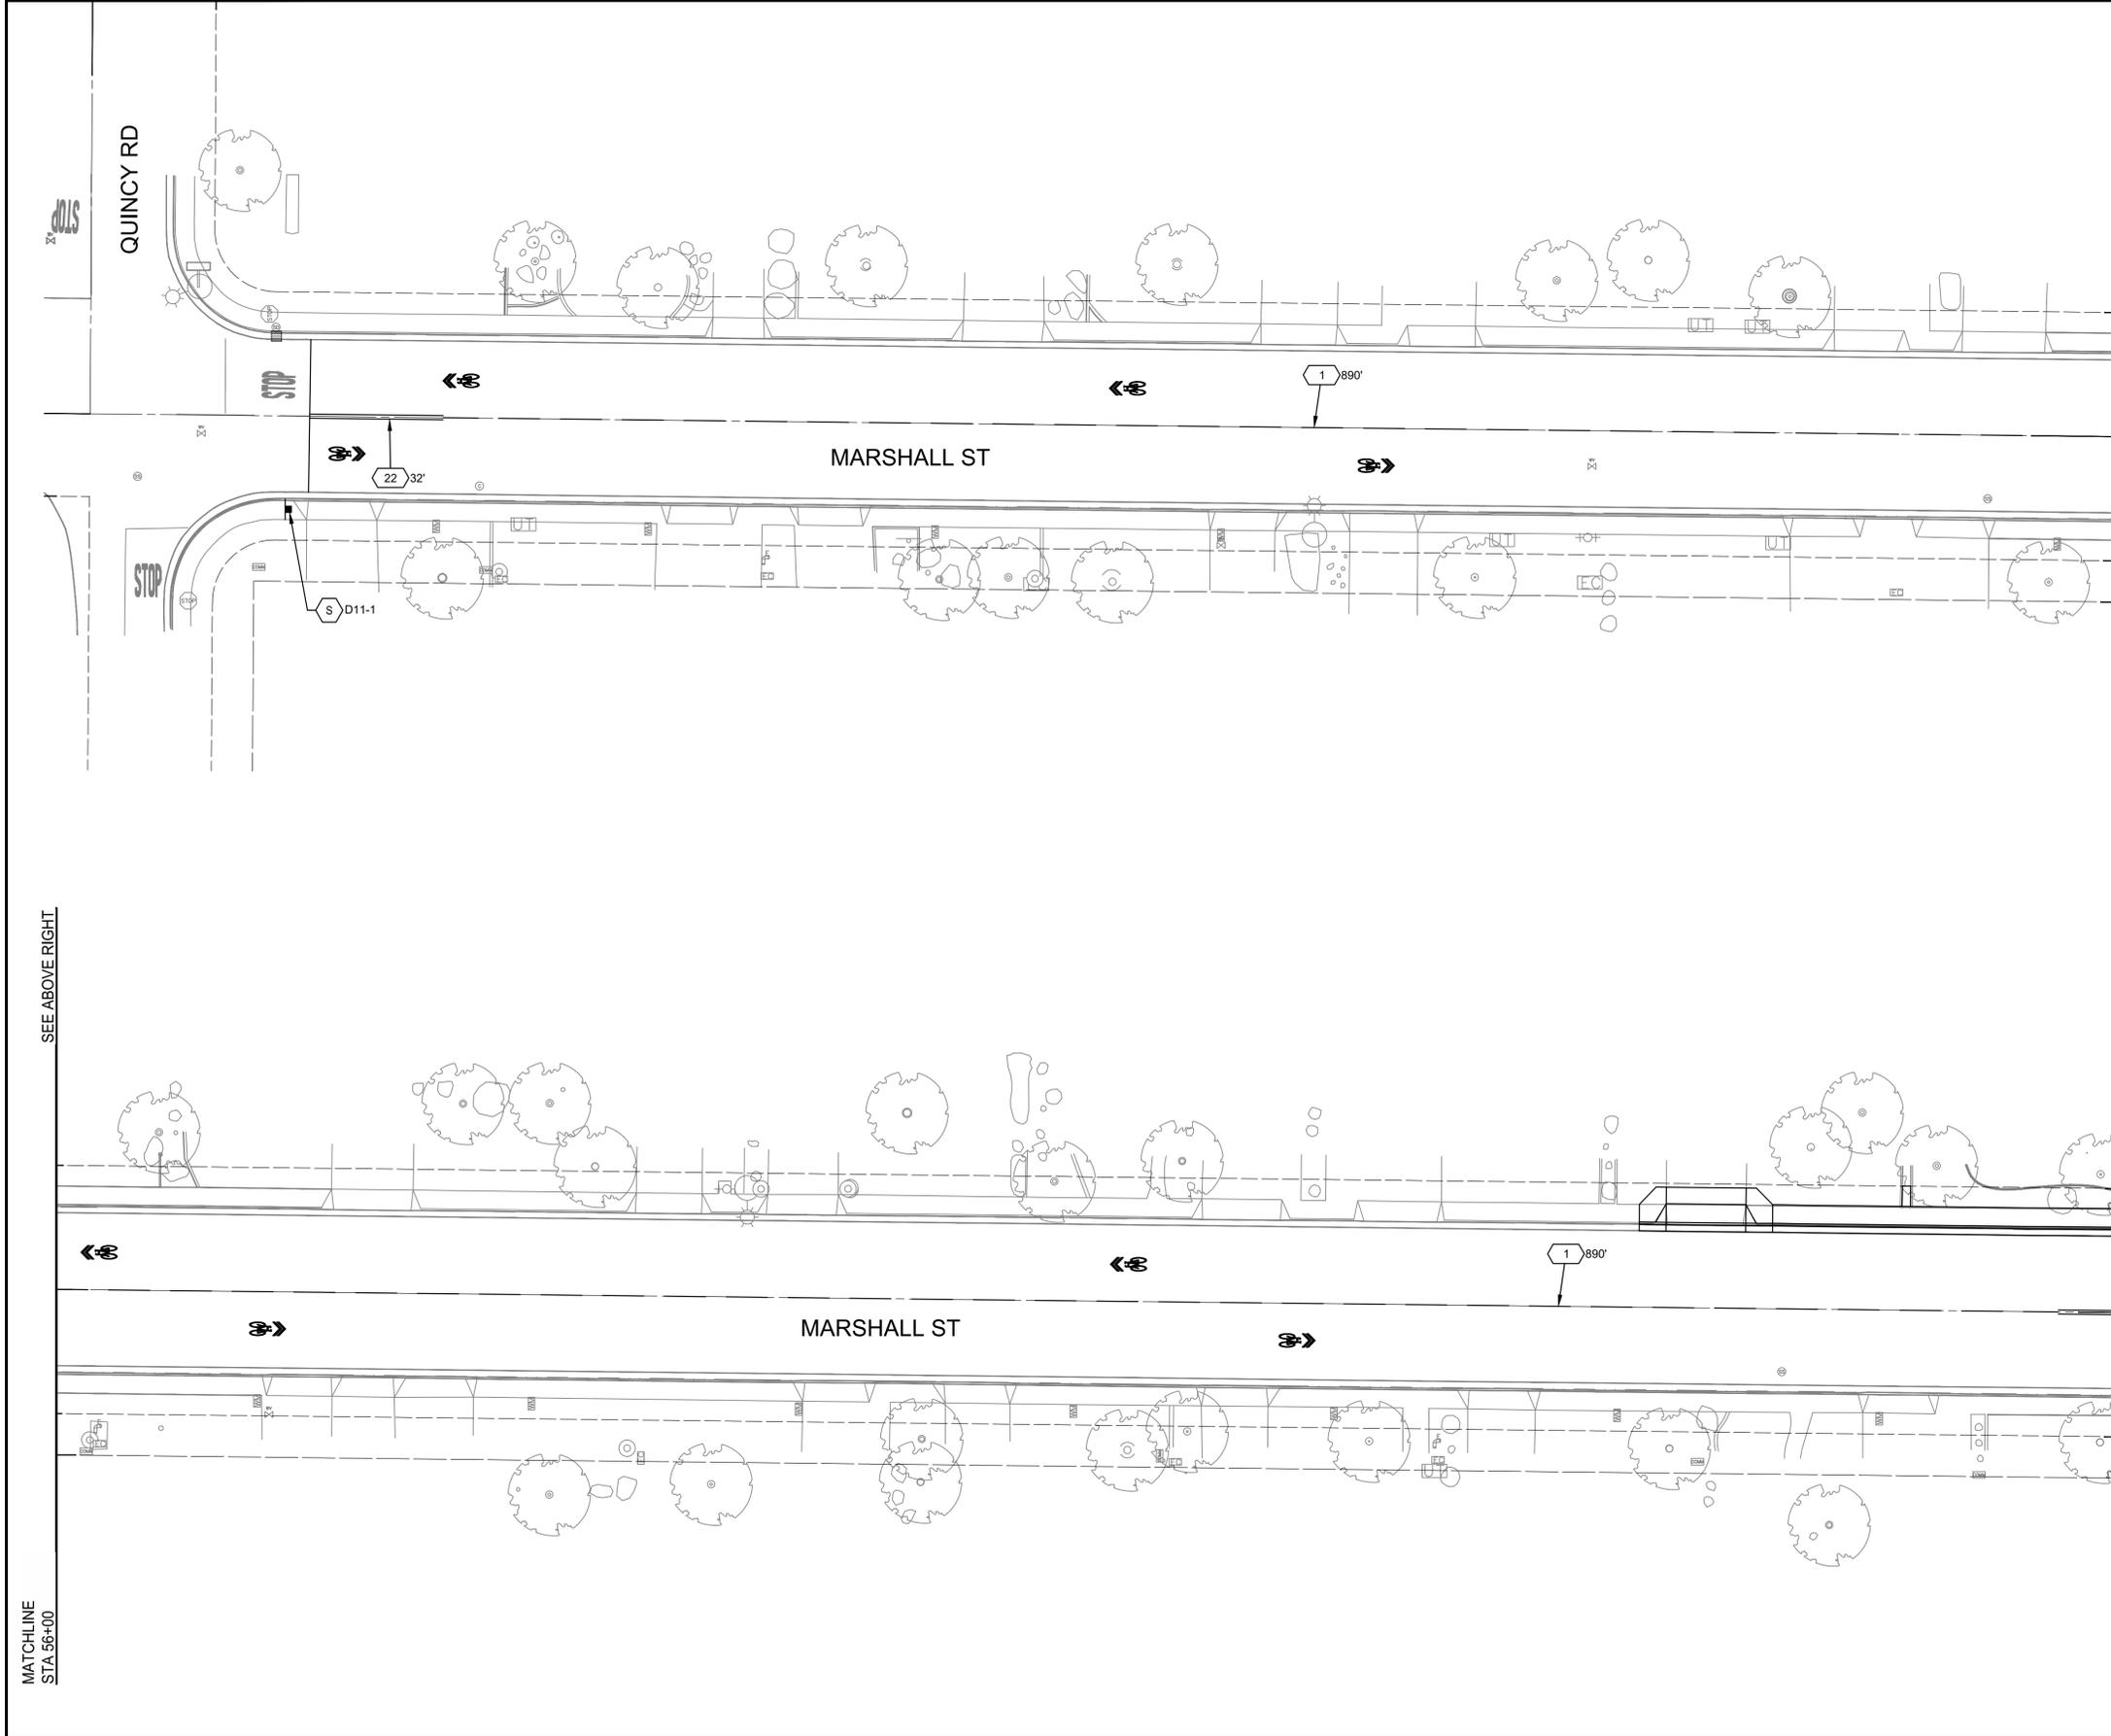


CITY OF TURLOCK  
ROADS PROGRAM CIP  
CITY PROJECT No. 23-068, PACKAGE 3  
STRIPING  
MARSHALL ST STA 28+00 - 38+00

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DESIGN ENGINEER:	JEFF DORN
LICENSE NO.:	76,749
DRAFTED BY:	AR
CHECKED BY:	JD
DATE:	JAN 2026
JOB NO.:	229224001
PROJECT NO.:	229224001
PHASE:	3
ORIGINAL SCALE SHOWN IS ONE INCH. ADJUST SCALE FOR REDUCED OR ENLARGED PLANS.	
SHEET	<b>S-3</b>
65	OF 78

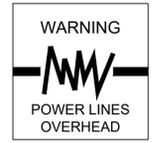

CITY OF TURLOCK  
MUNICIPAL SERVICES DEPARTMENT  
ROADS PROGRAM DIVISION  
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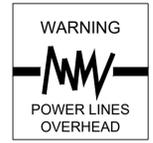
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MATCHLINE  
STA 56+00

SEE SHEET S-5

MATCHLINE  
STA 56+00

SEE BELOW LEFT




**LEGEND**

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- TRAFFIC LINE DETAIL PER CALTRANS STD. PLANS
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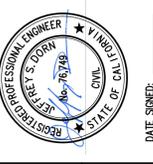


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1/22/2026

NO.	REVISION	BY	DATE

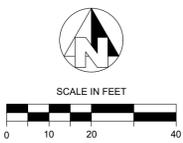

CITY OF TURLOCK  
ROADS PROGRAM CIP  
CITY PROJECT No. 23-068, PACKAGE 3  
STRIPING  
MARSHALL ST STA 51+00 - 56+00

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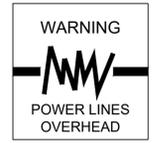
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CHECKED BY: JD

DATE: JAN 2026  
JOB NO: 229224001

PROJECT NO: 229224001  
PHASE: 3

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SHEET **S-4**  
66 OF 78



LEGEND



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- TRAFFIC LINE DETAIL PER CALTRANS STD. PLANS
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NOTES

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SEE SHEET S-4

MATCHLINE STA 61+00



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MUNICIPAL SERVICES DEPARTMENT  
ROADS PROGRAM DIVISION  
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**PROVOST & PRITCHARD**  
425 W FIR AVENUE  
CITY OF TURLOCK, CA 95260  
PHONE (559) 449-2700  
FAX (559) 449-2715  
www.provostandpritchard.com

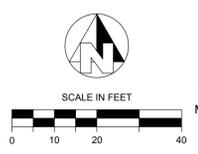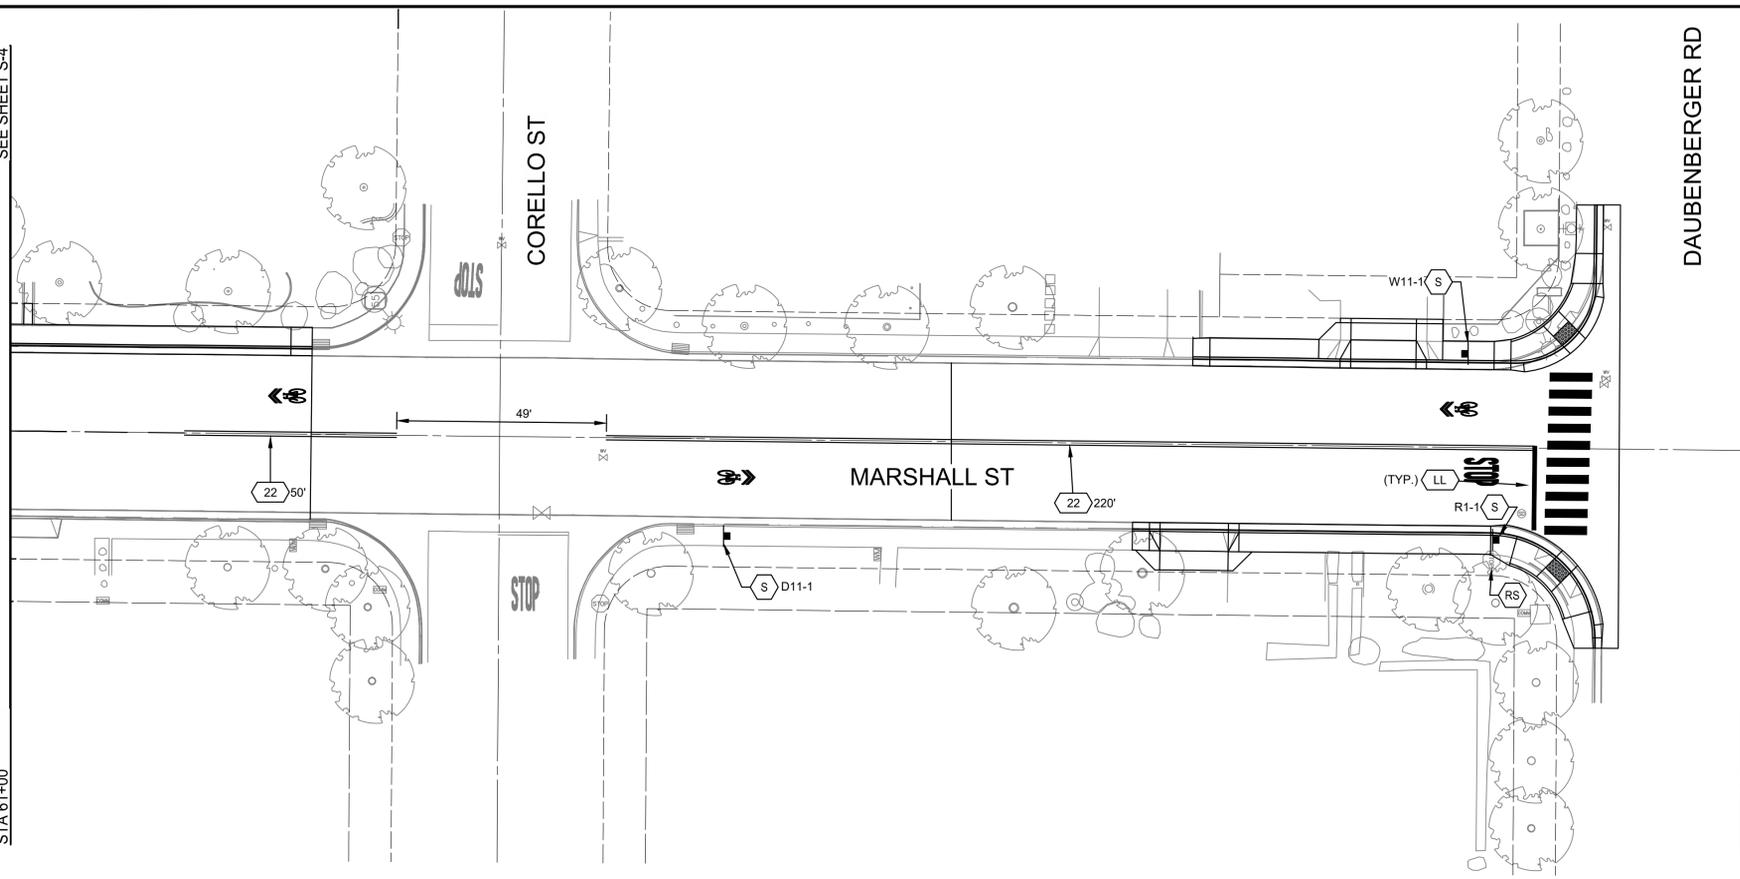DESIGN ENGINEER:  
JEFF DORN  
LICENSE NO:  
76,749

DRAFTED BY: AR      CHECKED BY: JD

DATE: JAN 2026

JOB NO: 229224001

PROJECT NO: 229224001


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0      1"  
INCH ADJUST SCALE FOR  
REDUCED OR ENLARGED PLANS.

ORIGINAL SCALE SHOWN IS ONE  
INCH ADJUST SCALE FOR  
REDUCED OR ENLARGED PLANS.  
SHEET **S-5**  
67 OF 78

CITY OF TURLOCK  
ROADS PROGRAM CIP  
CITY PROJECT No. 23-068, PACKAGE 3  
STRIPING


MARSHALL ST STA 61+00 - 64+53

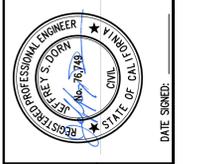

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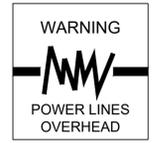
**LEGEND**

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-  REMOVE ROADSIDE SIGN
-  RELOCATE ROADSIDE SIGN AS SHOWN ON PLANS.
-  FURNISH AND INSTALL ROADSIDE SIGN. SIGN DESIGNATION AS SHOWN ON PLANS.

**NOTES**

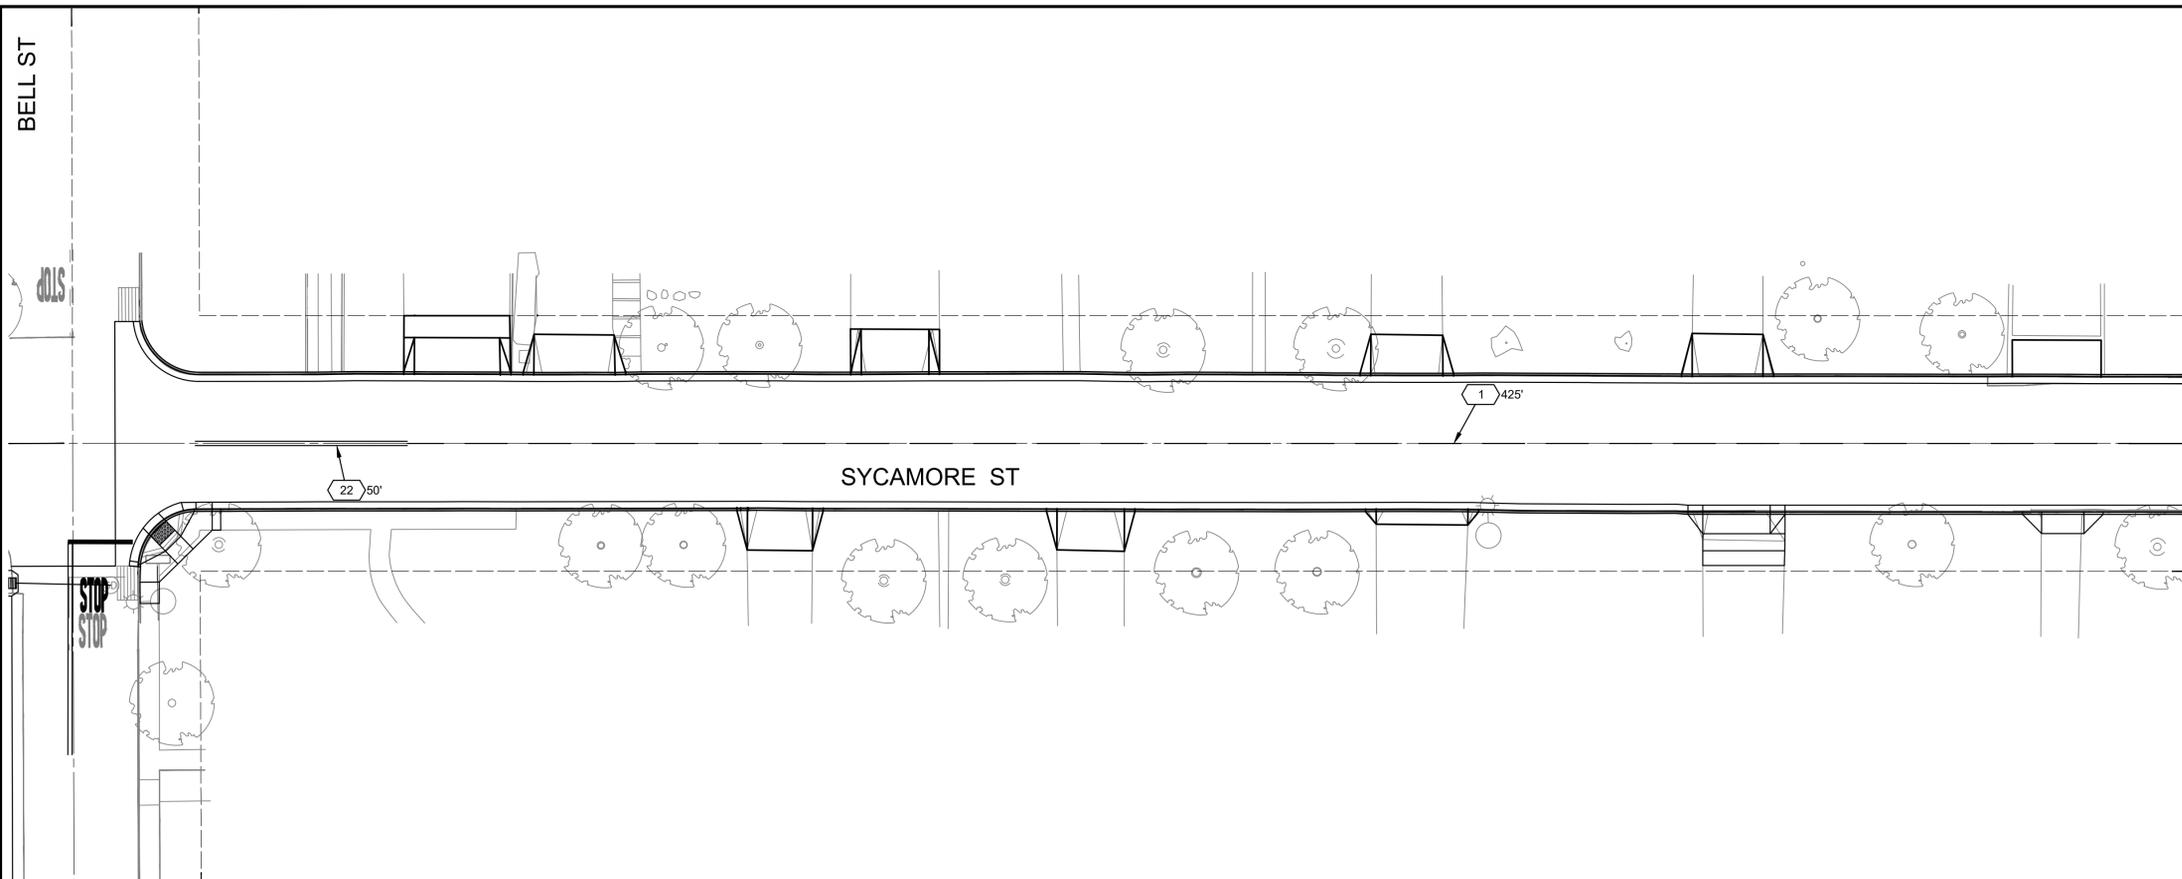
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CITY OF TURLOCK  
ROADS PROGRAM CIP  
CITY PROJECT No. 23-068, PACKAGE 3  
STRIPING  
SYCAMORE ST STA 71+00 - 76+00

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TURLOCK, CA 95259  
PHONE (559) 449-2700  
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www.provostandpritchard.com

DESIGN ENGINEER:  
JEFF DORN  
LICENSE NO:  
76,749

DRAFTED BY: AR CHECKED BY: JD

DATE: JAN 2026

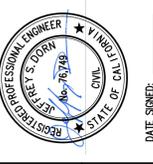
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PROJECT NO: 229224001


PHASE: 3

0" = 1"  
ORIGINAL SCALE SHOWN IS ONE INCH. ADJUST SCALE FOR REDUCED OR ENLARGED PLANS.

SHEET **S-6**  
68 OF 78

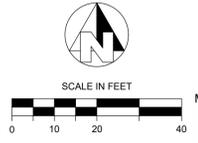

CITY OF TURLOCK  
MUNICIPAL SERVICES DEPARTMENT  
ROADS PROGRAM DIVISION  
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(209) 668-5520

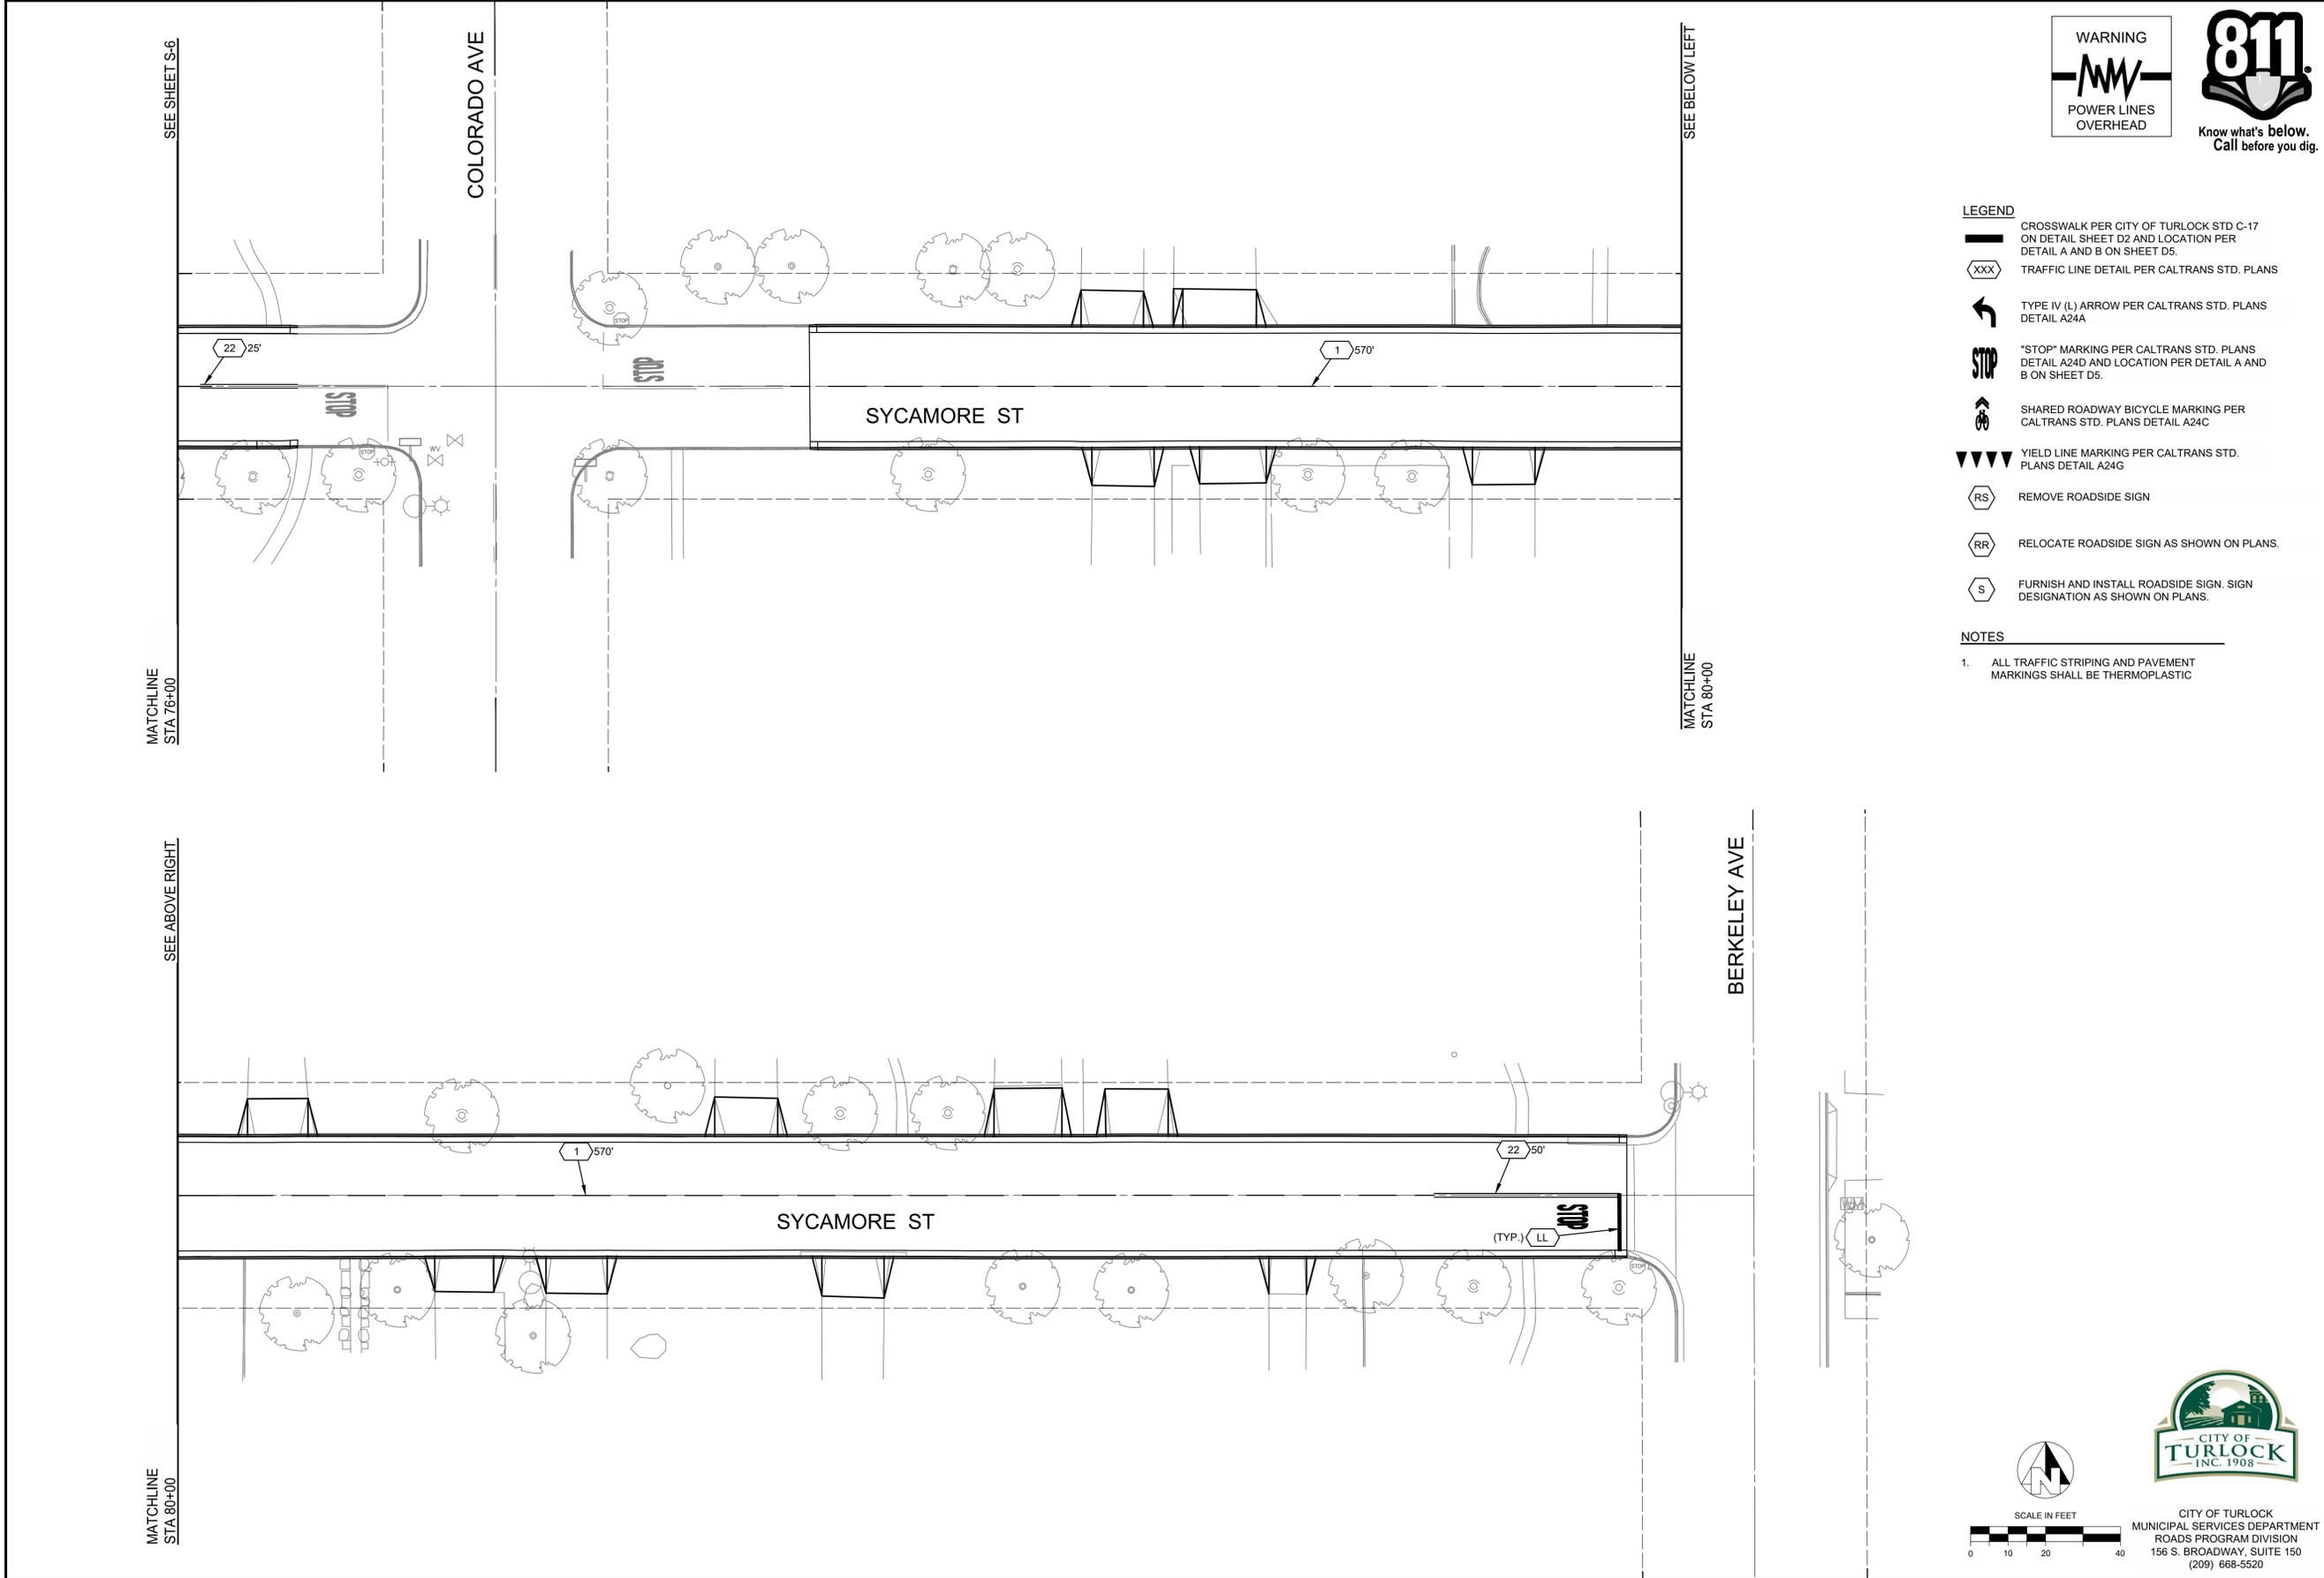


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CITY OF TURLOCK  
ROADS PROGRAM CIP  
CITY PROJECT No. 23-068, PACKAGE 3  
STRIPING  
SYCAMORE ST STA 76+00 - 80+00

**PROVOST & PRITCHARD**  
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TURLOCK, CA 95259  
PHONE (559) 449-2700  
FAX (559) 449-2719  
www.provostandpritchard.com

DESIGN ENGINEER:  
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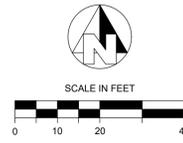
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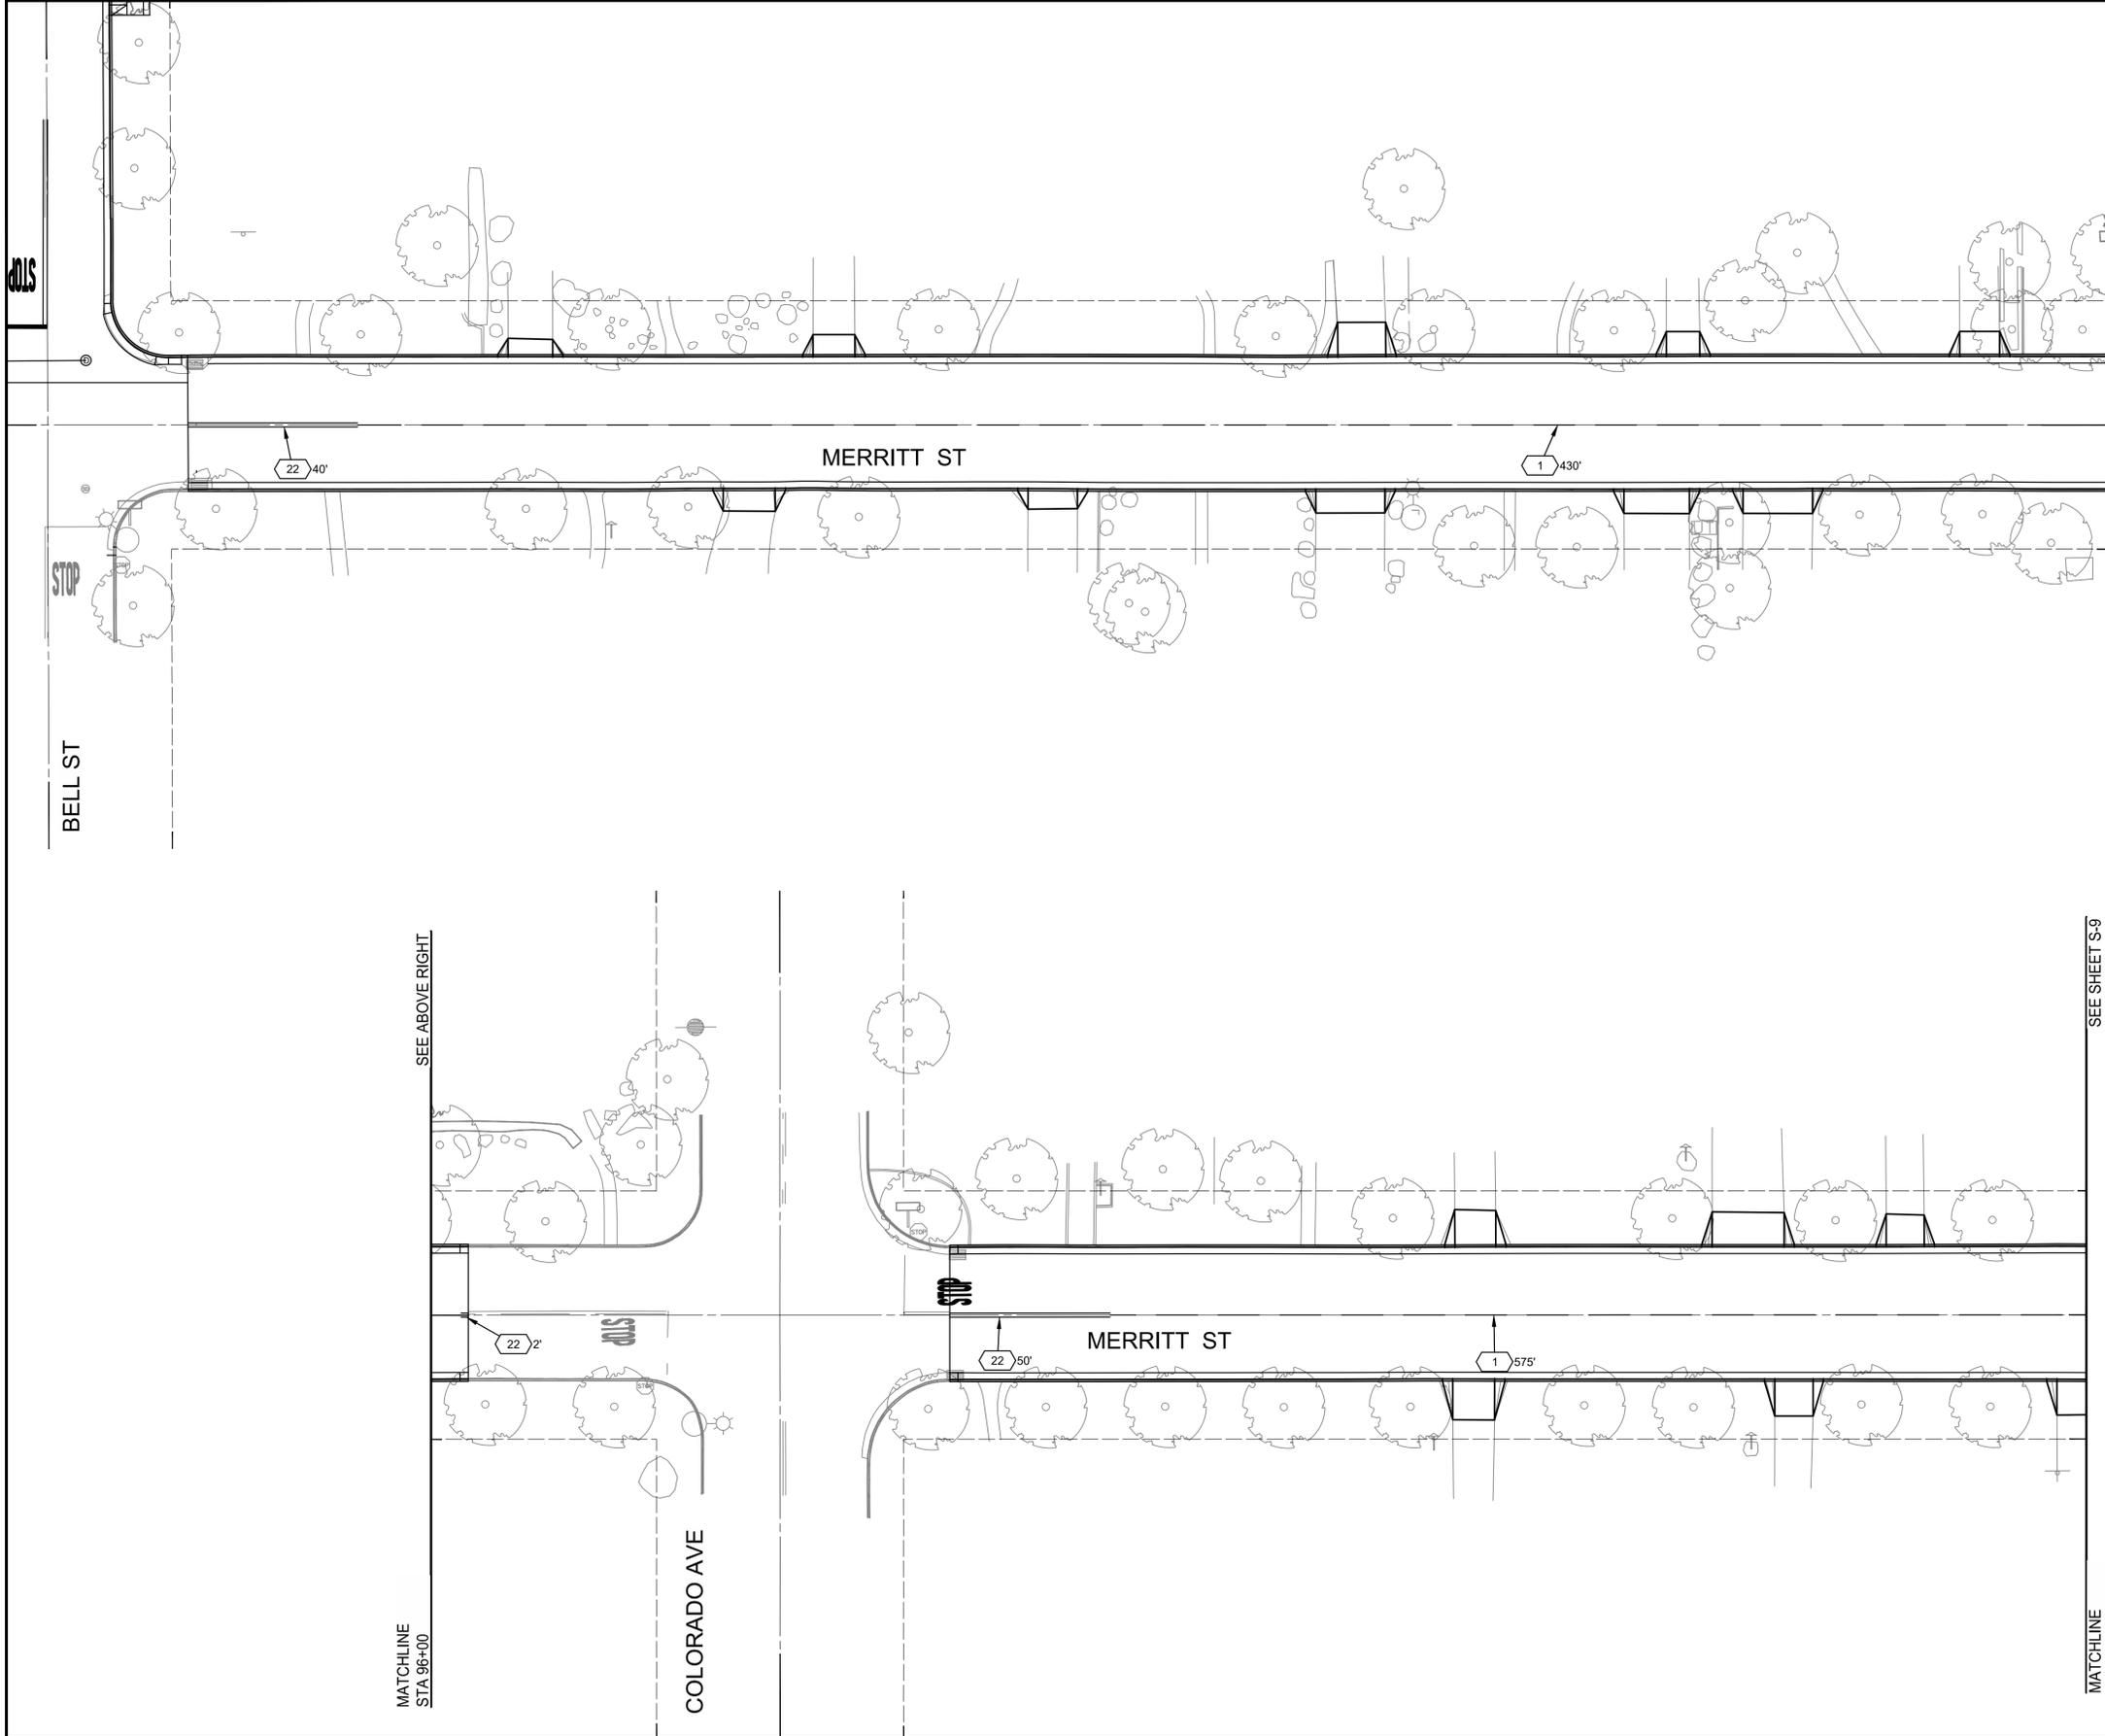
PROJECT NO: 229224001  
PHASE: 3

0" = 1"  
ORIGINAL SCALE SHOWN IS ONE INCH. ADJUST SCALE FOR REDUCED OR ENLARGED PLANS.

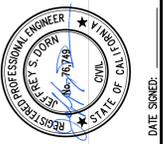SHEET **S-7**  
69 OF 78



CITY OF TURLOCK  
MUNICIPAL SERVICES DEPARTMENT  
ROADS PROGRAM DIVISION  
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(209) 668-5520



SEE BELOW LEFT

MATCHLINE STA 96+00


SEE SHEET S-9

MATCHLINE STA 100+00



- LEGEND**
- CROSSWALK PER CITY OF TURLOCK STD C-17 ON DETAIL SHEET D2 AND LOCATION PER DETAIL A AND B ON SHEET D5.
  - TRAFFIC LINE DETAIL PER CALTRANS STD. PLANS
  - TYPE IV (L) ARROW PER CALTRANS STD. PLANS DETAIL A24A
  - "STOP" MARKING PER CALTRANS STD. PLANS DETAIL A24D AND LOCATION PER DETAIL A AND B ON SHEET D5.
  - SHARED ROADWAY BICYCLE MARKING PER CALTRANS STD. PLANS DETAIL A24C
  - YIELD LINE MARKING PER CALTRANS STD. PLANS DETAIL A24G
  - REMOVE ROADSIDE SIGN
  - RELOCATE ROADSIDE SIGN AS SHOWN ON PLANS.
  - FURNISH AND INSTALL ROADSIDE SIGN. SIGN DESIGNATION AS SHOWN ON PLANS.


- NOTES**
1. ALL TRAFFIC STRIPING AND PAVEMENT MARKINGS SHALL BE THERMOPLASTIC

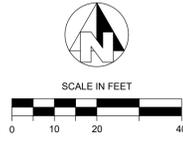

CITY OF TURLOCK  
MUNICIPAL SERVICES DEPARTMENT  
ROADS PROGRAM DIVISION  
156 S. BROADWAY, SUITE 150  
(209) 668-5520

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NO.	REVISION	BY	DATE
	BID SET		1/22/2026

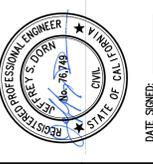

CITY OF TURLOCK  
ROADS PROGRAM CIP  
CITY PROJECT No. 23-068, PACKAGE 3  
STRIPING  
MERRITT ST STA 91+00 - 100+00

**PROVOST & PRITCHARD**  
425 W. FIR AVENUE, SUITE 100  
TURLOCK, CA 95259  
PHONE (209) 448-2700  
FAX (209) 448-2715  
www.provostandpritchard.com

DESIGN ENGINEER:  
JEFF DORN  
LICENSE NO:  
76,749


DRAFTED BY: AR  
CHECKED BY: JD

DATE: JAN 2026  
JOB NO: 229224001

PROJECT NO: 229224001  
PHASE: 3


ORIGINAL SCALE SHOWN IS ONE INCH. ADJUST SCALE FOR REDUCED OR ENLARGED PLANS.

SHEET **S-8**  
70 OF 78

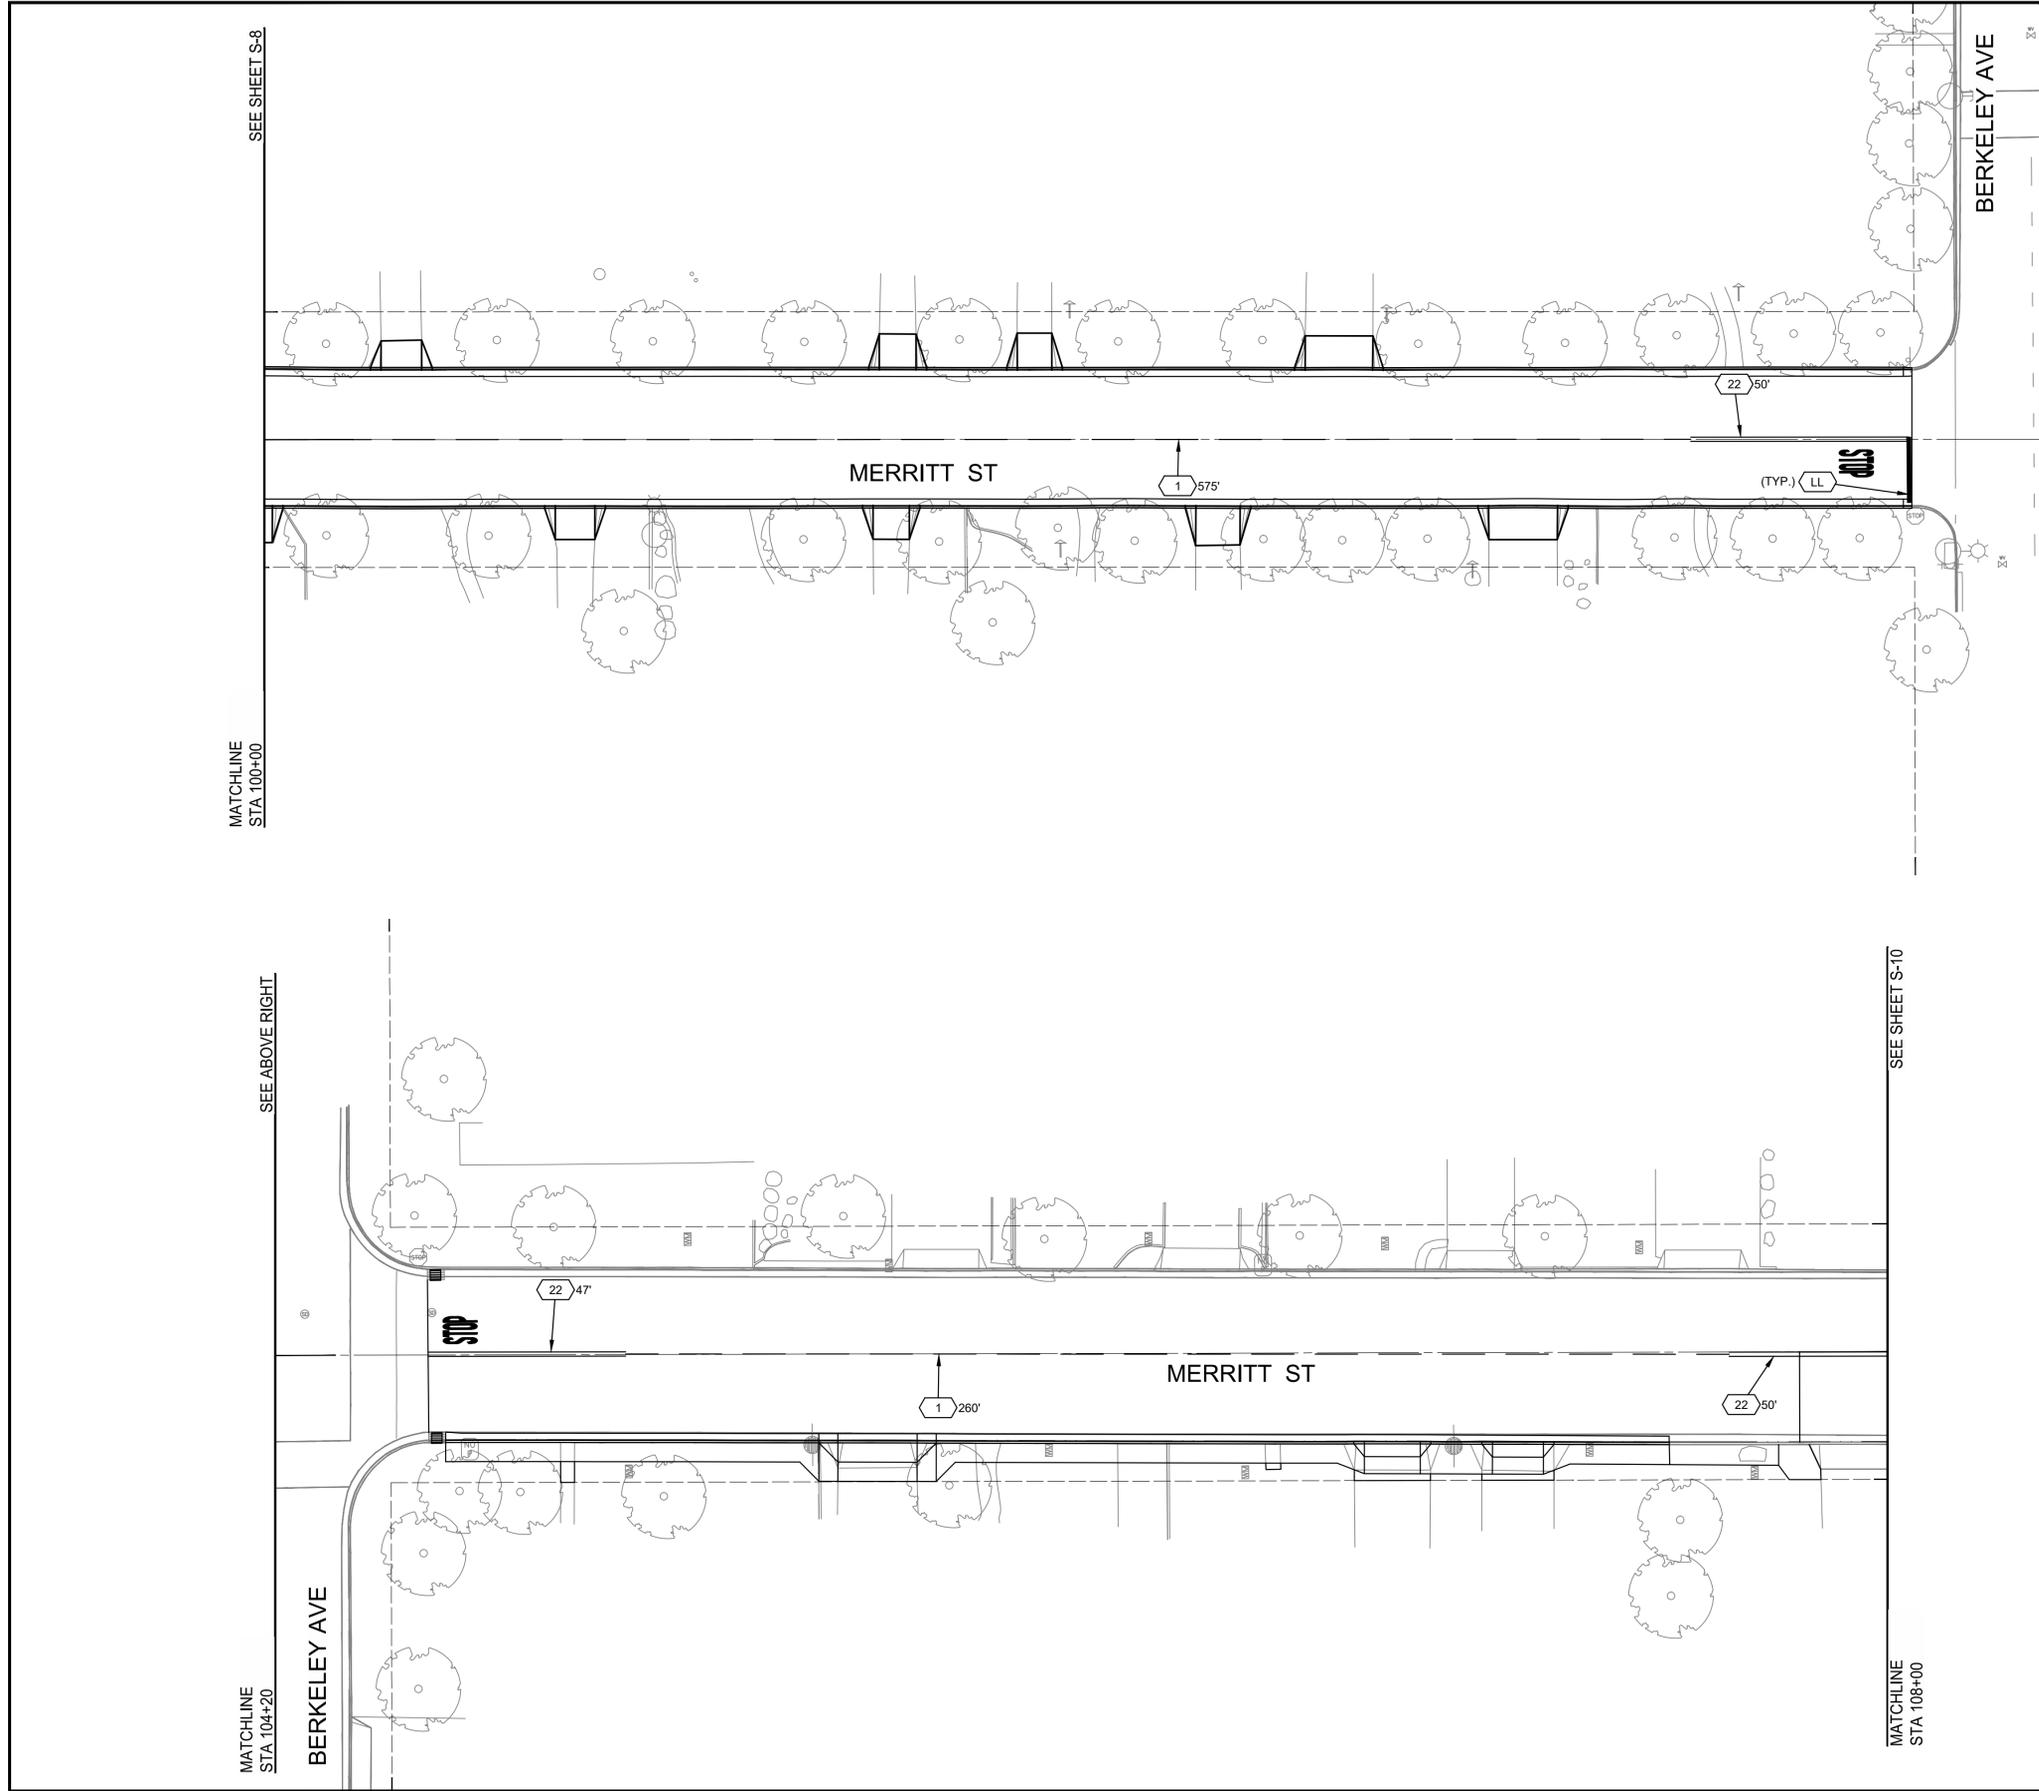

- LEGEND**
- CROSSWALK PER CITY OF TURLOCK STD C-17 ON DETAIL SHEET D2 AND LOCATION PER DETAIL A AND B ON SHEET D5.
  - TRAFFIC LINE DETAIL PER CALTRANS STD. PLANS
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  - REMOVE ROADSIDE SIGN
  - RELOCATE ROADSIDE SIGN AS SHOWN ON PLANS.
  - FURNISH AND INSTALL ROADSIDE SIGN. SIGN DESIGNATION AS SHOWN ON PLANS.


- NOTES**
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CITY OF TURLOCK  
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	BID SET		1/22/2026

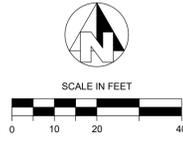

CITY OF TURLOCK  
ROADS PROGRAM CIP  
CITY PROJECT No. 23-068, PACKAGE 3  
STRIPING  
MERRITT ST STA 100+00 - 108+00

**PROVOST & PRITCHARD**  
425 W. FIR AVENUE  
TURLOCK, CA 95259  
PHONE (209) 448-2700  
FAX (209) 448-2715  
www.provostandpritchard.com

DESIGN ENGINEER:  
JEFF DORN  
LICENSE NO:  
76,749

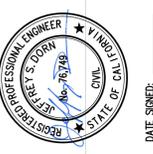
DRAFTED BY: AR  
CHECKED BY: JD

DATE: JAN 2026  
JOB NO: 229224001

PROJECT NO: 229224001  
PHASE: 3

ORIGINAL SCALE SHOWN IS ONE INCH. ADJUST SCALE FOR REDUCED OR ENLARGED PLANS.

SHEET **S-9**  
71 OF 78

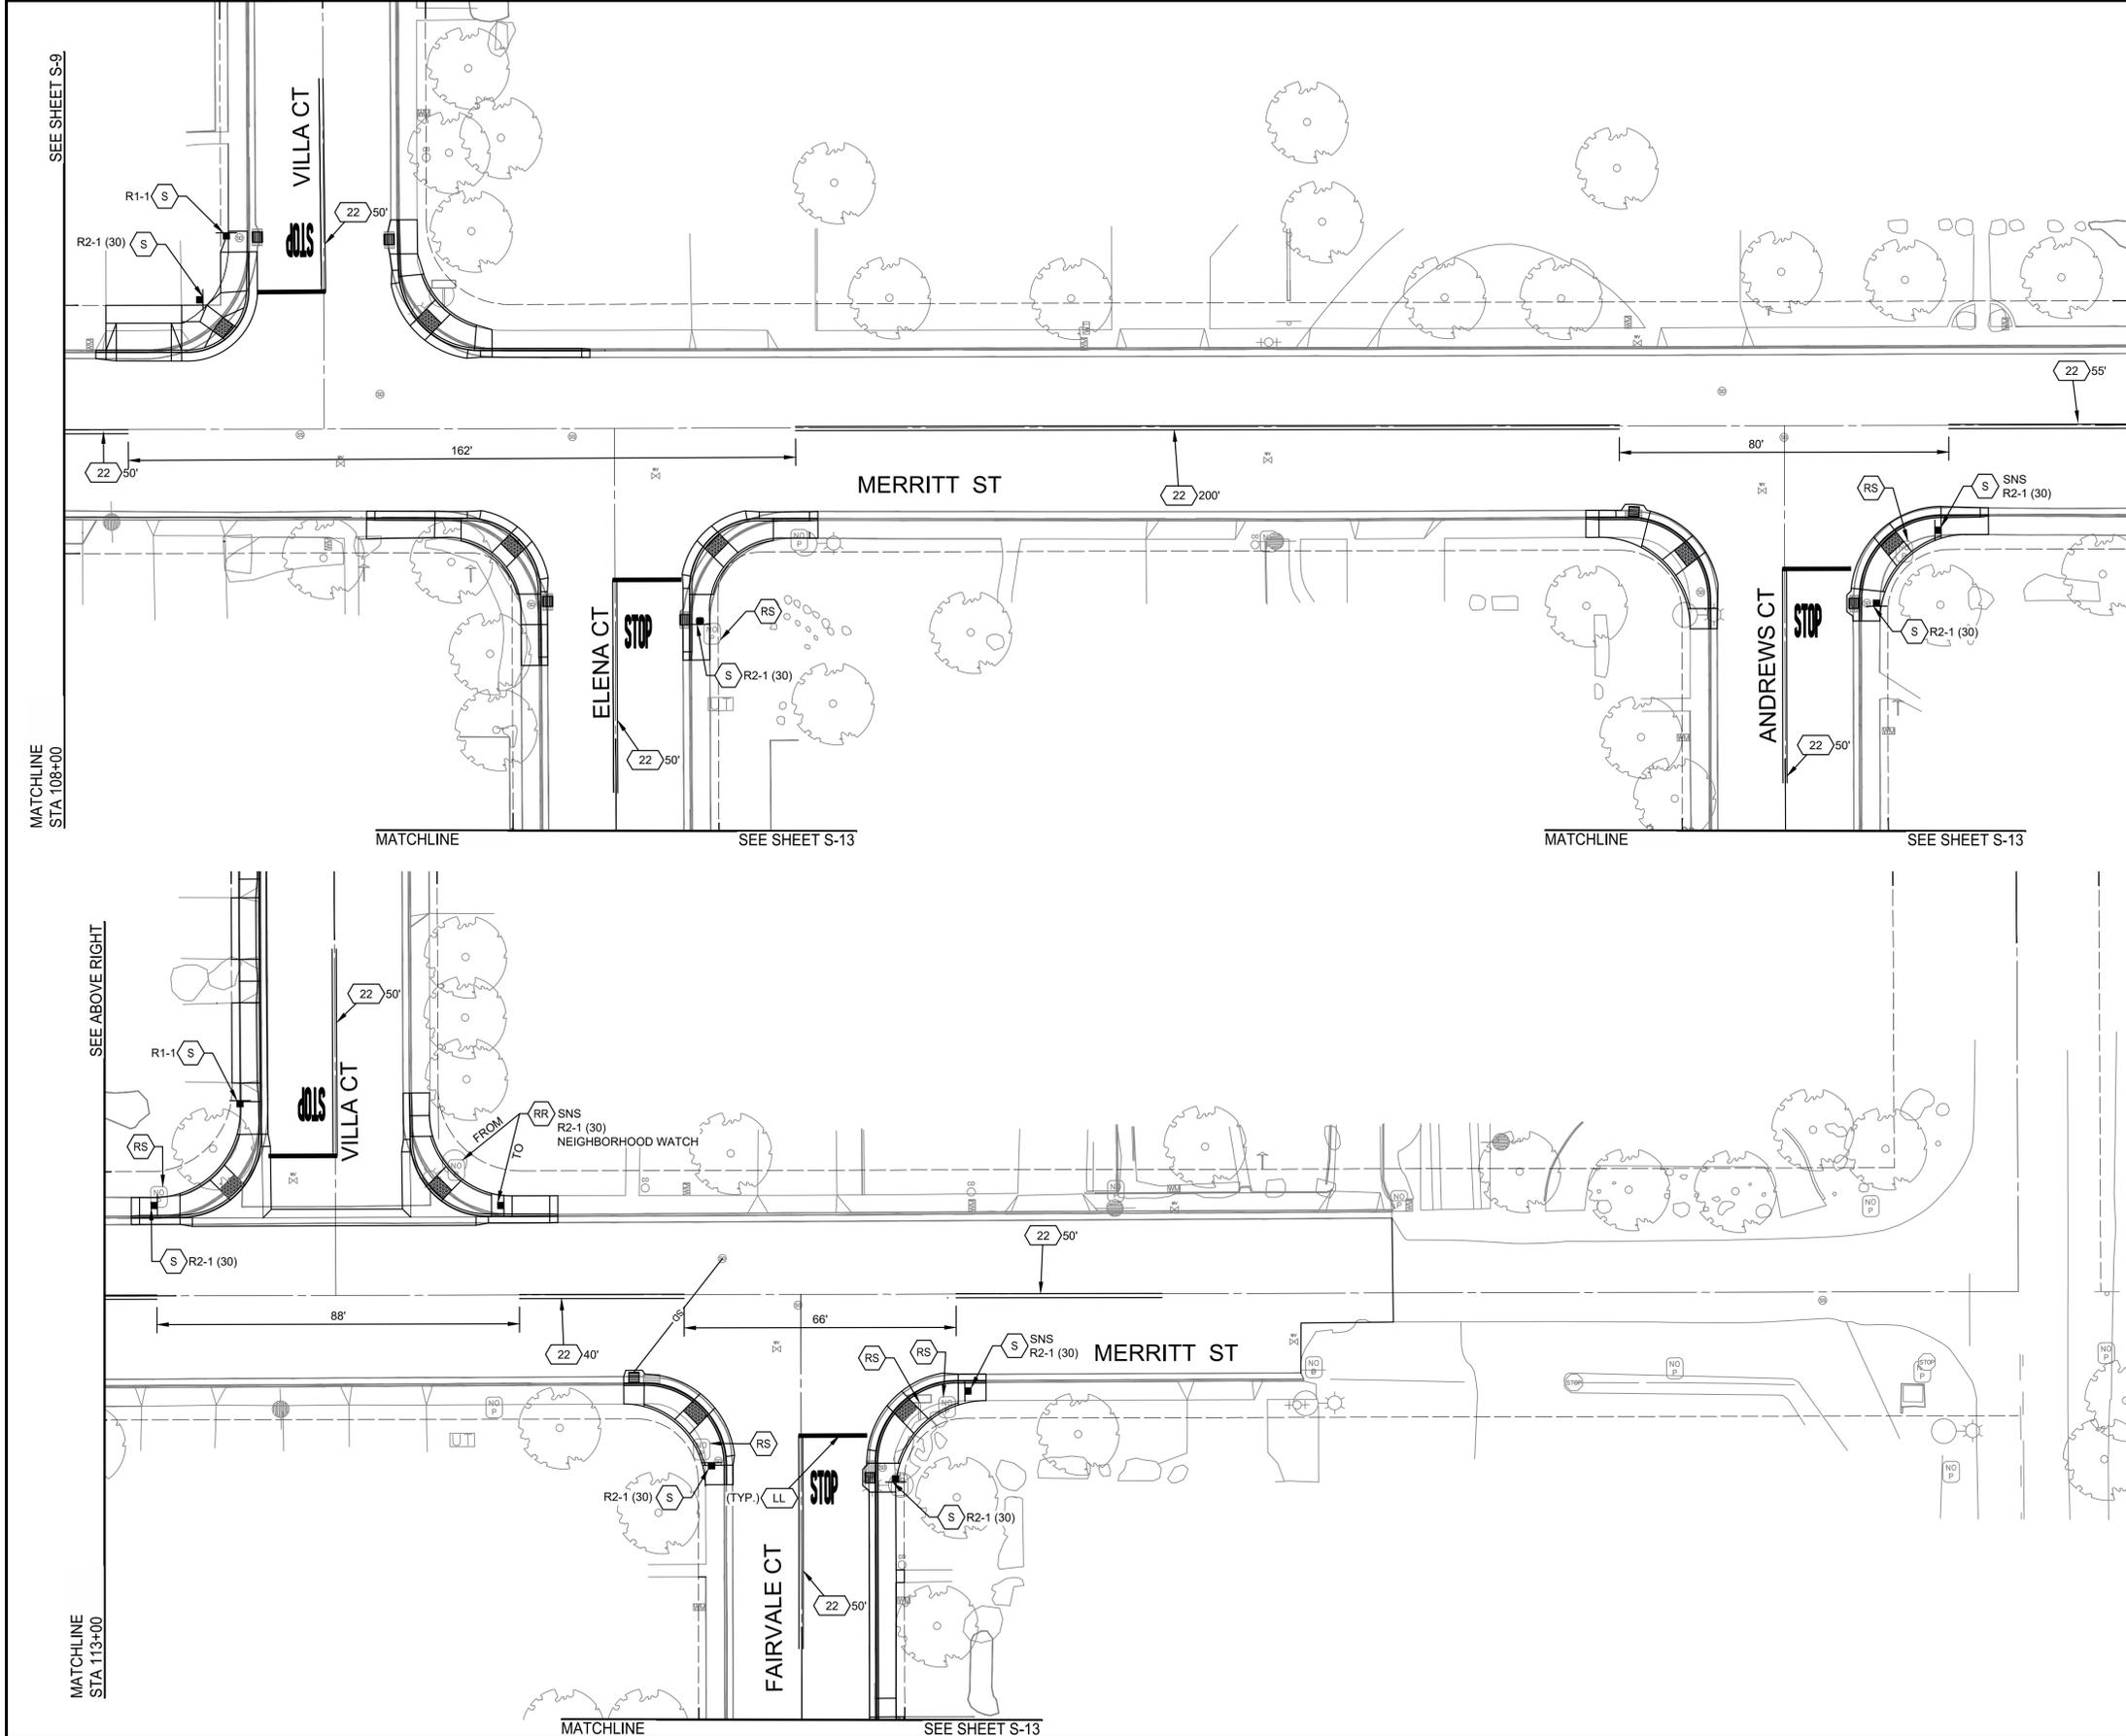


- LEGEND**
- CROSSWALK PER CITY OF TURLOCK STD C-17 ON DETAIL SHEET D2 AND LOCATION PER DETAIL A AND B ON SHEET D5.
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  - FURNISH AND INSTALL ROADSIDE SIGN. SIGN DESIGNATION AS SHOWN ON PLANS.

**NOTES**  
ALL TRAFFIC STRIPING AND PAVEMENT MARKINGS SHALL BE THERMOPLASTIC

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NO.	REVISION	BY	DATE

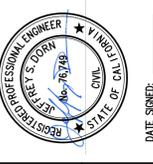


**BID SET**  
1/22/2026

CITY OF TURLOCK  
ROADS PROGRAM CIP  
CITY PROJECT No. 23-068, PACKAGE 3  
STRIPING

MERRITT ST STA 108+00 - 117+00


**PROVOST & PRITCHARD**  
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TURLOCK, CA 95259  
PHONE (559) 449-2700  
FAX (559) 449-2715  
www.provostandpritchard.com

DESIGN ENGINEER: JEFF DORN LICENSE NO: 76,749	DRAFTED BY: AR	CHECKED BY: JD
DATE: JAN 2026	JOB NO: 229224001	
PROJECT NO: 229224001		
PHASE: 3		
ORIGINAL SCALE SHOWN IS ONE INCH. ADJUST SCALE FOR REDUCED OR ENLARGED PLANS.		
SHEET <b>S-10</b>		
72 OF 78		

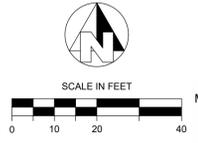

CITY OF TURLOCK  
MUNICIPAL SERVICES DEPARTMENT  
ROADS PROGRAM DIVISION  
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MATCHLINE STA 125+00 SEE SHEET S-12

MATCHLINE STA 132+00 SEE SHEET S-12

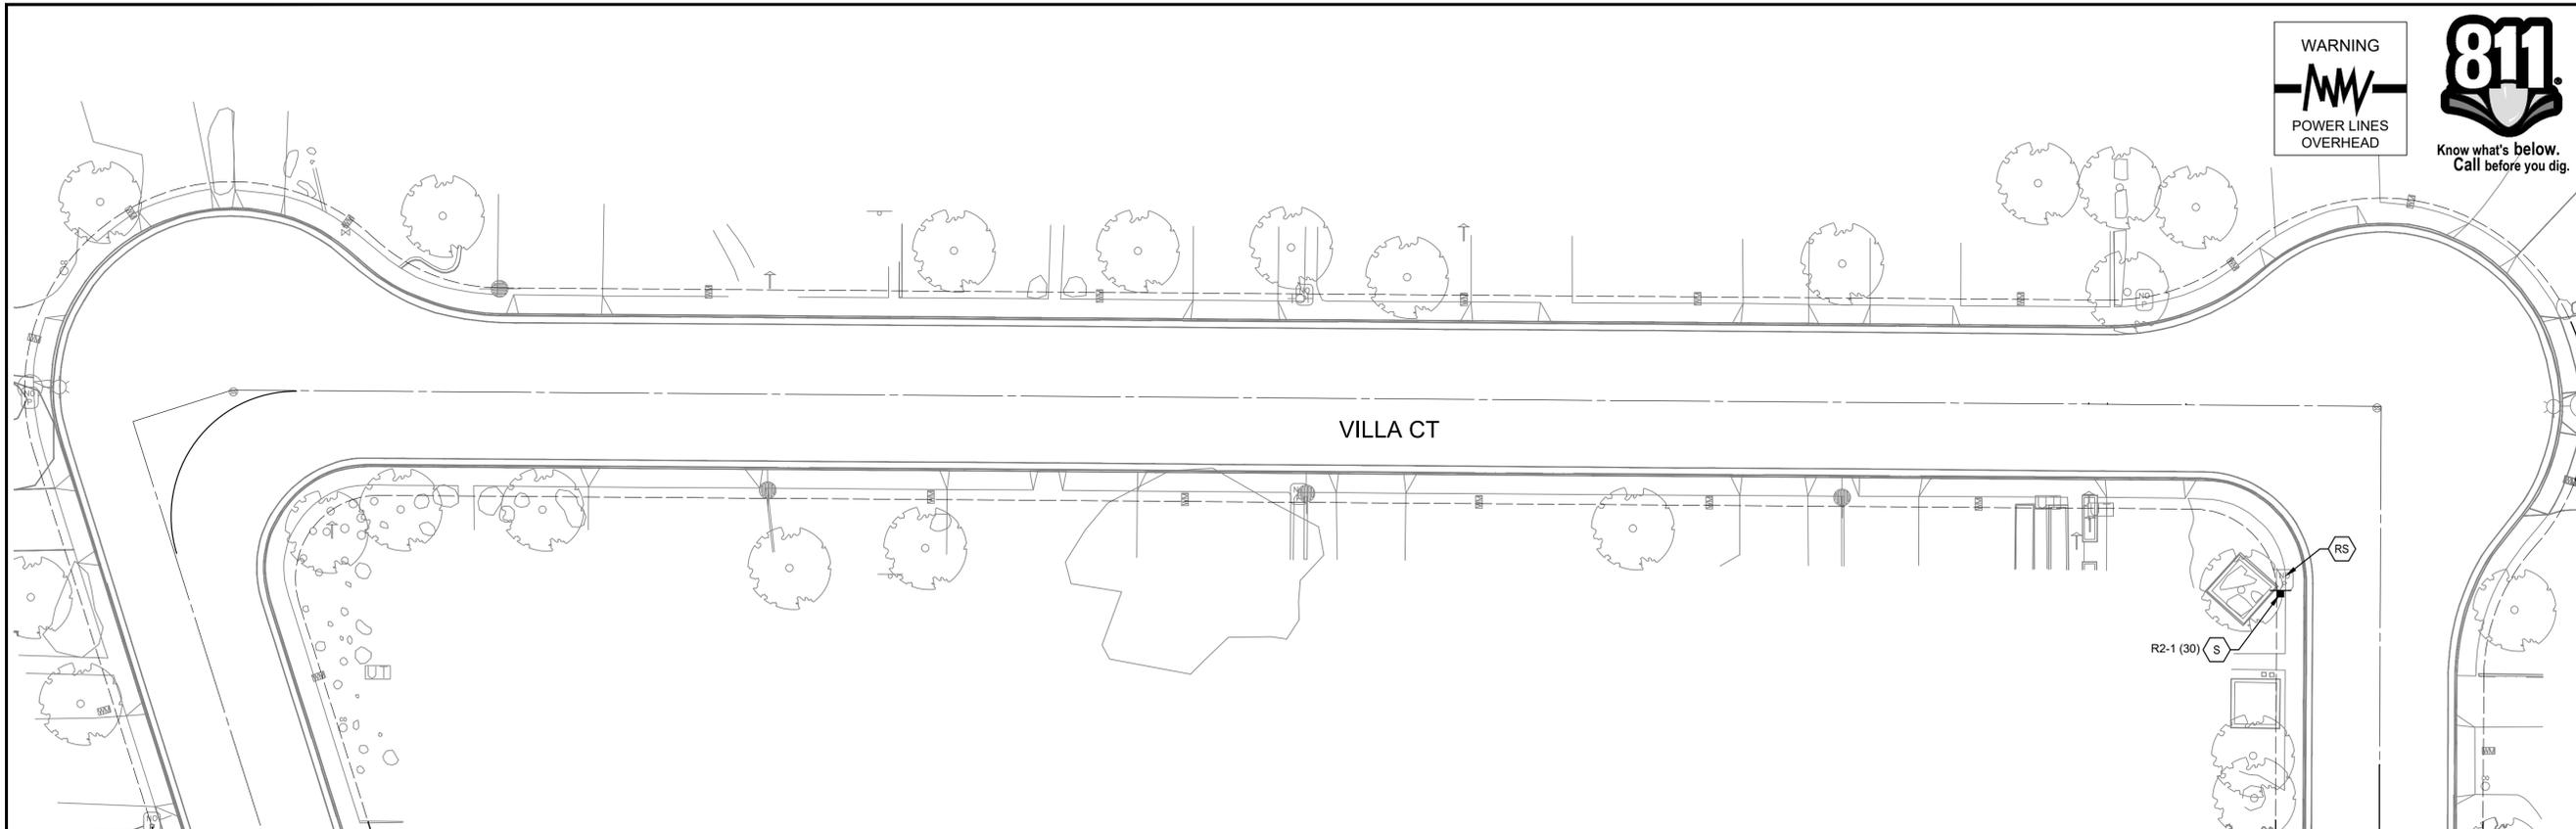**LEGEND**

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NO.	REVISION	BY	DATE
	BID SET		1/22/2026



CITY OF TURLOCK  
ROADS PROGRAM CIP  
CITY PROJECT NO. 23-068, PACKAGE 3  
STRIPING  
VILLA CT STA 125+00 - 132+00

**PROVOST & PRITCHARD**  
425 W FIR AVENUE  
CANTON, CA 95621  
PHONE (530) 449-2700  
FAX (530) 449-2715  
www.provostandpritchard.com

DESIGN ENGINEER:  
JEFF DORN  
LICENSE NO:  
76,749

DRAFTED BY: AR CHECKED BY: JD

DATE: JAN 2026

JOB NO: 229224001


PROJECT NO: 229224001

PHASE: 3




ORIGINAL SCALE SHOWN IS ONE INCH. ADJUST SCALE FOR REDUCED OR ENLARGED PLANS.

SHEET **S-11**

73 OF 78

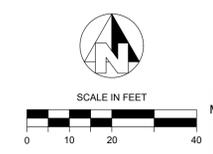


CITY OF TURLOCK  
MUNICIPAL SERVICES DEPARTMENT  
ROADS PROGRAM DIVISION  
156 S. BROADWAY, SUITE 150  
(209) 668-5520

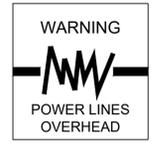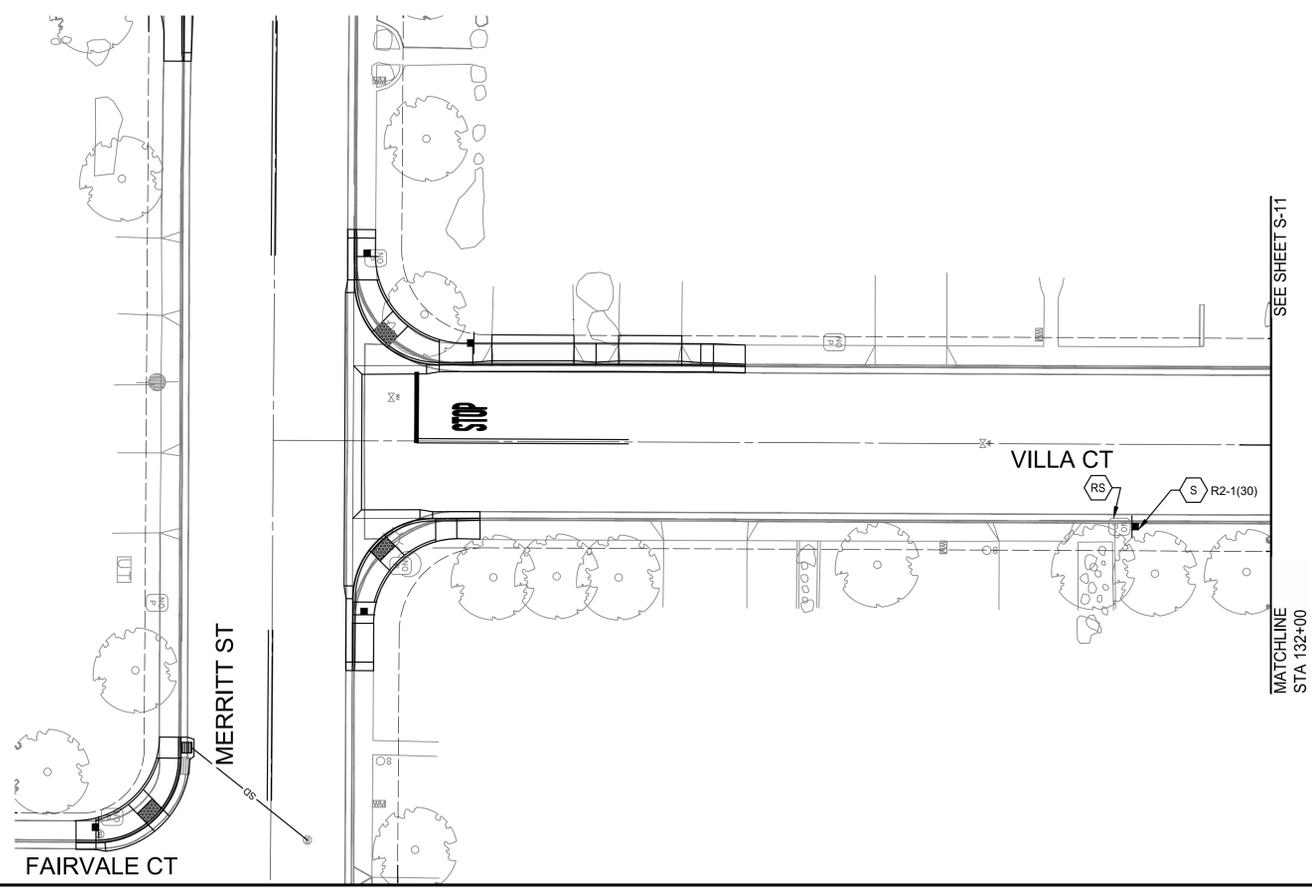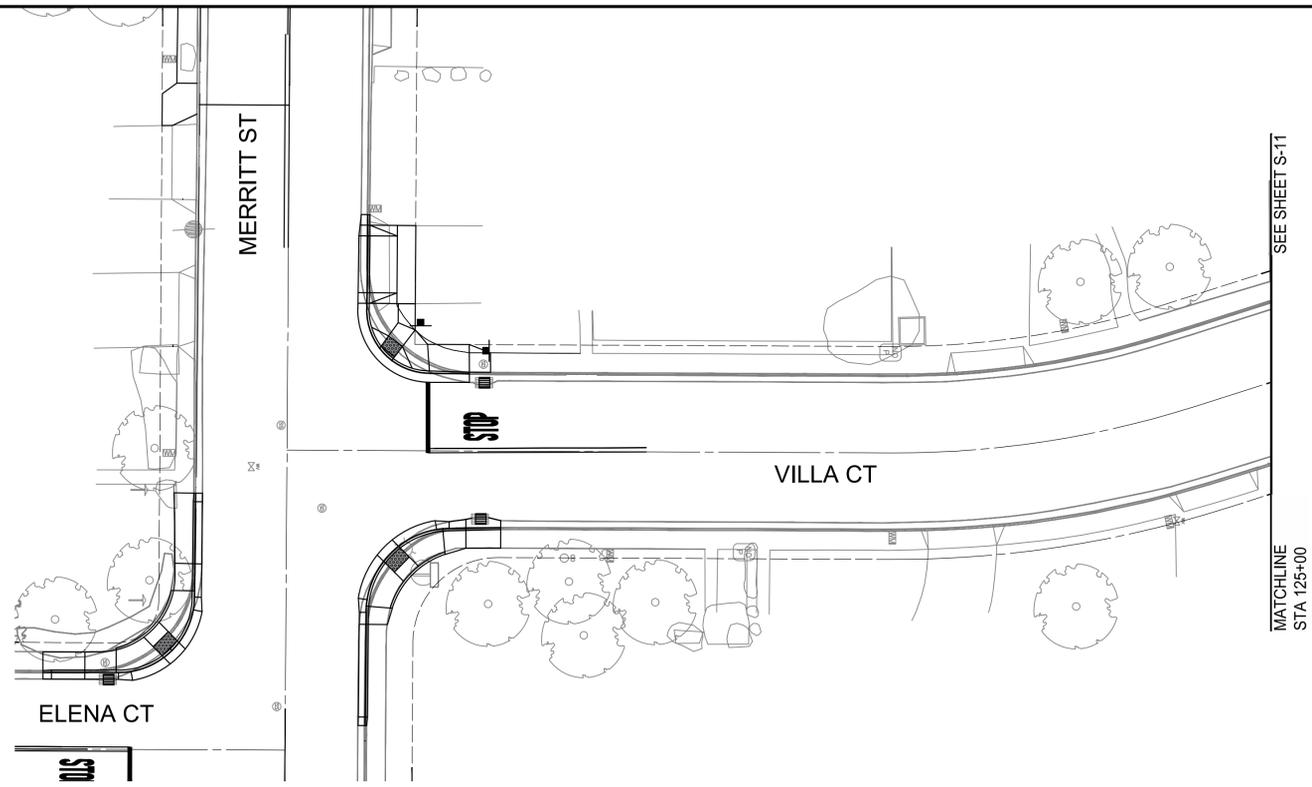

- LEGEND**
- CROSSWALK PER CITY OF TURLOCK STD C-17 ON DETAIL SHEET D2 AND LOCATION PER DETAIL A AND B ON SHEET D5.
  - TRAFFIC LINE DETAIL PER CALTRANS STD. PLANS
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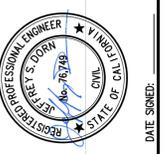
- NOTES**
1. ALL TRAFFIC STRIPING AND PAVEMENT MARKINGS SHALL BE THERMOPLASTIC

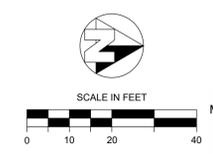

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MUNICIPAL SERVICES DEPARTMENT  
ROADS PROGRAM DIVISION  
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NO.	REVISION	BY	DATE
	BID SET		1/22/2026



CITY OF TURLOCK  
ROADS PROGRAM CIP  
CITY PROJECT No. 23-068, PACKAGE 3  
STRIPING  
VILLA CT STA 120+00 - 124+70 AND  
135+00 TO 139+50

**PROVOST & PRITCHARD**  
425 W FIR AVENUE  
CITY OF TURLOCK, CA 95226  
PHONE (559) 449-2700  
FAX (559) 449-2715  
www.provostandpritchard.com

DESIGN ENGINEER:  
JEFF DORN  
LICENSE NO:  
76,749

DRAFTED BY: AR      CHECKED BY: JD

DATE: JAN 2026  
JOB NO: 229224001  
PROJECT NO: 229224001  
PHASE: 3

ORIGINAL SCALE SHOWN IS ONE INCH. ADJUST SCALE FOR REDUCED OR ENLARGED PLANS.

SHEET **S-12**  
74 OF 78







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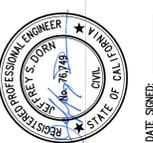
- LEGEND
CROSSWALK PER CITY OF TURLOCK STD C-17
TRAFFIC LINE DETAIL PER CALTRANS STD. PLANS
TYPE IV (L) ARROW PER CALTRANS STD. PLANS
'STOP' MARKING PER CALTRANS STD. PLANS
SHARED ROADWAY BICYCLE MARKING PER CALTRANS STD. PLANS
YIELD LINE MARKING PER CALTRANS STD. PLANS
REMOVE ROADSIDE SIGN
RELOCATE ROADSIDE SIGN AS SHOWN ON PLANS.
FURNISH AND INSTALL ROADSIDE SIGN. SIGN DESIGNATION AS SHOWN ON PLANS.

- NOTES
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CITY OF TURLOCK MUNICIPAL SERVICES DEPARTMENT ROADS PROGRAM DIVISION 156 S. BROADWAY, SUITE 150 (209) 668-5520

BID SET 1/22/2026

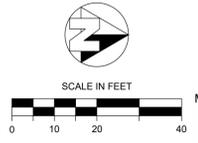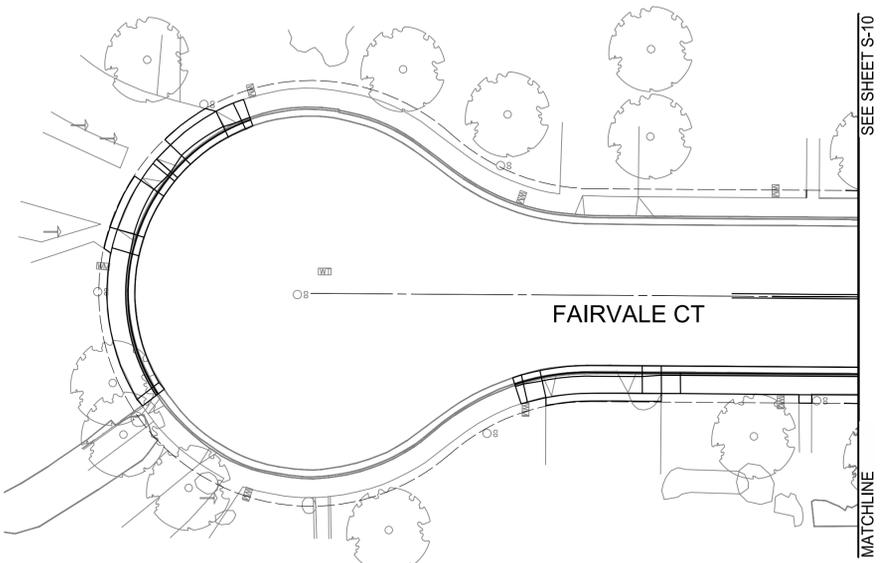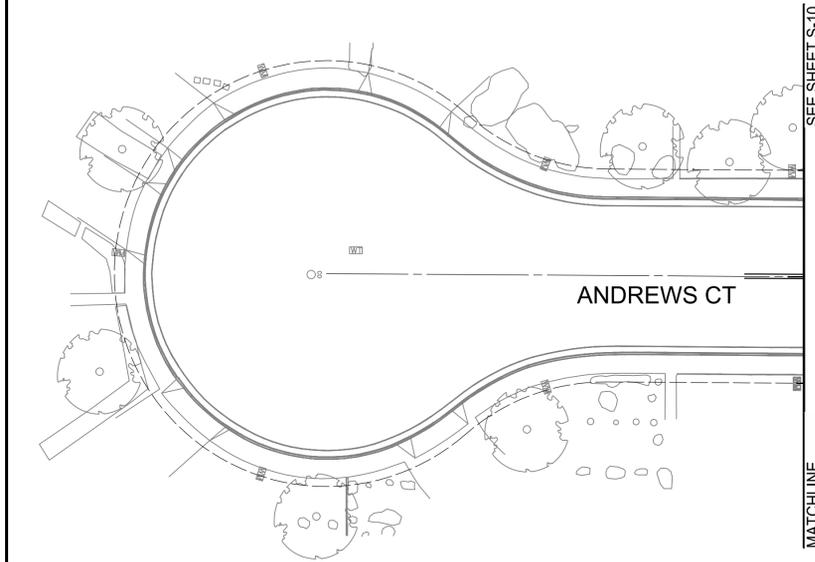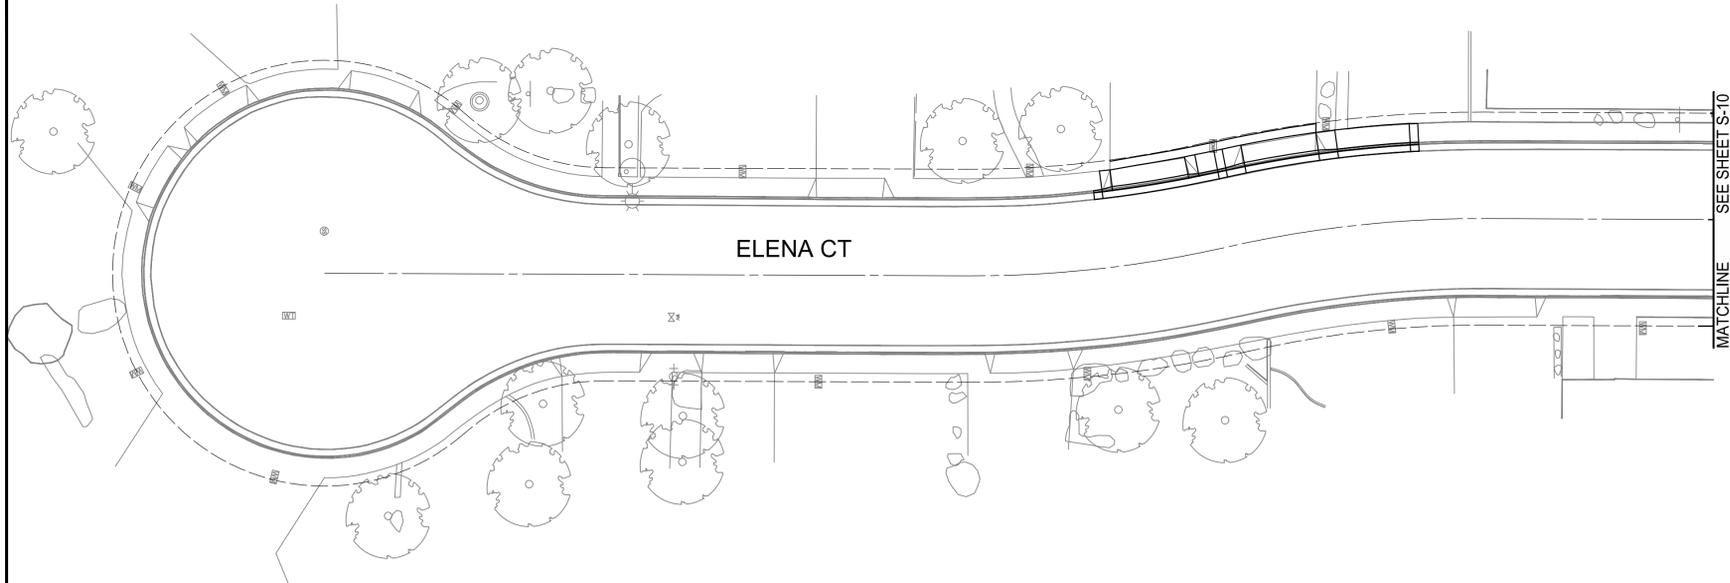

CITY OF TURLOCK ROADS PROGRAM CIP CITY PROJECT No. 23-068, PACKAGE 3 STRIPING ELENA CT ANDREWS CT AND FAIRVALE CT

PROVOST & PRITCHARD 425 W FIR AVENUE CHICO, CA 95926 PHONE (530) 449-2700 FAX (530) 449-2715 www.provostandpritchard.com

DESIGN ENGINEER: JEFF DORN LICENSE NO: 76,749

DRAFTED BY: AR CHECKED BY: JD


DATE: JAN 2026 JOB NO: 229224001

PROJECT NO: 229224001 PHASE: 3

ORIGINAL SCALE SHOWN IS ONE INCH. ADJUST SCALE FOR REDUCED OR ENLARGED PLANS.

SHEET S-13

75 OF 78

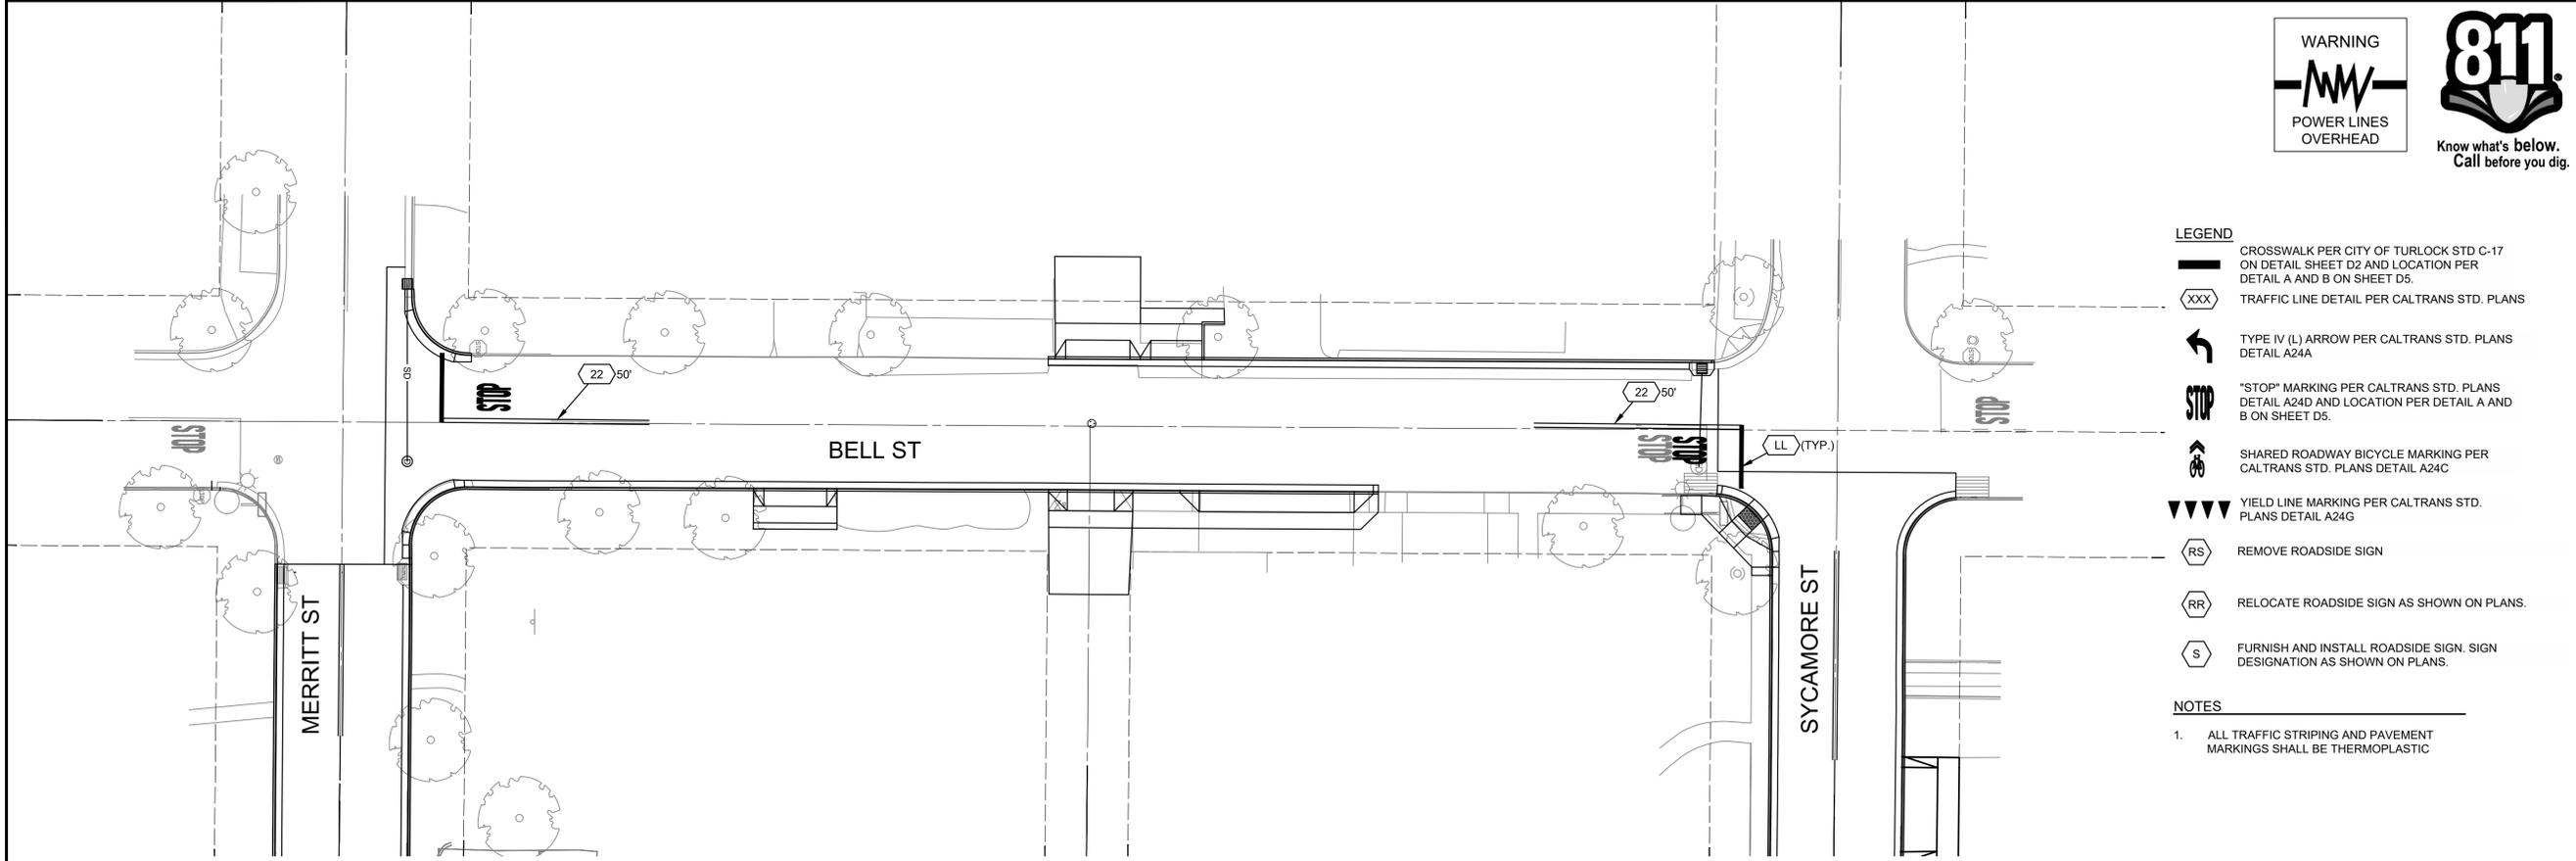


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1/22/2026



CITY OF TURLOCK  
ROADS PROGRAM CIP  
CITY PROJECT No. 23-068, PACKAGE 3  
STRIPING  
BELL ST STA 171+00 - 175+00

**PROVOST & PRITCHARD**  
425 W FIR AVENUE  
CITY OF TURLOCK, CA 95220  
PHONE (559) 449-2700  
FAX (559) 449-2715  
www.provostandpritchard.com

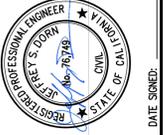DESIGN ENGINEER:  
JEFF DORN  
LICENSE NO:  
76,749


DRAFTED BY: AR      CHECKED BY: JD

DATE: JAN 2026  
JOB NO: 229224001


PROJECT NO: 229224001  
PHASE: 3

0      1"  
INCH ADJUST SCALE FOR  
REDUCED OR ENLARGED PLANS.

SHEET **S-14**  
76 OF 78

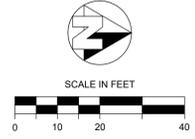


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MUNICIPAL SERVICES DEPARTMENT  
ROADS PROGRAM DIVISION  
156 S. BROADWAY, SUITE 150  
(209) 668-5520

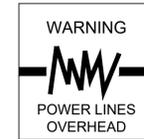

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- NOTES:
1. TRENCH REPAIRS SHALL BE DONE IN ACCORDANCE WITH THE MODIFIED TRENCH EXCAVATION DETAIL AND SHALL COMPLY WITH ALL CITY OF TURLOCK STANDARDS.
2. FOR BIDDING PURPOSES, CONTRACTOR SHALL ASSUME INVERT OF UTILITIES ARE LOCATED A MAXIMUM DEPTH OF 4 FEET BELOW EXISTING PAVEMENT...
3. CONTRACTOR SHALL VERIFY DIMENSIONS AND CALCULATIONS OF ALL GRINDING AREAS BEFORE STARTING THE PROJECT.
4. CONTRACTOR SHALL COMPLY WITH ALL APPLICABLE STATE AND FEDERAL SAFETY AND LABOR CODES.
5. THE CONTRACTOR SHALL BE RESPONSIBLE FOR THE PRESERVATION AND PROTECTION OF ALL UNDERGROUND PIPES, CONDUITS AND OTHER IMPROVEMENTS...
A. UNDERGROUND SERVICE ALERT (USA) AT 1-800-227-2600 TO LOCATE EXACT POSITION OF UNDERGROUND TELEPHONE CABLE, GAS LINES, SEWER LINES AND WATER LINES.
B. TURLOCK IRRIGATION DISTRICT AT (209) 883-8464 TO LOCATE UNDERGROUND ELECTRICAL CONDUIT.
C. CHARTER CABLE AT (209) 656-2124 TO LOCATE UNDERGROUND CABLE T.V.
D. FIRE DEPARTMENT AT (209) 668-5580, POLICE DEPT. AT (209) 668-5550 AND AMBULANCE AT (209) 632-2271.
8. ANY UTILITY TO BE RELOCATED OR REMOVED SHALL BE COORDINATED WITH THE APPROPRIATE UTILITY COMPANY.
9. ONE LANE SHALL REMAIN OPEN AT ALL TIMES. CONTRACTOR SHALL PROVIDE FLAG MEN DURING WORKING HOURS.
10. ALL TRENCHES SHALL BE BACKFILLED AND PAVED WITH TEMPORARY AC AT THE END OF THE WORK DAY.

- NOTES:
1. COMPACTION TESTS SHALL BE APPROVED BY THE CITY BEFORE PAVING.
2. TRENCHES 5 FEET OR MORE IN DEPTH SHALL BE SHORED.
3. MAXIMUM LIFT THICKNESS FOR BEDDING AND BACKFILL SHALL BE 12" BEFORE COMPACTION.
4. TRENCHES WHICH ARE LESS THAN 30" IN DEPTH OR LESS THAN 18" IN WIDTH SHALL BE BACKFILLED WITH TWO SACK CEMENT SLURRY.
5. HMA SHALL BE PG 64-10, TYPE A

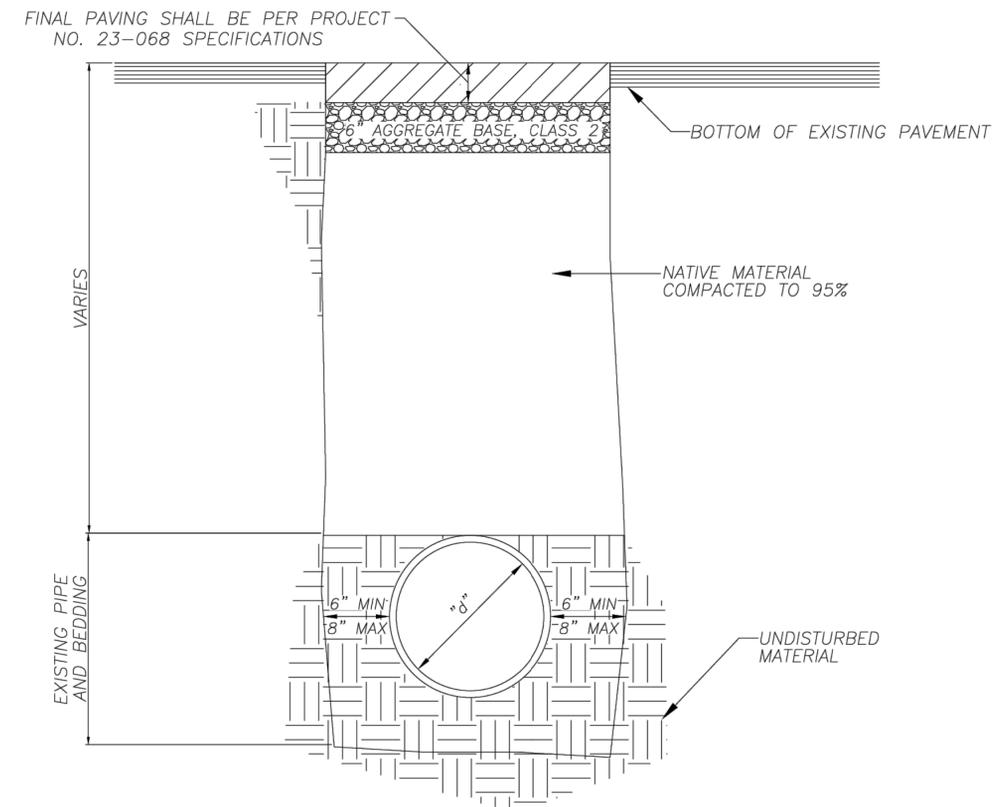
MODIFIED TRENCH EXCAVATION DETAIL

NOT TO SCALE



CITY OF TURLOCK MUNICIPAL SERVICES DEPARTMENT ROADS PROGRAM DIVISION 156 S. BROADWAY, SUITE 150 (209) 668-5520


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CITY OF TURLOCK ROADS PROGRAM CIP CITY PROJECT No. 23-068, PACKAGE 3 TRENCH DETAILS TRENCH DETAILS

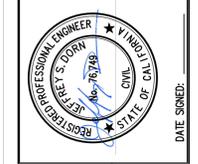
PROVOST & PRITCHARD 425 W. FIR AVENUE #66 TURLOCK, CA 95250 PHONE (209) 449-2700 FAX (209) 449-2715 www.provostandpritchard.com DESIGN ENGINEER: JEFF DORN LICENSE NO: 76,749 DRAFTED BY: AR CHECKED BY: JD DATE: JAN 2026 JOB NO: 229224001 PROJECT NO: 229224001 PHASE: 3 ORIGINAL SCALE SHOWN IS ONE INCH. ADJUST SCALE FOR REDUCED OR ENLARGED PLANS. SHEET TR01 77 OF 78

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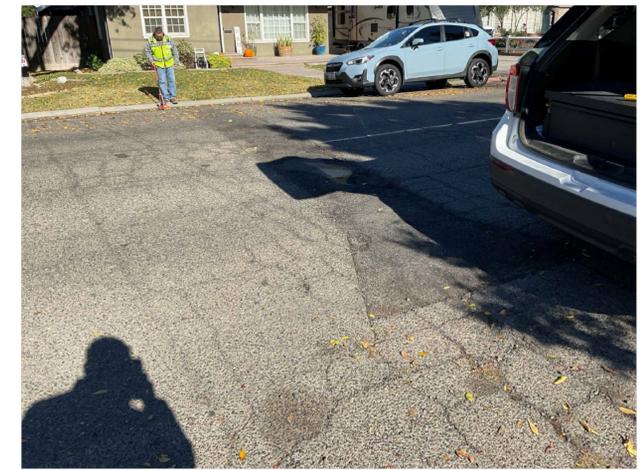
1890 MARSHALL ST

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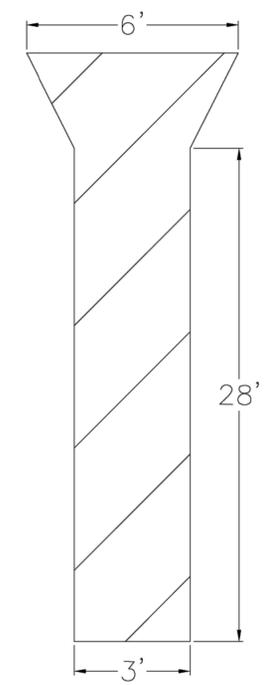
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1895 MARSHALL ST

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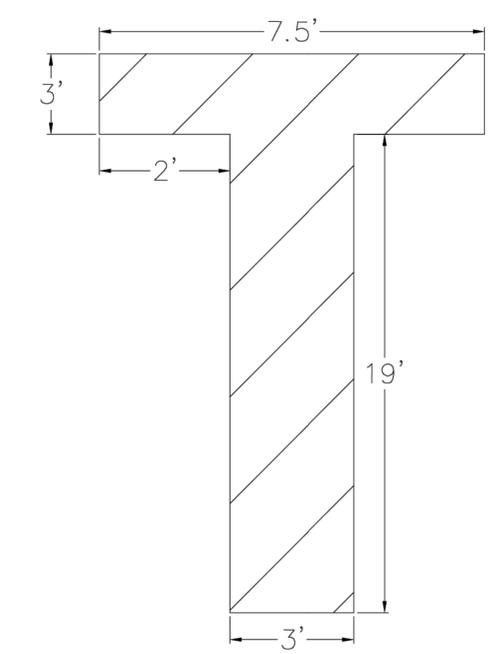
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1899 MERRITT ST
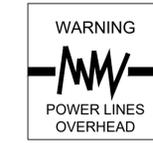
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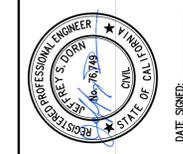


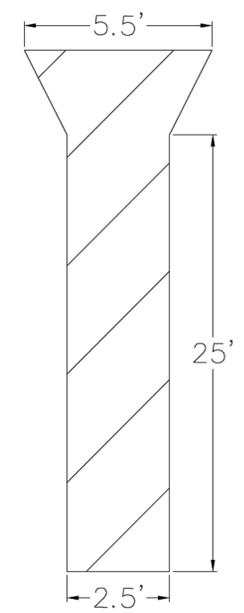1899 MERRITT ST

NOT TO SCALE

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BID SET 1/22/2026	REVISION	BY	DATE
	No.		



CITY OF TURLOCK  
ROADS PROGRAM CIP  
CITY PROJECT No. 23-068, PACKAGE 3  
TRENCH DETAILS  
TRENCH DETAILS

PROVOST & PRITCHARD  
425 W FIR AVENUE  
TURLOCK, CA 95259  
PHONE (559) 449-2700  
FAX (559) 449-2715  
www.provostandpritchard.com

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LICENSE NO:  
76,749


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CHECKED BY: JD

DATE: JAN 2026  
JOB NO: 229224001

PROJECT NO: 229224001  
PHASE: 3

0 1"  
INCH, ADJUST SCALE FOR  
REDUCED OR ENLARGED PLANS.

SHEET TR02  
78 OF 78

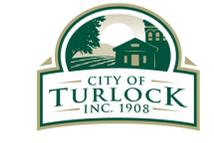

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MUNICIPAL SERVICES DEPARTMENT  
ROADS PROGRAM DIVISION  
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